


THIS INSTRUMENT PREPARED BY: McCORD POINTE SECTION 5 **INSTRUMENT No.:** KRISTOPHER K. EICHHORN **HWC ENGINEERING** CABINET: 135 N. PENNSYLVANIA STREET, SUITE 2800 SECONDARY PLAT INDIANAPOLIS, INDIANA 46204 PHONE: (317) 347-3663 ZONED McCORD POINTE AMENDED PUD ORDINANCE NO. TOWN OF McCORDSVILLE **DEVELOPED BY:** 101017B, AN ORDINANCE AMENDING THE TOWN OF LENNAR HOMES OF INDIANA, INC. McCORDSVILLE ZONING ORDINANCE NO. 121410, AS AMENDED. 9025 NORTH RIVER ROAD, SUITE 100 VERNON TOWNSHIP, HANCOCK COUNTY, INDIANA INDIANAPOLIS, IN 46240 DEVELOPMENT STANDARDS PHONE: (317) 659-3200 AREA "A" (PART OF SECTION 13, TOWNSHIP 17 NORTH, RANGE 5 EAST) MAXIMUM NUMBER OF LOTS 197 MINIMUM LOT AREA 7,500 SQ. FT MINIMUM LOT WIDTH AT BUILDING LINE Curve Table **Assumed North** MINIMUM FRONT YARD SETBACK 25 FEET MINIMUM SIDE YARD SETBACK 5 FEET Length Radius Chord Length Chord Bearing Curve # Delta MINIMUM REAR YARD SETBACK 25 FEET MINIMUM LIVABLE FLOOR AREA 1,500 SF (SINGLE STORY) C-15.62 123.00 5.62 N01°10'06"W 2°37'08" 1.800 SF (MULTI STORY) MIN. GROUND FLOOR LIVING AREA 900 SF (MULTI STORY) C-2 30.18 20.00 27.39 S46°38'03"E 86°26'58" MAXIMUM LOT COVERAGE 45%* MAXIMUM HEIGHT - PRINCIPAL 35 FEET C-3165.58 473.00 164.73 S80°06'46"W 20°03'24" *NOTE: LOTS 61,62,73-77 HAVE MAXIMUM LOT COVERAGE OF 55% PER ORDINANCE 091019 RECORDED C-425.84 25.82 S06°35'47"W 6°38'17" 223.00 POINT OF BEGINNING AS INST. #201909743 IN THE OFFICE OF THE RECORDER OF HANCOCK COUNTY, INDIANA. (SEE SHEET 4) C-5 24.26 22.80 69°30'46" 20.00 S70°21'07"W McCORD POINTE SECTION 1B C-624.26 20.00 22.80 S00°50'21"W 69°30'46" C-7 16.32 227.00 16.32 N33°32'09"E 4°07'10" COVINGTON AVENUE C-8 24.26 20.00 22.80' S31°20'49"W 69°30'46" C-9 24.25 20.00 22.79 S38°06'12"E 69°27'32" Vicinity Map 4.52 3749.85 4.52 N01°36'49"W 0°04'09" C.A.#5-3**Assumed North** C - 1165.38 177.00 65.01 N10°26'25"W 21°09'45" 190 | 189 | 188 | 187 | 186 | 185 / C-12 122.46 150.00' 119.08 N23°14'48"W 46°46'31" CHAMBERS COURT **Scale: 1" = 200'** C - 13195.21 123.00 175.36 N47°56'37"W 90°55'54" CHAMBERS DRIVE 183 McCORD POINTE 46°46'31" C-14 122.46 150.00 119.08 N70°01'19"W McCORD POINTE 182 SECTION 3 62 | 63 | 64 61 SECTION 1B N82°49'41"W C-15 65.38 177.00 65.01 21°09'45" -181 -INST. #201901878 C-16 46.50 50.00 44.84 N81°06'38"E 53°17'08" **FUTURE** 157'47'46 C - 17137.70 50.00 98.13 N46°38'03"W | 73 McCORD POINTE SHEET 2 c.a.#5-1_-SECTION 7 53°17'08" <u>7</u>4 C-18 46.50 50.00 44.84 S05°37'16"W C-19 50.82 500.00 50.80 S87°13'45"W 5°49'25" 75 C-20 124.21 S77°12'03"W 14°13'59" 500.00 123.89' 76 C-21 28.97 20.00 26.50 N38°04'54"E 82°58'56" 87 LANE C-22 9°29'18" 527.00 87.17 S74°49'43"W 86 92 C-23 234.18 223.57 S39°59'59"W 60°10'08" 223.00 93 C-24 116.40 250.00 115.35 S56°44'47"W 26°40'33" 94 C-25 82.56 277.00 82.26 S61°32'44"W 17°04'39" CIMMARON AVE. C-26 32.50 20.00 29.04 S80°26'26"E 93°06'19" SHEET 5 McCORD POINTE 107 C-27 25.96 20.00 24.18' N02°36'56"W 74°22'36" SECTION 2 106 C-28 176.54 40°27'39" 250.00 172.90 S23°10'41"W $\overline{\mathbf{s}}$ **FUTURE** 65.19 S18°31'15"E 30°44'02" C-29 65.98 123.00 McCORD POINTE SECTION 8 C - 30113.22 177.00 111.30 S21°28'44"E 36°39'00" 43°26'16" C - 31113.72 150.00 S24°52'22"E 111.02 SHEET 3 110.02 106.39 N28°46'46"W 51°15'03" C - 32123.00 C - 33134.17 150.00 129.75 N28°46'45"W 51°15'02" 158.32 153.10 51°15'02" C - 34177.00 N28°46'45"W C - 357.15 20°29'14" 20.00 7.11 S83°09'57"E C - 367.15 20°29'14" 20.00 7.11 S76°20'49"W C - 377.15 20.00' 7.11 S44°09'39"E 20°29'14" C - 387.15 20.00 7.11 N64°38'53"W 20°29'14" Kristopher K. Eichhorn STATE OF Professional Surveyor No. 21000230 SEE SHEET 1 FOR CURVE TABLE NO SURVE SHEET 1 OF 6 SEE SHEET 6 FOR LAND DESCRIPTION

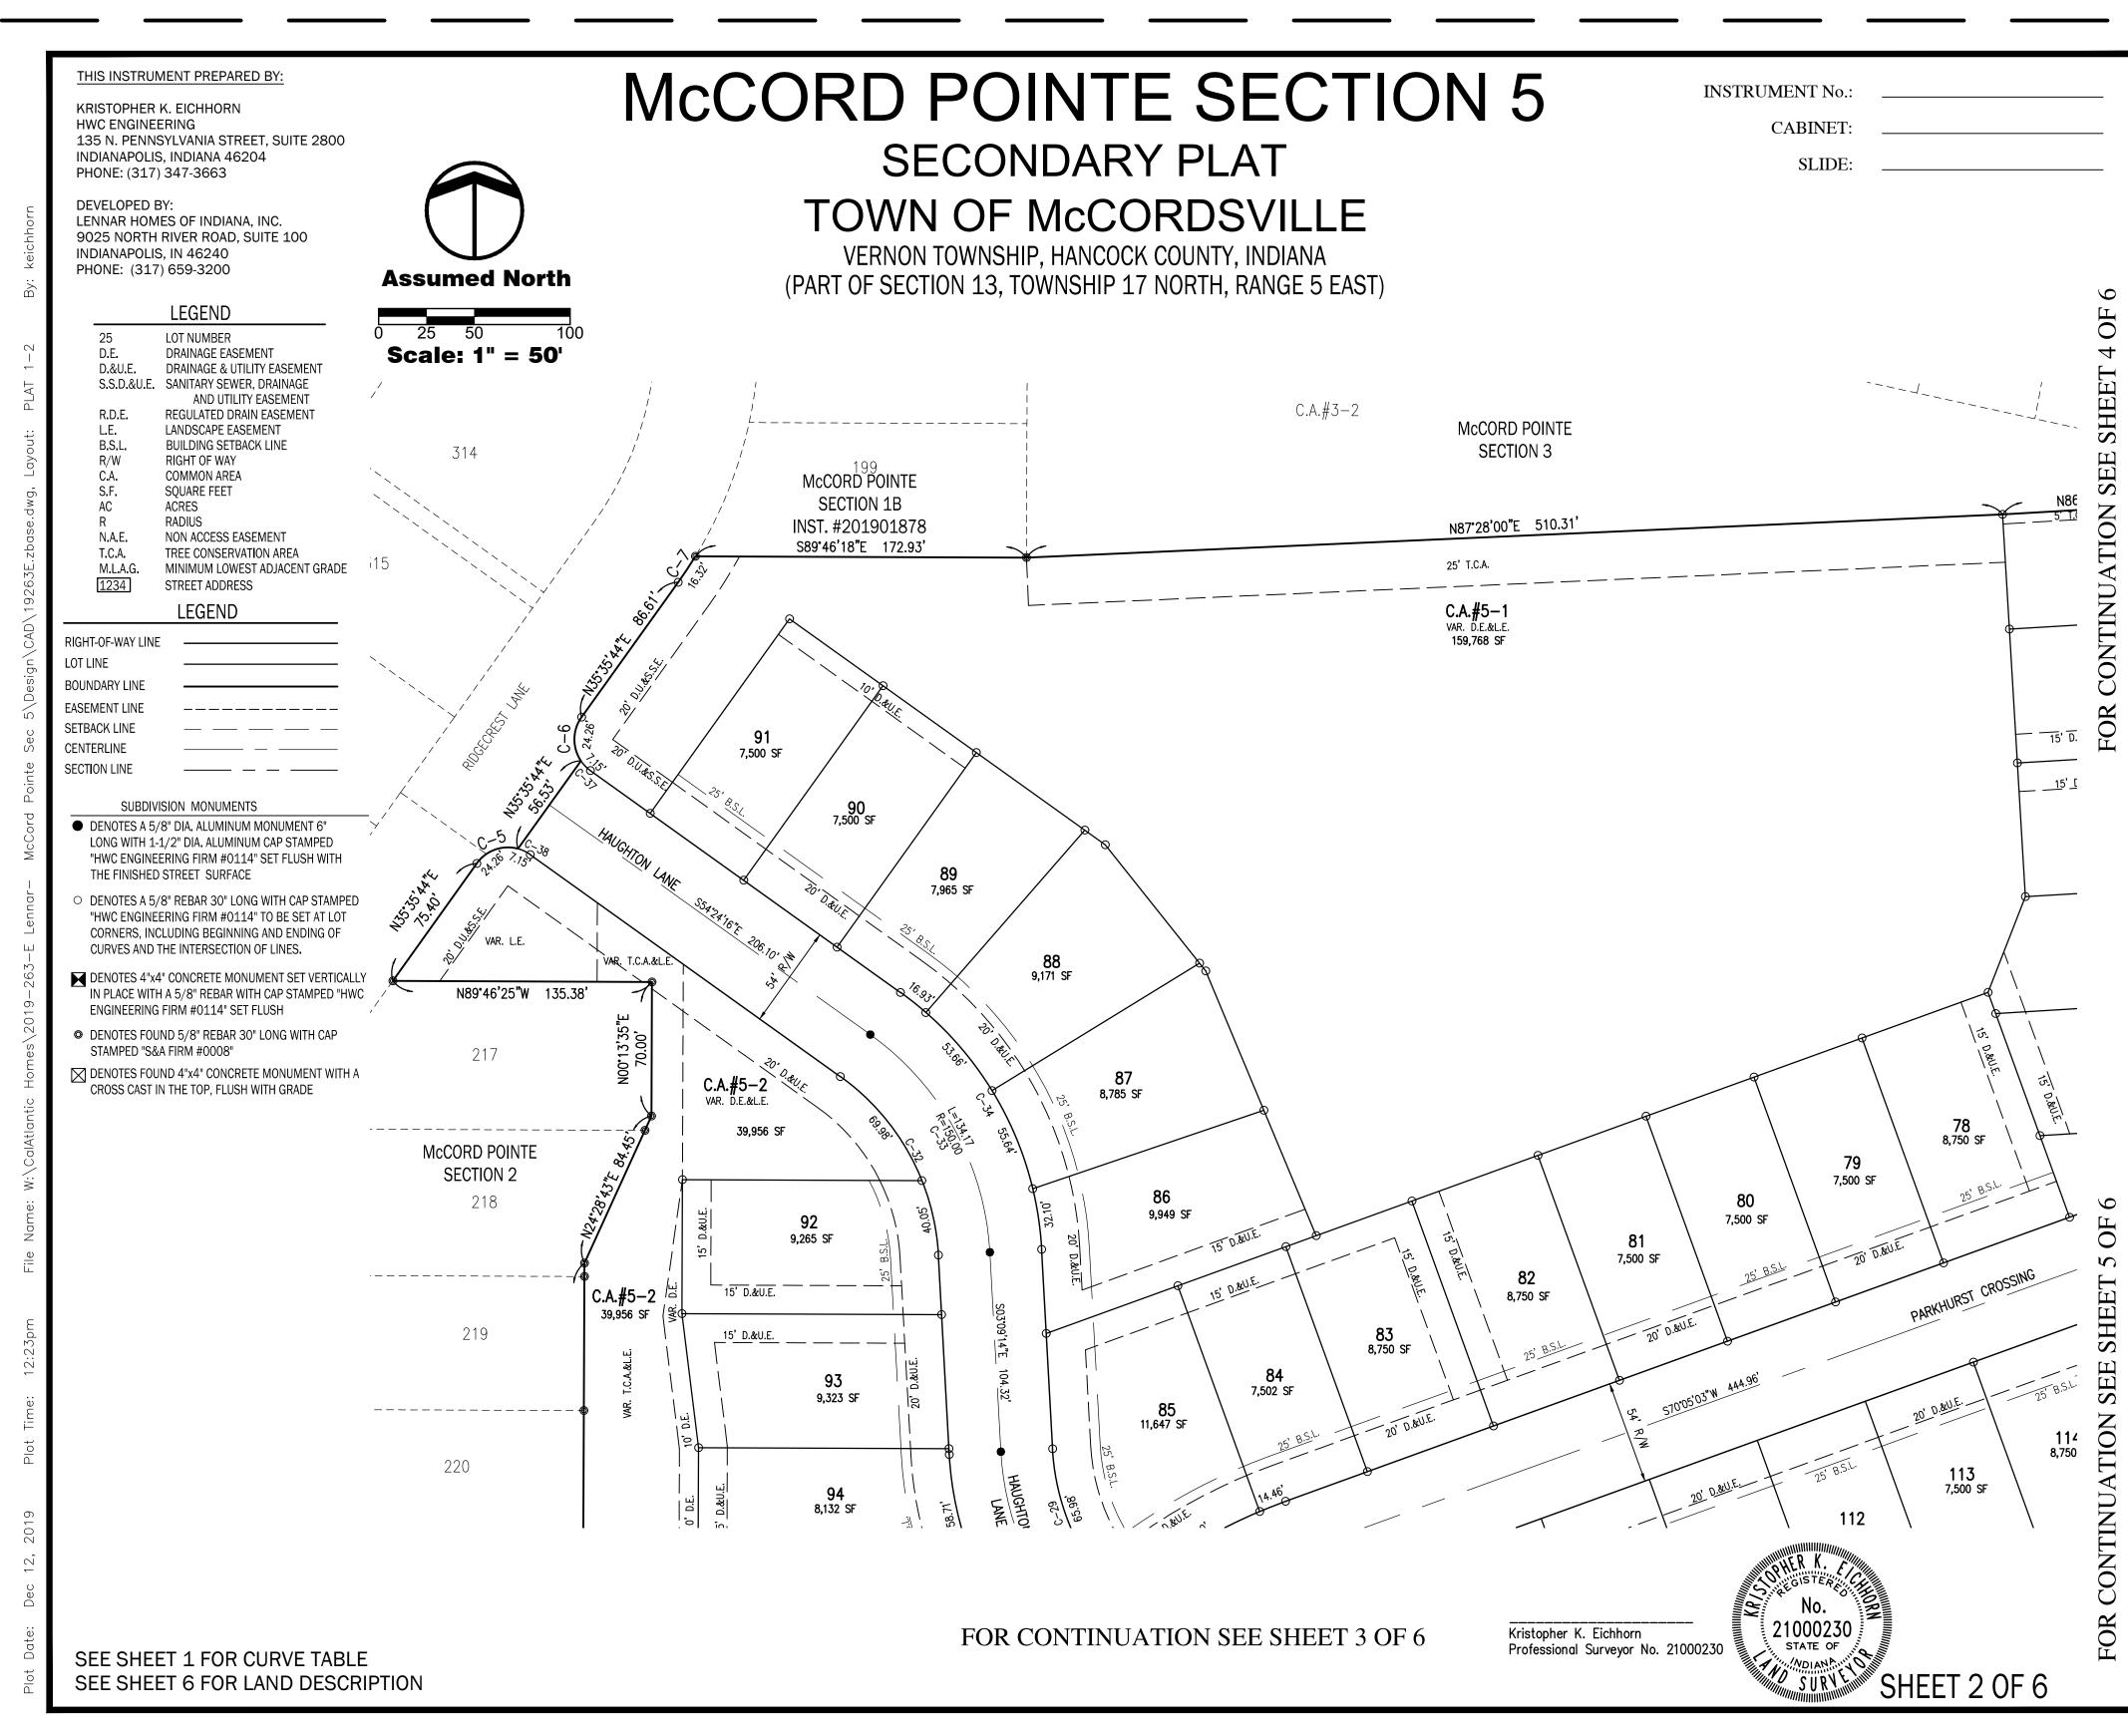

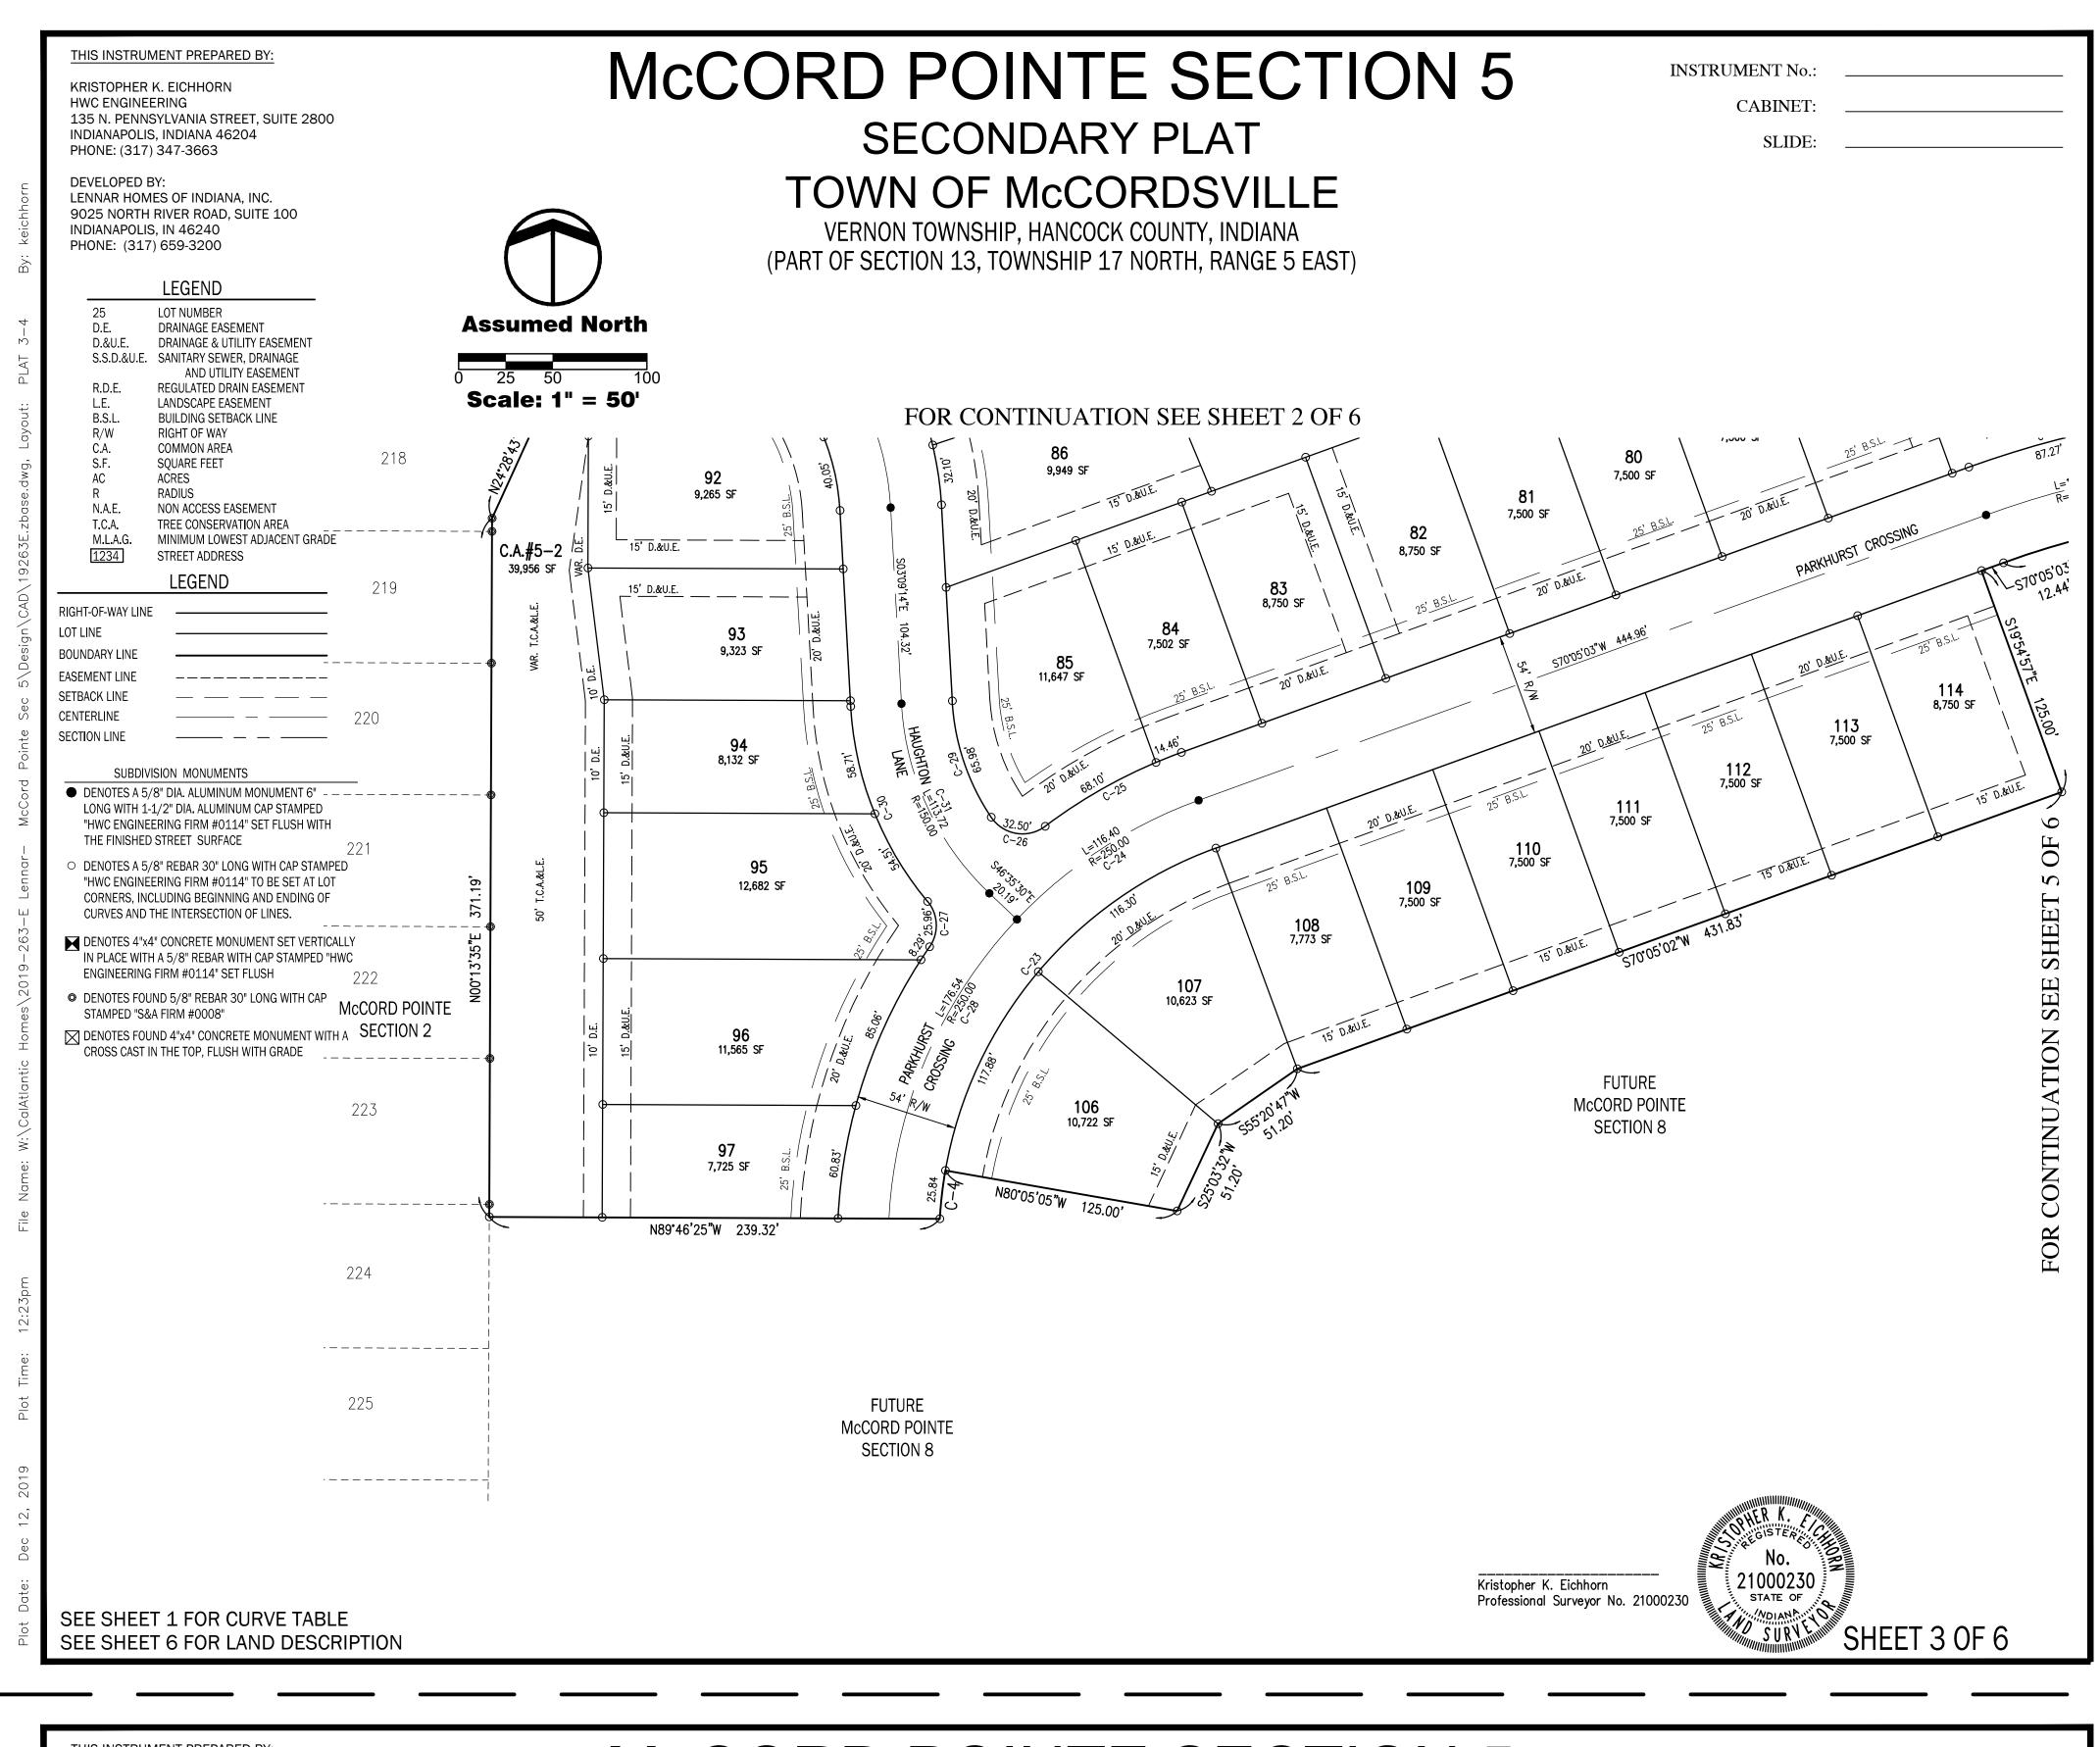

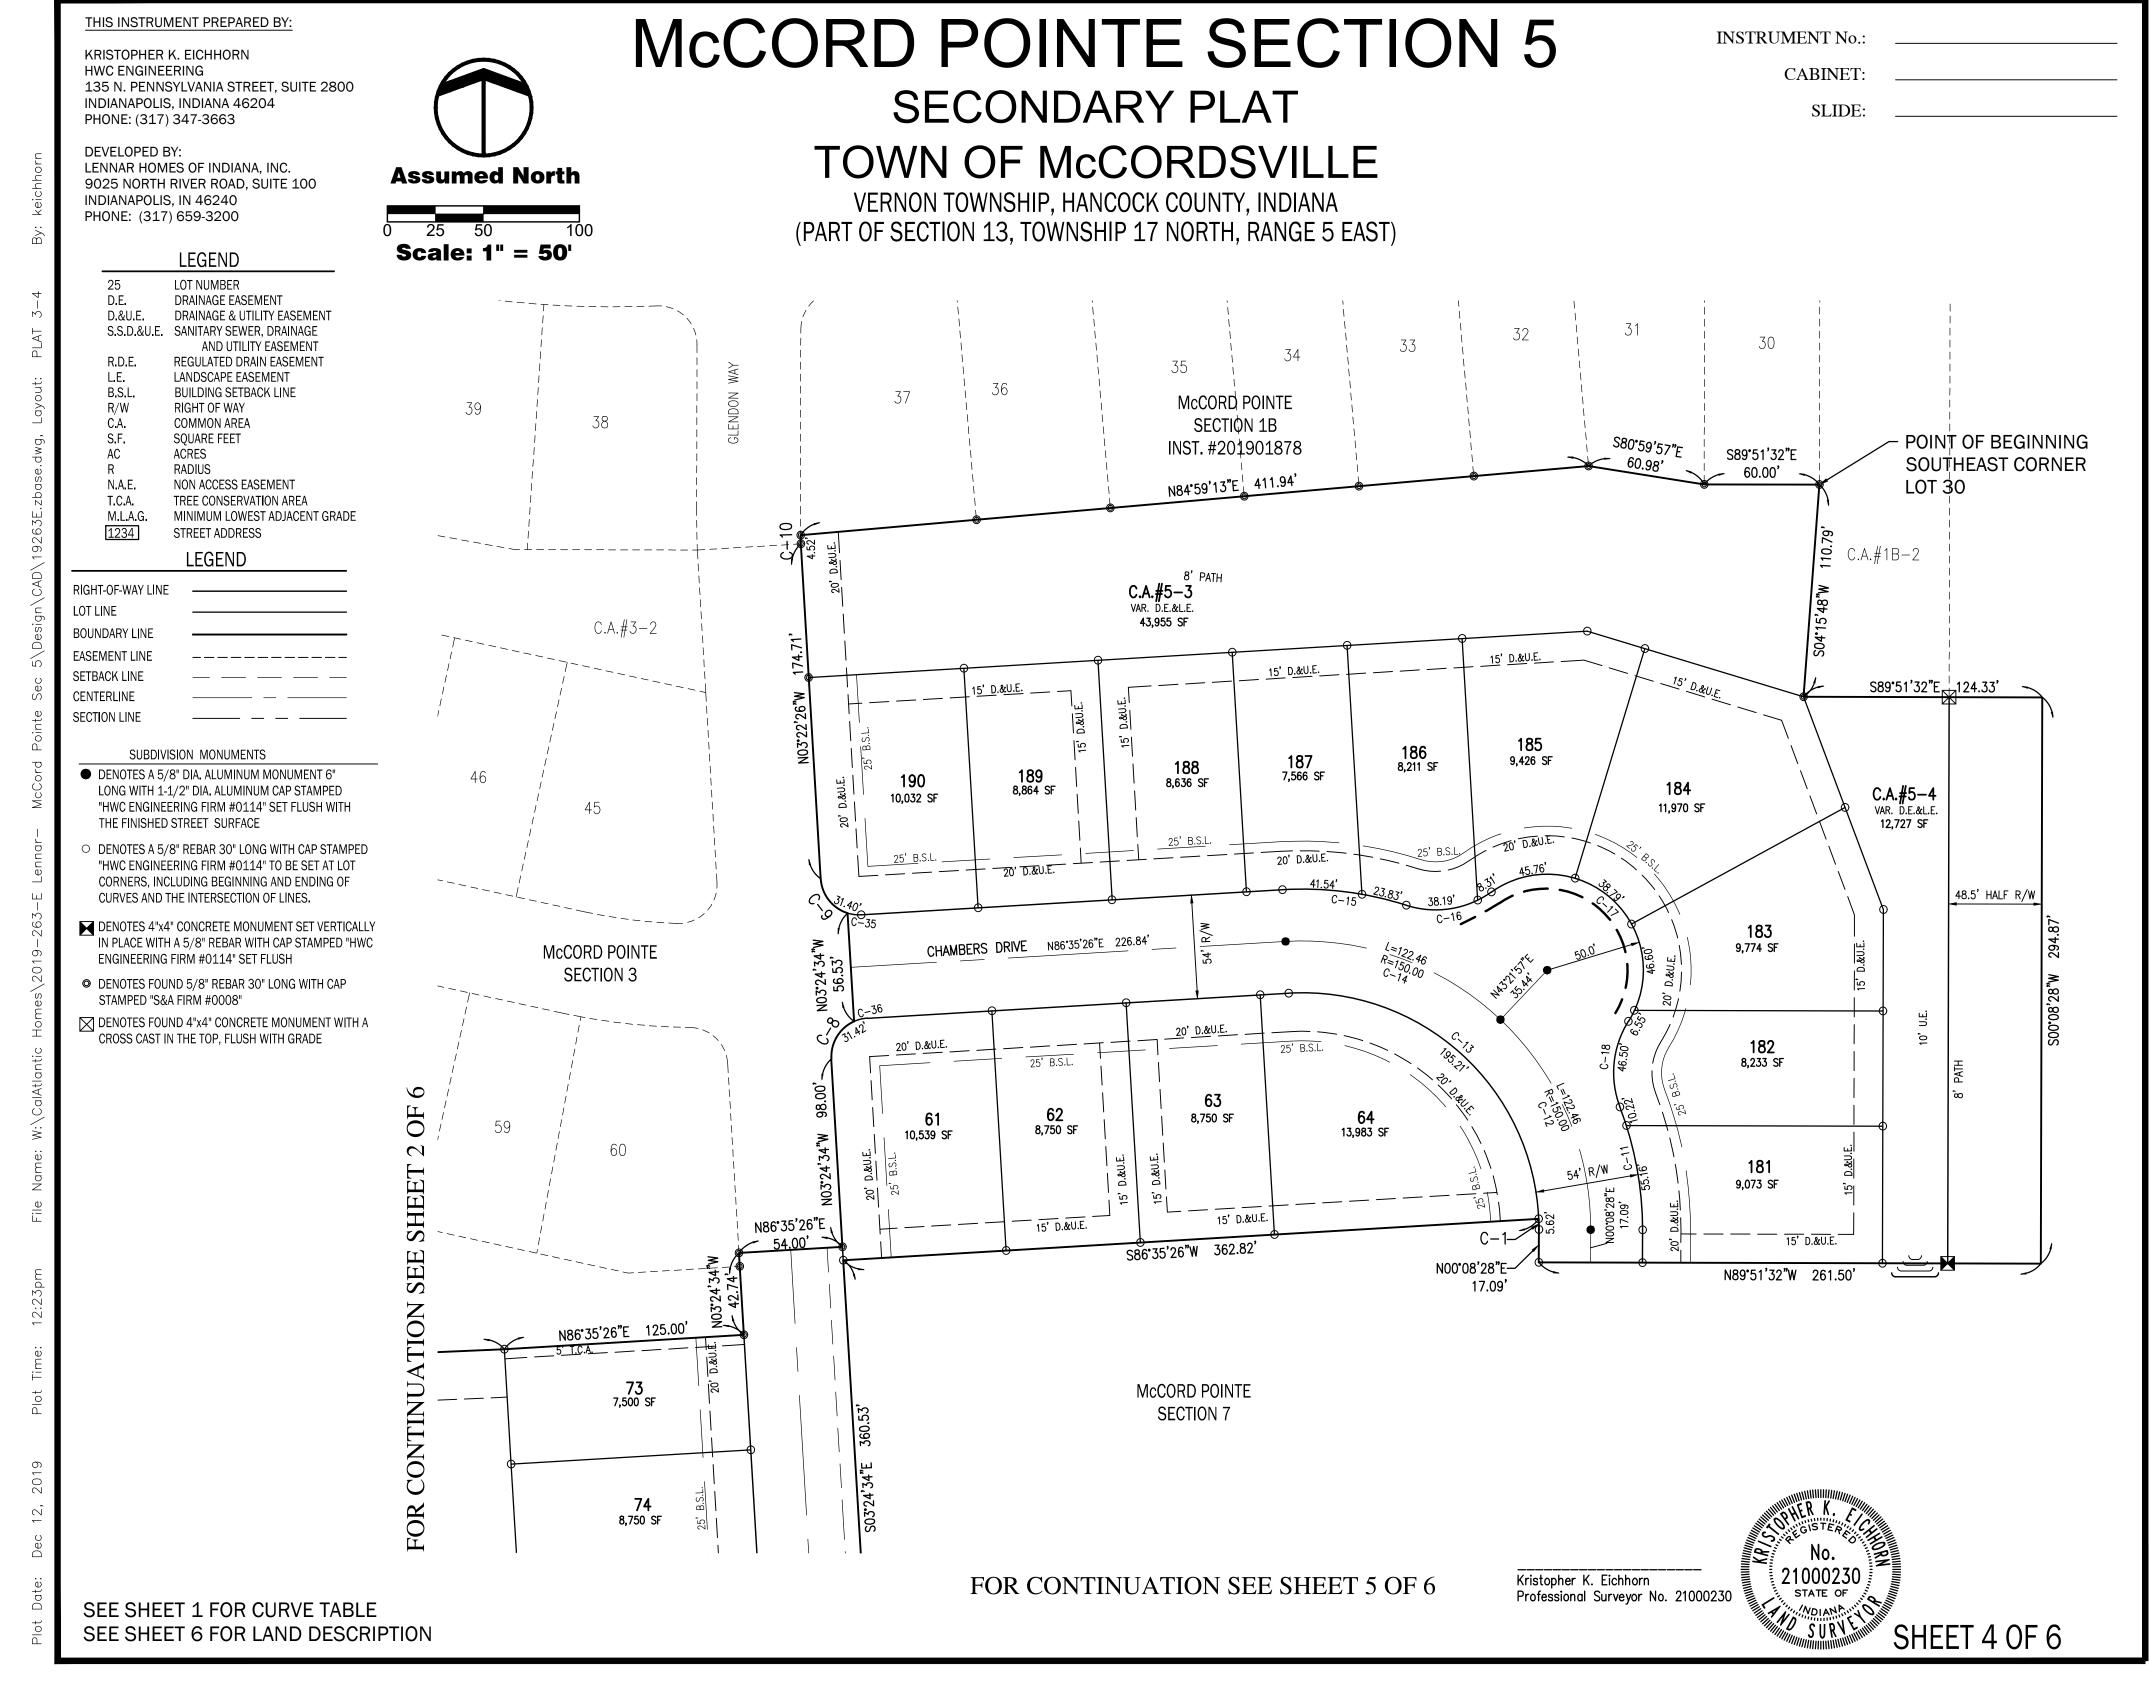

THIS INSTRUMENT PREPARED BY: McCORD POINTE SECTION 5 INSTRUMENT No. KRISTOPHER K. EICHHORN **HWC ENGINEERING** CABINET 135 N. PENNSYLVANIA STREET, SUITE 2800 SECONDARY PLAT INDIANAPOLIS, INDIANA 46204 PHONE: (317) 347-3663 TOWN OF McCORDSVILLE **DEVELOPED BY:** LENNAR HOMES OF INDIANA, INC. **Assumed North** 9025 NORTH RIVER ROAD, SUITE 100 VERNON TOWNSHIP, HANCOCK COUNTY, INDIANA INDIANAPOLIS, IN 46240 PHONE: (317) 659-3200 (PART OF SECTION 13, TOWNSHIP 17 NORTH, RANGE 5 EAST) **Scale: 1" = 50'** LEGEND LOT NUMBER DRAINAGE EASEMENT D.E. D.&U.E. DRAINAGE & UTILITY EASEMENT 15' D.&U.E. S.S.D.&U.E. SANITARY SEWER, DRAINAGE N86°35'26"E 15' D.&U.E. AND UTILITY EASEMENT 54.00 362.82 R.D.E. S86°35'26"W REGULATED DRAIN EASEMENT L.E. LANDSCAPE EASEMENT N00°08'28"I McCORD POINTE N89'51'32"W 261.50' B.S.L. BUILDING SETBACK LINE 17.09 SECTION 3 R/W RIGHT OF WAY **COMMON AREA** C.A. N86°35'26"E 125.00' SQUARE FEET ACRES RADIUS N.A.E. NON ACCESS EASEMENT **73** 7,500 SF T.C.A. TREE CONSERVATION AREA M.L.A.G. MINIMUM LOWEST ADJACENT GRADE 1234 STREET ADDRESS LEGEND RIGHT-OF-WAY LINE LOT LINE 74 8,750 SF **BOUNDARY LINE** EASEMENT LINE SETBACK LINE 15' D.&U.E. CENTERLINE SECTION LINE <u>15' D.&</u>U<u>.E.</u> **FUTURE** SUBDIVISION MONUMENTS McCORD POINTE 75 8,750 SF DENOTES A 5/8" DIA. ALUMINUM MONUMENT 6" SECTION 7 LONG WITH 1-1/2" DIA. ALUMINUM CAP STAMPED 54' R/W "HWC ENGINEERING FIRM #0114" SET FLUSH WITH THE FINISHED STREET SURFACE GLENDON O DENOTES A 5/8" REBAR 30" LONG WITH CAP STAMPED "HWC ENGINEERING FIRM #0114" TO BE SET AT LOT CORNERS, INCLUDING BEGINNING AND ENDING OF 76 CURVES AND THE INTERSECTION OF LINES. 8,281 SF WAY DENOTES 4"x4" CONCRETE MONUMENT SET VERTICALLY IN PLACE WITH A 5/8" REBAR WITH CAP STAMPED "HWC ENGINEERING FIRM #0114" SET FLUSH O DENOTES FOUND 5/8" REBAR 30" LONG WITH CAP STAMPED "S&A FIRM #0008" 8,740 SF DENOTES FOUND 4"x4" CONCRETE MONUMENT WITH A CROSS CAST IN THE TOP, FLUSH WITH GRADE ┌S89**'**51'32**"**E 6.72' 78 8,750 SF C.A.#5-5VAR. D.U.&L.E. 3,610 SF _S70.05'03"W **FUTURE** McCORD POINTE SECTION 9 7,500 SF

THIS INSTRUMENT PREPARED BY:

KRISTOPHER K. EICHHORN 135 N. PENNSYLVANIA STREET, SUITE 2800 INDIANAPOLIS, INDIANA 46204 PHONE: (317) 347-3663

SEE SHEET 1 FOR CURVE TABLE

SEE SHEET 6 FOR LAND DESCRIPTION

DEVELOPED BY: LENNAR HOMES OF INDIANA, INC. 9025 NORTH RIVER ROAD, SUITE 100 INDIANAPOLIS, IN 46240 PHONE: (317) 659-3200

Recorder of Hancock County, Indiana.

McCORD POINTE SECTION 5

SECONDARY PLAT

TOWN OF McCORDSVILLE

VERNON TOWNSHIP, HANCOCK COUNTY, INDIANA

(PART OF SECTION 13, TOWNSHIP 17 NORTH, RANGE 5 EAST)

the undersigned Registered Land Surveyor, hereby certify that the included plat correctly represents—a subdivision of part of the Northeast Quarter of Section 13, Township 17 North, Range 5 East of the Second Principal Meridian, Vernon Township, Hancock County, Indiana being more particularly described as follows:

BEGINNING at the southeast corner of Lot 30 in McCord Pointe, Section 1B, per plat recorded in Plat Cabinet D. Slide 50-52 as Instrument Number 201901878 in the Office of the Recorder of Hancock County, Indiana: thence South 04 degrees 15 minutes 48 seconds West (assumed bearing per said plat) along a west line of said plat a distance of 110.79 feet to a southwest corner thereof; thence South 89 degrees 51 minutes 32 seconds East along a south line of said plat a distance of 124.33 feet to the east line of said quarter section; thence South 00 degrees 08 minutes 28 seconds West along said east line a distance of 294.87 feet; thence North 89 degrees 51 minutes 32 seconds West a distance of 261.50 feet; thence North 00 degrees 08 minutes 28 seconds East a distance of 17.09 feet to the point of curvature of a curve to the left having a radius of 123.00 feet being subtended by a long chord having a bearing of North 01 degrees 10 minutes 06 seconds West and a chord length of 5.62 feet; thence northerly along said curve an arc distance of 5.62 feet; thence South 86 degrees 35 minutes 26 seconds West a distance of 362.82 feet; thence South 03 degrees 24 minutes 34 seconds East a distance of 360.53 feet to the point of curvature of a curve to the left having a radius of 20.00 feet being subtended by a long chord having a bearing of South 46 degrees 38 minutes 03 seconds East and a chord length of 27.39 feet; thence southeasterly along said curve an arc distance of 30.18 feet; thence South 89 degrees 51 minutes 32 seconds East a distance of 6.72 feet; thence South 00 degrees 08 minutes 28 seconds West a distance of 54.00 feet to a point on a non-tangent curve to the left having a radius of 473.00 feet being subtended by a long chord having a bearing of South 80 degrees 06 minutes 46 seconds West and a chord length of 164.73 feet; thence westerly along said curve an arc distance of 165.58 feet; thence South 70 degrees 05 minutes 03 seconds West a distance of 12.44 feet; thence South 19 degrees 54 minutes 57 seconds East a distance of 125.00 feet; thence South 70 degrees 05 minutes 02 seconds West a distance of 431.83 feet; thence South 55 degrees 20 minutes 47 seconds West a distance of 51.20 feet; thence South 25 degrees 03 minutes 32 seconds West a distance of 51.20 feet; thence North 80 degrees 05 minutes 05 seconds West a distance of 125.00 feet to a point on a non-tangent curve to the left having a radius of 223.00 feet being subtended by a long chord having a bearing of South 06 degrees 35 minutes 47 seconds West and a chord length of 25.82 feet; thence southerly along said curve an arc distance of 25.84 feet; thence North 89 degrees 46 minutes 25 seconds West a distance of 239.32 feet to an east line of McCord Pointe, Section 2 and the following five (5) courses are along the easterly and northerly lines of said McCord Pointe, Section 2; (1) thence North 00 degrees 13 minutes 35 seconds East a distance of 371.19 feet; (2) thence North 24 degrees 28 minutes 43 seconds East a distance of 84.45 feet; (3) thence North 00 degrees 13 minutes 35 seconds East a distance of 70.00 feet; (4) thence North 89 degrees 46 minutes 25 seconds West a distance of 135.38 feet; (5) thence North 35 degrees 35 minutes 44 seconds East a distance of 75.40 feet to the point of curvature of a curve to the right having a radius of 20.00 feet being subtended by a long chord having a bearing of North 70 degrees 21 minutes 07 seconds East and a chord length of 22.80 feet; thence easterly along said curve being along an easterly line of said McCord Pointe, Section 2 and also being along an east line of said McCord Pointe, Section 1B an arc distance of 24.26 feet and the following five (5) courses are along the easterly and southerly lines of said McCord Pointe, Section 1B; (1) thence North 35 degrees 35 minutes 44 seconds East a distance of 56.53 feet to a point on a non—tangent curve to the right having a radius of 20.00 feet being subtended by a long chord having a bearing of North 00 degrees 50 minutes 21 seconds East and a chord length of 22.80 feet; (2) thence northerly along said curve an arc distance of 24.26 feet; (3) thence North 35 degrees 35 minutes 44 seconds East a distance of 86.61 feet to the point of curvature of a curve to the left having a radius of 227.00 feet being subtended by a long chord having a bearing of North 33 degrees 32 minutes 09 seconds East and a chord length of 16.32 feet: (4) thence northeasterly along said curve an arc distance of 16.32 feet; (5) thence South 89 degrees 46 minutes 18 seconds East a distance of 172.93 feet to the southeast corner of Lot 199 in said McCord Pointe, Section 1B also being the southwest corner of Common Area #3-2 in McCord Pointe, Section 3 and the following nine (9) courses are along the southerly and easterly lines of said McCord Pointe, Section 3; (1) thence North 87 degrees 28 minutes 00 seconds East a distance of 510.31 feet; (2) thence North 86 degrees 35 minutes 26 seconds East a distance of 125.00 feet; (3) thence North 03 degrees 24 minutes 34 seconds West a distance of 42.74 feet: (4) thence North 86 degrees 35 minutes 26 seconds East a distance of 54.00 feet: (5) thence North 03 degrees 24 minutes 34 seconds West a distance of 98.00 feet to the point of curvature of a curve to the right having a radius of 20.00 feet being subtended by a long chord having a bearing of North 31 degrees 20 minutes 49 seconds East and a chord length of 22.80 feet; (6) thence northeasterly along said curve an arc distance of 24.26 feet; (7) thence North 03 degrees 24 minutes 34 seconds West a distance of 56.53 feet to a point on a non-tangent curve to the right having a radius of 20.00 feet being subtended by a long chord having a bearing of North 38 degrees 06 minutes 12 seconds West and a chord length of 22.79 feet; (8) thence northwesterly along said curve an arc distance of 24.25 feet: (9) thence North 03 degrees 22 minutes 26 seconds West a distance of 174.71 feet to the point of curvature of a curve to the right having a radius of 473.00 feet being subtended by a long chord having a bearing of North 01 degrees 36 minutes 49 seconds West and a chord length of 4.52 feet, said point being a southeast corner of said McCord Pointe, Section 1B and the following four (4) courses are along the easterly and southerly lines of said McCord Pointe, Section 1B; (1) thence northerly along said curve an arc distance of 4.52 feet; (2) thence North 84 degrees 59 minutes 13 seconds East a distance of 411.94 feet: (3) thence South 80 degrees 59 minutes 57 seconds East a distance of 60.98 feet: (4) thence South 89 degrees 51 minutes 32 seconds East a distance of 60.00 feet to the POINT OF BEGINNING, containing 19.160 acres, more or less.

This subdivision consists of 48 lots numbered 61-64, 73-97, 106-114, 181-190, all inclusive, and 5 Common Areas denoted as CA #5-1, CA #5-2, CA #5-3, CA#5-4 and CA #5-5.

Cross-Reference is hereby made to a survey plat prepared by Stoeppelwerth & Associates, Inc. in accordance with Title 865, Article 1, Chapter 12 of the Indiana Administrative Code, recorded as Instrument Number 201805353 in the Office of the

I further certify that I am a Registered Land Surveyor, licensed in compliance with the laws of the State of Indiana and that the within plat represents a subdivision of the lands surveyed within the cross referenced survey plat, and that to the best of my knowledge and belief there has been no change from the matters of survey revealed by the cross referenced

survey on any lines that are common with the new subdivision.

Witness by signature this ____, 20 ___. 21000230 Kristopher K. Eichhorn Professional Surveyor No. 21000230 STATE OF

ACCEPTANCE OF DEED OF DEDICATION

We, the undersigned Lennar Homes of Indiana, Inc., a Delaware Corporation, owners of the real estate shown and described on the plat herein and recorded in the Office of the Recorder of Hancock County, Indiana, do hereby lay off, plat and subdivide, said real estate in accordance with the within plat. We further certify that this plat is made and submitted with our free consent and desires.

This subdivision shall be known and designated as McCord Pointe, Section 5. All streets shown and not heretofore dedicated are hereby dedicated to the public.

Dedicated right-of-way in this subdivision consists of 3.031 acres and 2,430 lineal feel as measured along the centerline of the

Title to the foregoing real estate is subject to a certain Declaration of Covenants, Conditions and Restrictions for McCord Pointe, recorded as Instrument Number 201900184 in the Office of the Recorder of Hancock County, Indiana, and amended by Instrument Number 201903207 in said Recorder's Office, as the same may be amended or supplemented. Such Declaration and the Covenants and Restrictions set forth therein run with the land described hereon and are incorporated herein by reference. Each owner of a lot depicted on this plat shall take title to such lot subject to the terms and conditions of the Declaration.

Front yard building setback lines are hereby established as shown on this plat, between which lines and the property lines of the street, there shall be erected or maintained no building or structure.

A perpetual utility easement is hereby granted to any private or public utility or municipal department, their successors and assigns, within the area shown on the plat and marked "Utility Easement", to install, lay, construct, renew, operate, maintain and remove conduits, cables, pipes, poles and wires, overhead and underground, with all necessary braces, guys, anchors and other equipment for the purpose of serving the subdivision and other property with telephone, internet, cable tv, electric and gas, sewer and water service as a part of the respective utility systems; also is granted (subject to the prior rights of the public therein or other governing codes and ordinances) the right to use the streets and lots with aerial service wires to serve adjacent lots and street lights, the right to cut down and remove or trim and keep trimmed any trees or shrubs that interfere or threaten to interfere with any of the said private or public utility equipment, and the right is hereby granted to enter upon the lots at all times for all of the purposes aforesaid. No permanent structures, fences, or trees shall be placed on said area as shown on the plat and marked "Utility Easement", but same may be used for gardens, shrubs, landscaping and other purposes that do not then or later interfere with the aforesaid user or the rights herein granted.

Tree Conservation Area — A tree conservation area is shown on this plat an abbreviated as "T.C.A.". Within the tree conservation area, no trees with a diameter at breast height ("DBH") in excess of six inches (6") or more (the "Protected Trees") shall be removed unless the tree is damaged, diseased, dead, or is to be removed in order to: (1) comply with the safety requirements of any governmental agency; or (2) to accommodate the installation of drainage utilities, street connections, walking path or other infrastructure. If a Protected Tree is damaged or otherwise removed by the developer or builder, except as permitted to be removed as listed above, then the developer or builder shall reestablish the Protected Tree with a tree or trees of combined equal or greater DBH subject to the availability of space for their healthy growth in the tree conservation area.

In addition, this Deed shall dedicate to the Town of McCordsville, Indiana, any and all sewer infrastructure installed for, by or on behalf of the undersigned, said infrastructure to include but not be limited to the sewer collection system, force main, lift station, or any other component part of the sewer system which serves the subject subdivision.

The right to enforce these provisions by injunction, together with the right to cause the removal, by due process of law, of any structure or part thereof erected, or maintained in violation hereof, is hereby maintained in violation hereof, is hereby dedicated to the Town of McCordsville, Indiana, its assigns or designated agent or representative.

CERTIFICATE OF OWNERSHIP

We, Lennar Homes of Indiana, Inc., do hereby certify that we are the owner of the property described in the above caption and that as such owner it has caused the said above described property to be surveyed and subdivided as shown on the herein drawn plat. as its free and voluntary act and deed.

> Owner/Developer Lennar Homes of Indiana, Inc., a Delaware Corporation

Keith Lash. Vice President Land Acquisition and Development

State of Indiana SS County of Hamilton

My commission expires: ______

Before me, the undersigned, a Notary Public in and for said County and State, personally appeared Keith Lash, Vice President Land Acquisition and Development, Lennar Homes of Indiana, Inc., and acknowledged the execution of this instrument as his voluntary act and deed and affixed his signature thereto.

Witness my signature and seal this _____ day of _____, 20___

Notary Public Printed Name County of Residence: ___

NSTRUMENT No.:	
CABINET:	
SLIDE:	

SHEET 5 OF 6

21000230

DRAINAGE COVENANT

Kristopher K. Eichhorn

Professional Surveyor No. 21000230

Channels, tile drains 8—inch or larger, inlets and outlets of detention and retention ponds, and appurtenances thereto within designated drain easements are extensions of the McCordsville's stormwater drainage system and are the responsibility of the McCordsville Drainage Board and/or the McCordsville Public Works Commissioner. Drainage swales and tile drains less than 8-inch in inside diameter shall be the responsibility of the property owner or homeowner association.

A petition addressed to the McCordsville Drainage Board has been filed in duplicate with the McCordsville Town Engineer, requesting that the subdivision's storm drainage system and its casements be accepted into the regulated drain system. Channels, tile drains 8-inch or larger, inlets and outlets of detention and retention ponds, and appurtenances thereto within designated drain easements are extensions of the McCordsville's stormwater drainage system and are the responsibility of the McCordsville Drainage Board and/or the McCordsville Public Works Commissioner. Drainage swalcs and tile drains less than 8-inch in inside diameter shall be the responsibility of the property owner or homeowner association. The storm drainage system and its easements that are accepted in to the regulated drainage system are delineated on the plat as Regulated Drainage Easements (RDE's). Regulated Drainage Easements are stormwater easements and drainage rights of way that are hereby dedicated to the public and to McCordsville, Indiana, for the sole and exclusive purpose of controlling surface water and/or for installation, operation, and maintenance of storm sewers and tile drains as defined in McCordsville Stonnwater Management Ordinance. These drainage easements are established under authority of the Indiana Drainage Code and the said Board may exercise powers and duties as provided in said code. All other storm drainage easements have not been accepted into the town's system. All drainage improvements performed relative to the conveyance of Stormwater runoff and the perpetual maintenance thereof, with the latter easements, shall be the responsibility of the owner or homeowner association. The McCordsville Drainage Board assumes no responsibility relative to said improvements or the maintenance thereof. This subdivision contains 0 linear feet of open ditches and 0 feet of subsurface drains that will be included in the Town's Regulated Drainage

TOWN APPROVAL

McCORDSVILLE	ADVISORY	PLAN	COMMISSION

This is to certify that this plat has been approved by the McCordsville

the	day of _	 20,	under	the	authority	provided	by:

Signature	Signature	
Printed Name	Printed Name	

REDACTION STATEMENT

I affirm under the penalties for perjury, that I have taken reasonable care to redact each social security number in this document, unless required by law. Kristopher K. Eichhorn

PUD, COVENANTS & OTHER NOTES

The subject tract is zoned McCord Pointe Amended PUD ORDINANCE No. 101017B and Ordinance amending the Town of McCordsville ZONING ORDINANCE No. 121410, as amended.

SHEET 6 OF 6

LOCATION MAP

McCORD POINTE SECTION 5

Lennar Homes of Indiana, Inc.

DEVELOPER:

LENNAR HOMES OF INDIANA, INC. BILL BRYANT 9025 NORTH RIVER ROAD, SUITE 100 INDIANAPOLIS, INDIANA 46240 (317) 450-4634

CIVIL ENGINEER and SURVEYOR:

HWC ENGINEERING 135 N. PENNSYLVANIA ST., SUITE 2800 INDIANAPOLIS, IN 46204 (317) 347-3663

LINEAR FOOTAGE OF	STREETS
CHAMBERS DRIVE	500 LF
GLENDON WAY	414 LF
HAUGHTON LANE	913 LF
PARKHURST CROSSING	579 LF
TOTAL	2,406 LF

COMMON AREAS

C.A.#5-1

C.A.#5-2

C.A.#5-5

3.67 AC

0.92 AC

1.01 AC

0.08 AC

ZONED McCORD POINTE AMENDED PUD ORDINANCE NO. 101017B, AN ORDINANCE AMENDING THE TOWN OF McCORDSVILLE ZONING ORDINANCE NO. 121410. AS AMENDED.

DEVELOPMENT STANDARDS

AREA "A" MAXIMUM NUMBER OF LOTS MINIMUM LOT AREA 7,500 SQ. FT MINIMUM LOT WIDTH AT BUILDING LINE MINIMUM FRONT YARD SETBACK 25 FEET MINIMUM SIDE YARD SETBACK

MINIMUM REAR YARD SETBACK MINIMUM LIVABLE FLOOR AREA 1,500 SF (SINGLE STORY)

MAXIMUM LOT COVERAGE MAXIMUM HEIGHT - PRINCIPAL

*NOTE: LOTS 61,62,73-77 HAVE MAXIMUM LOT COVERAGE OF 55% PER ORDINANCE 091019 RECORDED AS INST. #201909743 IN THE OFFICE OF THE RECORDER OF HANCOCK COUNTY, INDIANA.

1,800 SF (MULTI STORY)

25 FEET


35 FEET

DISTURBED AREA: 1	48
	10.16.40
CTART CONCERNICETON A	19.16 AC
START CONSTRUCTION: N	MARCH 2020
END CONSTRUCTION:	MARCH 2025

PLAN COMMISSION APPROVAL _____ DRAINAGE APPROVAL _____ ADDRESS APPROVAL _____ EROSION CONTROL APPROVAL COUNTY ENGINEER APPROVAL COUNTY SANITARIAN APPROVAL

COUNTY COMMISSIONERS APPROVAL ______

keichhorn@hwcengineering.com

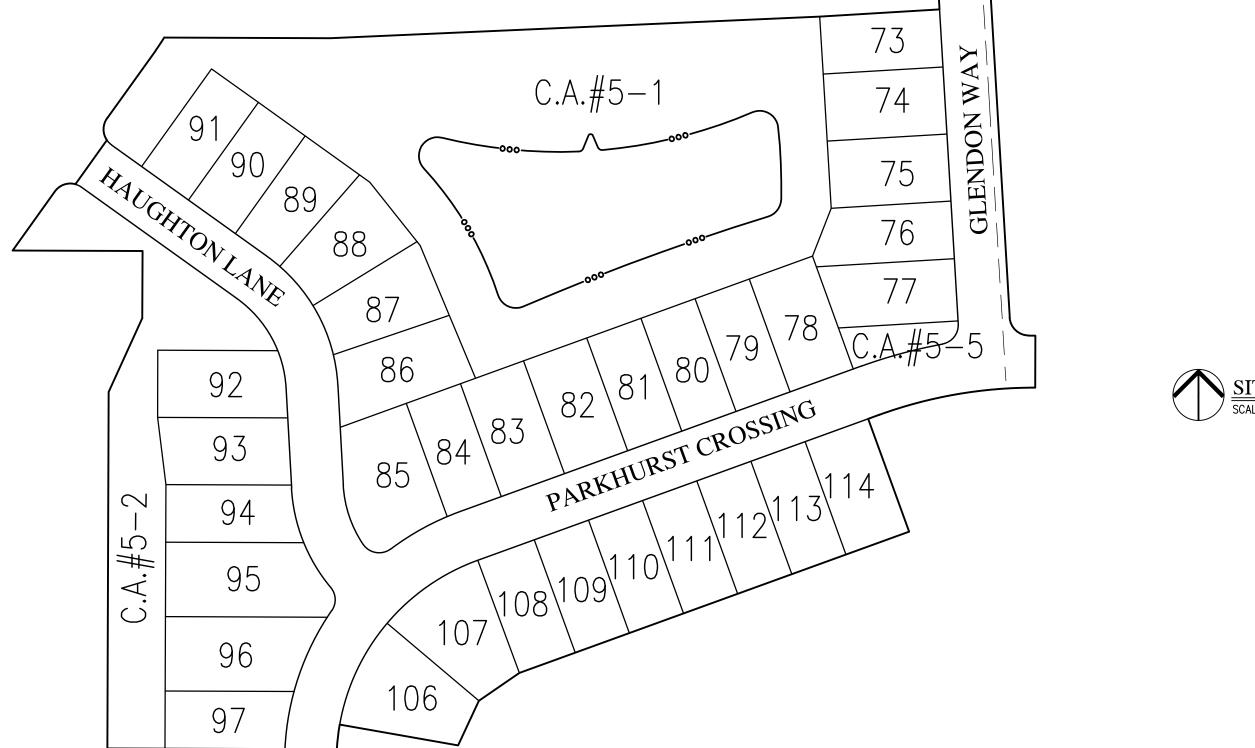

CONTACT INFORMATION:

ENGINEERING DEPARTMENT

mwitsman@mccordsville.org

McCordsville, IN 46055

P: (317) 335-3604

MARK WITSMAN

6280 W 800 N

C.A. #5-3

190 | 189 | 188 | 187 | 186 | 185 /

CHAMBERS DRIVE

CITIZENS ENERGY GROUP/ CWA AUTHORITY, INC. (WATER) BRAD HOSTETLER 2150 DR. MARTIN LUTHER KING JR. STREET INDIANAPOLIS, INDIANA 46202 P: (317) 927-4351 BHOSTETLER@CITIZENSENERGYGROUP.COM

MCCORDSVILLE FIRE DEPARTMENT 7580 N Form Street McCordsville, Indiana 46055

P: (317) 335-9236

NINESTAR CONNECT (Electric & Telecom)
ERIC MEYER (317) 323–2074 2243 East Main Street Greenfield, Indiana 46140 EMEYER@NINESTARCONNECT.COM

PLANNING AND BUILDING DEPT RYAN CRUM

McCordsville, Indiana 46055

6280 W 800 N

P: (317) 335-3604

rcrum@mccordsville.org

<u>COMCAST</u> MATT STRINGER 5330 E. 65th Street Indianapolis, IN 46220 P: (317) 774-3384 F: (317) 219-5090 matthew_stringer@cable.comcast.com

TOWN OF MCCORDSVILLE PUBLIC WORKS

McCordsville, IN 46055

rcrider@mccordsville.org

P: (317) 335-3493

6280 W 800 N

181

<u>VECTREN</u> SANDRA CASEY 16000 Allisonville Road Noblesville, Indiana 46061 P: (317) 776-5532, F: (317) 776-5553 Mailing Address: P.O. Box 1700 Noblesville, Indiana 46061 sandra.casey@centerpointenergy.com

SOILS MAP NOT TO SCALE

SOIL DESCRIPTIONS/LIMITATIONS

1. <u>Br — Brookston silty clay loam, 0 to 2 percent slopes</u>
For the construction of local roads and streets, this soil is rated very limited due to a high potential for ponding, limited depth to a saturated zone (water table), high potential for frost action, moderate potential for shrink/swell action, and low strength. For the construction of homes, this soil is rated very limited due to a limited depth to a saturated zone (water table) and high potential for ponding. The potential for shrink/swell

2. <u>CrA - Crosby silty loam, fine-loamy subsoil, 0 to 2 percent slopes</u> For the construction of local roads and streets, this soil is rated very limited due to a high potential for frost action, limited depth to a saturated zone (water table), and low strength. For the construction of homes, this soil is rated very limited due to a limited depth to a saturated zone (water table).

SHEET LIST TABLE

Sheet Title	Sheet Description
C1.0	COVER
C1.1-C1.2	DEVELOPMENT PLAN
C1.3-C1.4	PRE-CONSTRUCTION STORMWATER POLLUTION PREVENTION & DEMOLITION PLAN
C1.5-C1.6	ACTIVE CONSTRUCTION STORMWATER POLLUTION PREVENTION PLAN
C1.7-C1.8	POST CONSTRUCTION STORMWATER POLLUTION PREVENTION PLAN
C1.9-C1.10	EMERGENCY FLOOD ROUTE PLAN
C1.11	MASTER UTILITY PLAN
C1.12-C1.13	SUBSURFACE DRAIN PLAN
C2.0-C2.2	STREET PLAN & PROFILE
C3.0	INTERSECTION & CUL-DE-SAC DETAILS
C3.1	TRAFFIC CONTROL AND LIGHTING PLAN
C4.0-C4.2	SANITARY SEWER PLAN & PROFILE
C6.0-C6.3	STORM SEWER PLAN & PROFILE
C7.0-C7.1	WATER DISTRIBUTION PLAN
C7.2	WATER DISTRIBUTION PLAN OAKCREST OFFSITE
C8.0	STORMWATER POLLUTION PREVENTION NOTES
C8.1-C8.3	STORMWATER POLLUTION PREVENTION DETAILS
C8.4	CONSTRUCTION DETAILS
C8.5	CITIZENS WATER DETAILS
L1.0	LANDSCAPE PLAN
L1.1	LANDSCAPE DETAILS

McCORDSVILLE TOWN STANDARDS SHEET LIST TABLE

heet Title	Sheet Description
1	DIRECTIONS FOR USE & GENERAL NOTES
2	RIGHT-OF-WAY SECTIONS & PAVEMENT SPECIFICATIONS
3	RIGHT-OF-WAY DETAILS
4	UTILITY LOCATION GUIDELINES
5	DRIVE WAY & HANDICAP RAMP DETAILS
6	STORM SEWER STRUCTURE DETAILS
7	STORM SEWER BEDDING DETAILS AND GENERAL NOTES
8	SANITARY SEWER SPECIFICATIONS
9	SANITARY SEWER DETAILS
10	SANITARY SEWER LIFT STATION STANDARDS & GUIDELINES


REVISIONS DATE DESCRIPTION



INDIANAPOLIS - TERRE HAUTE LAFAYETTE - MUNCIF - NEW ALBANY www.hwcengineering.com

GM/TS CHECKED BY DECEMBER 3, 2019 SCALE AS SHOWN

COVER SHEET

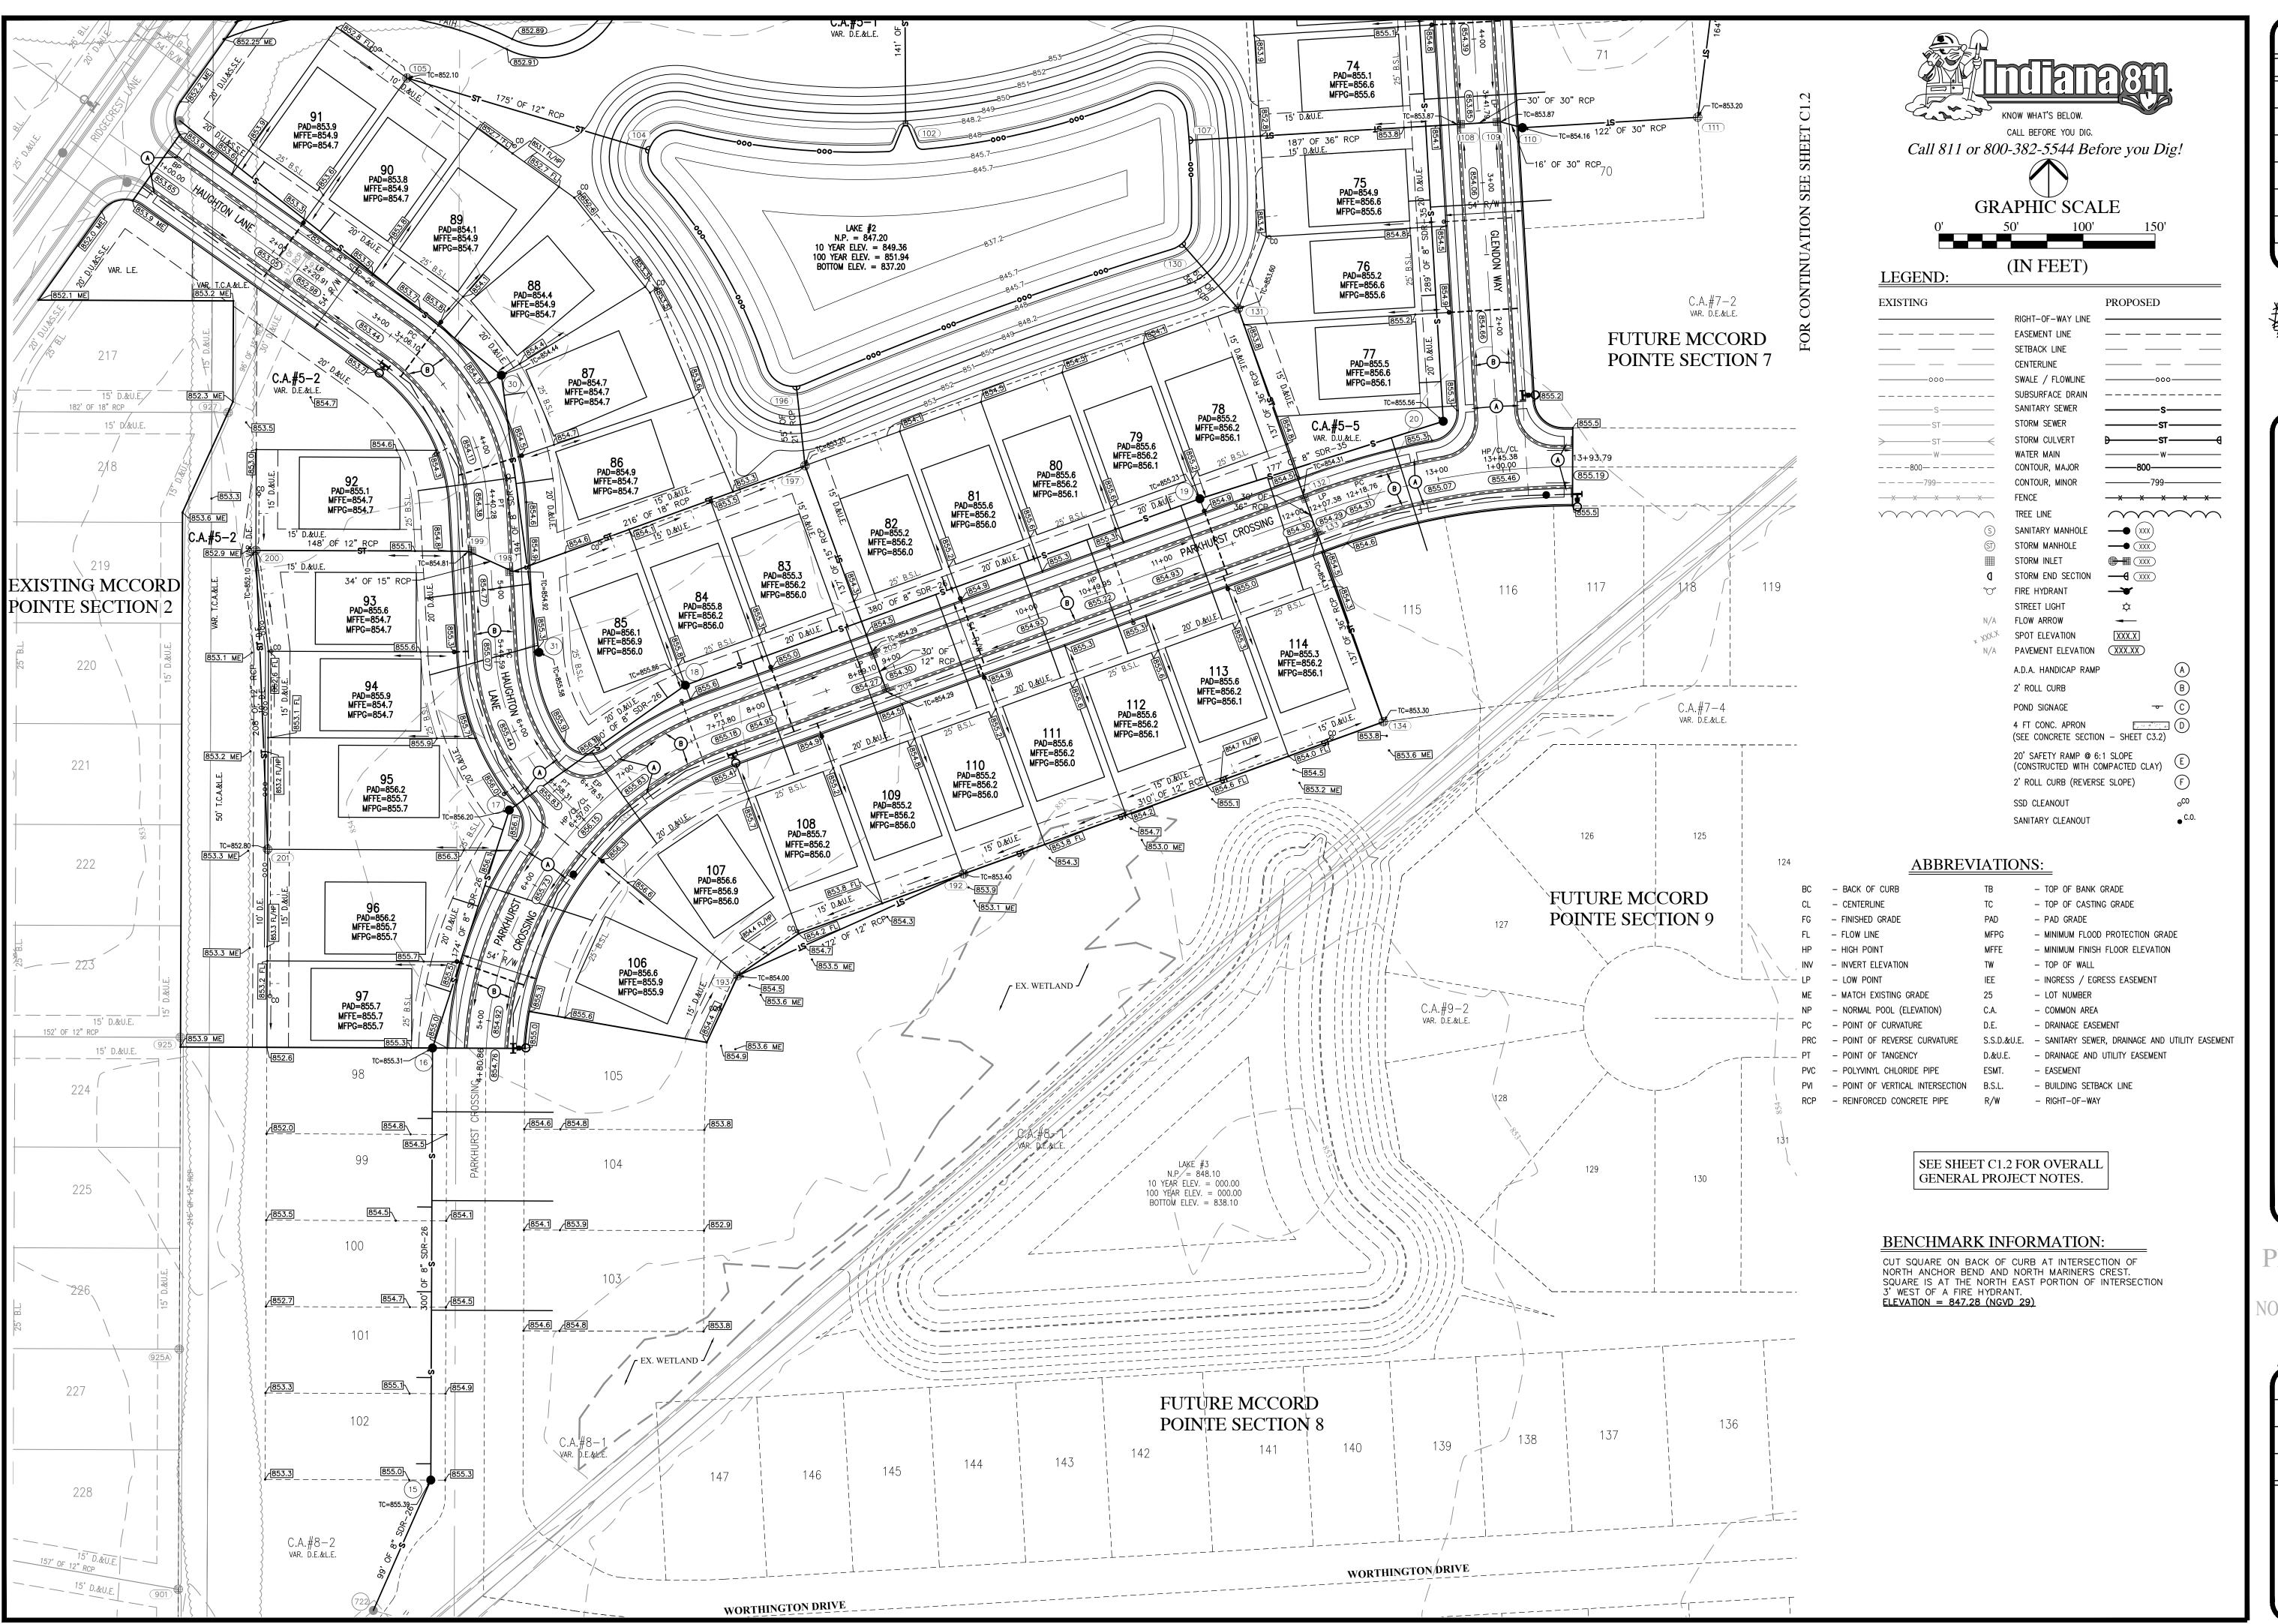

R	EVISION	IS



www.hwcengineering.com

CORDSVILLE, INDIANA

PRIMER No.

11400758


NOT STATE OF THOM

DRAWN BY
GM/TS
CHECKED BY
KE
DATE
DECEMBER 3 2019

DATE
DECEMBER 3, 2019
SCALE
AS SHOWN
SHEET

© 2019

DEVELOPMENT PLAN

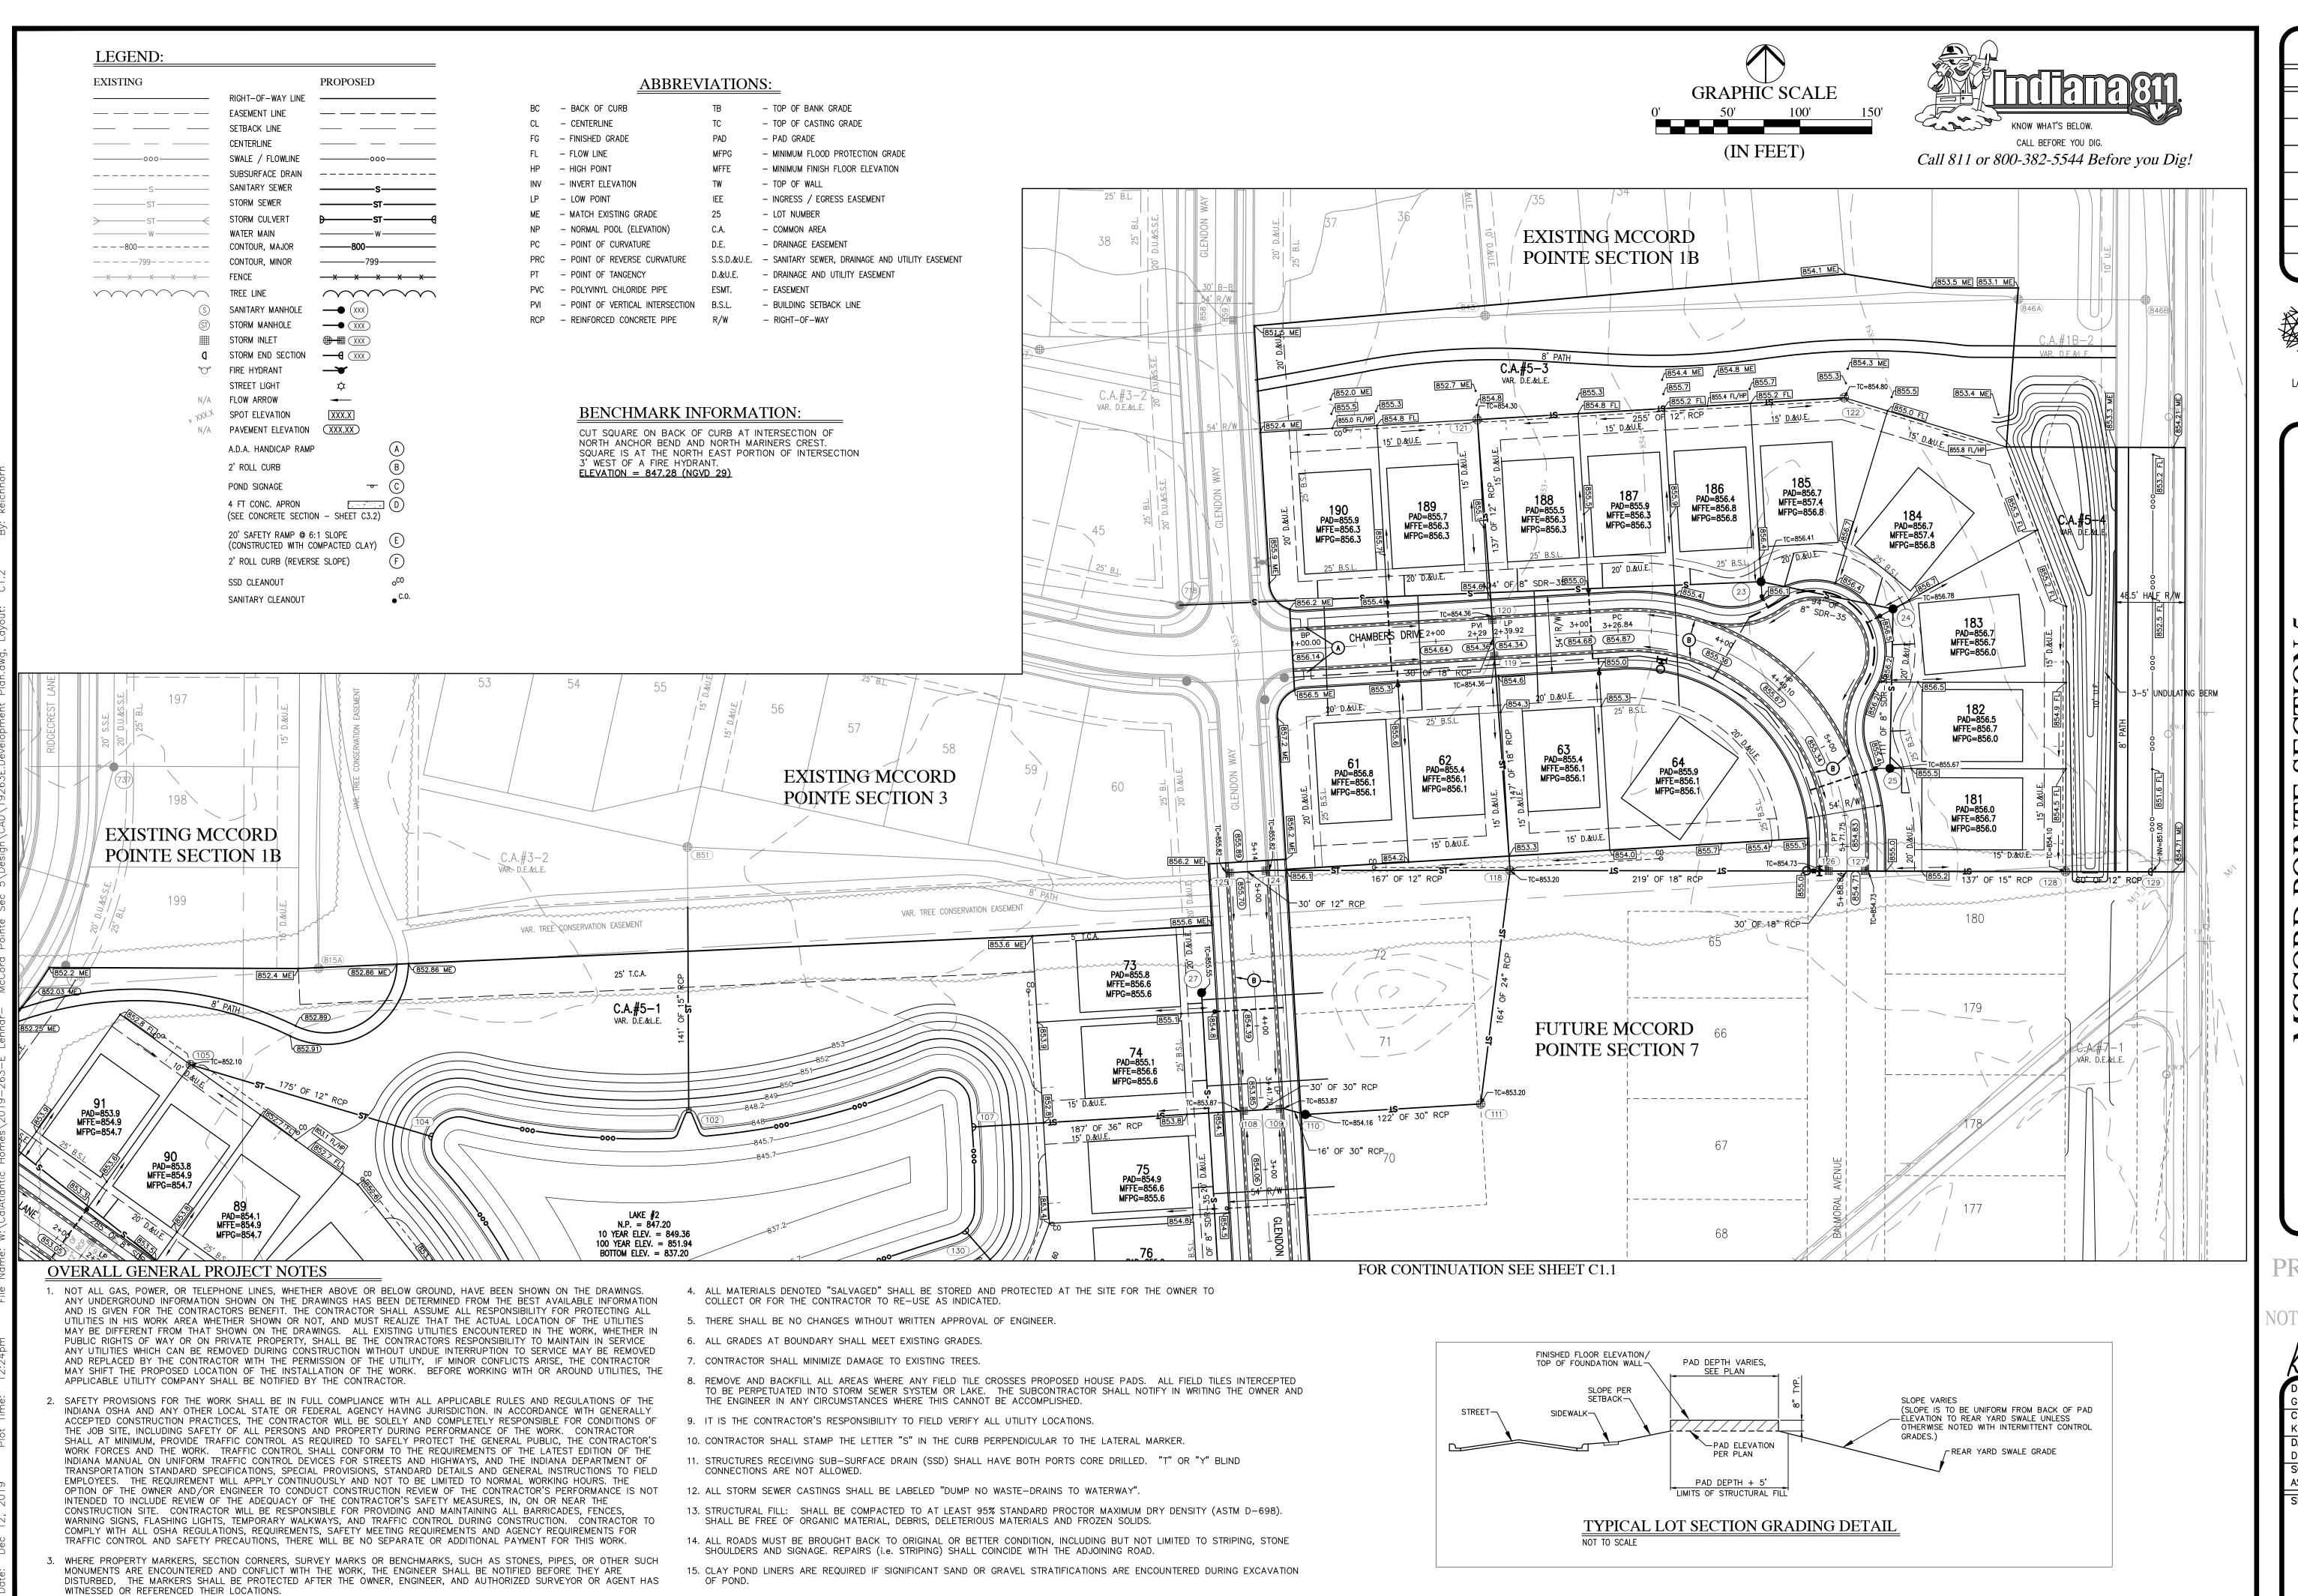

16. ALL COMMON AREA SIDEWALKS OR PATHS ARE TO BE CONSTRUCTED AS PART OF THE SITE INFRASTRUCTURE. INDIVIDUAL LOT

SIDEWALKS TO BE CONSTRUCTED AT THE TIME OF HOME CONSTRUCTION.

REVISIONS





INDIANAPOLIS - TERRE HAUTE LAFAYETTE - MUNCIE - NEW ALBANY www.hwcengineering.com

STATE OF VOIANE DRAWN BY CHECKED BY DECEMBER 3, 2019

AS SHOWN

DEVELOPMENT PLAN

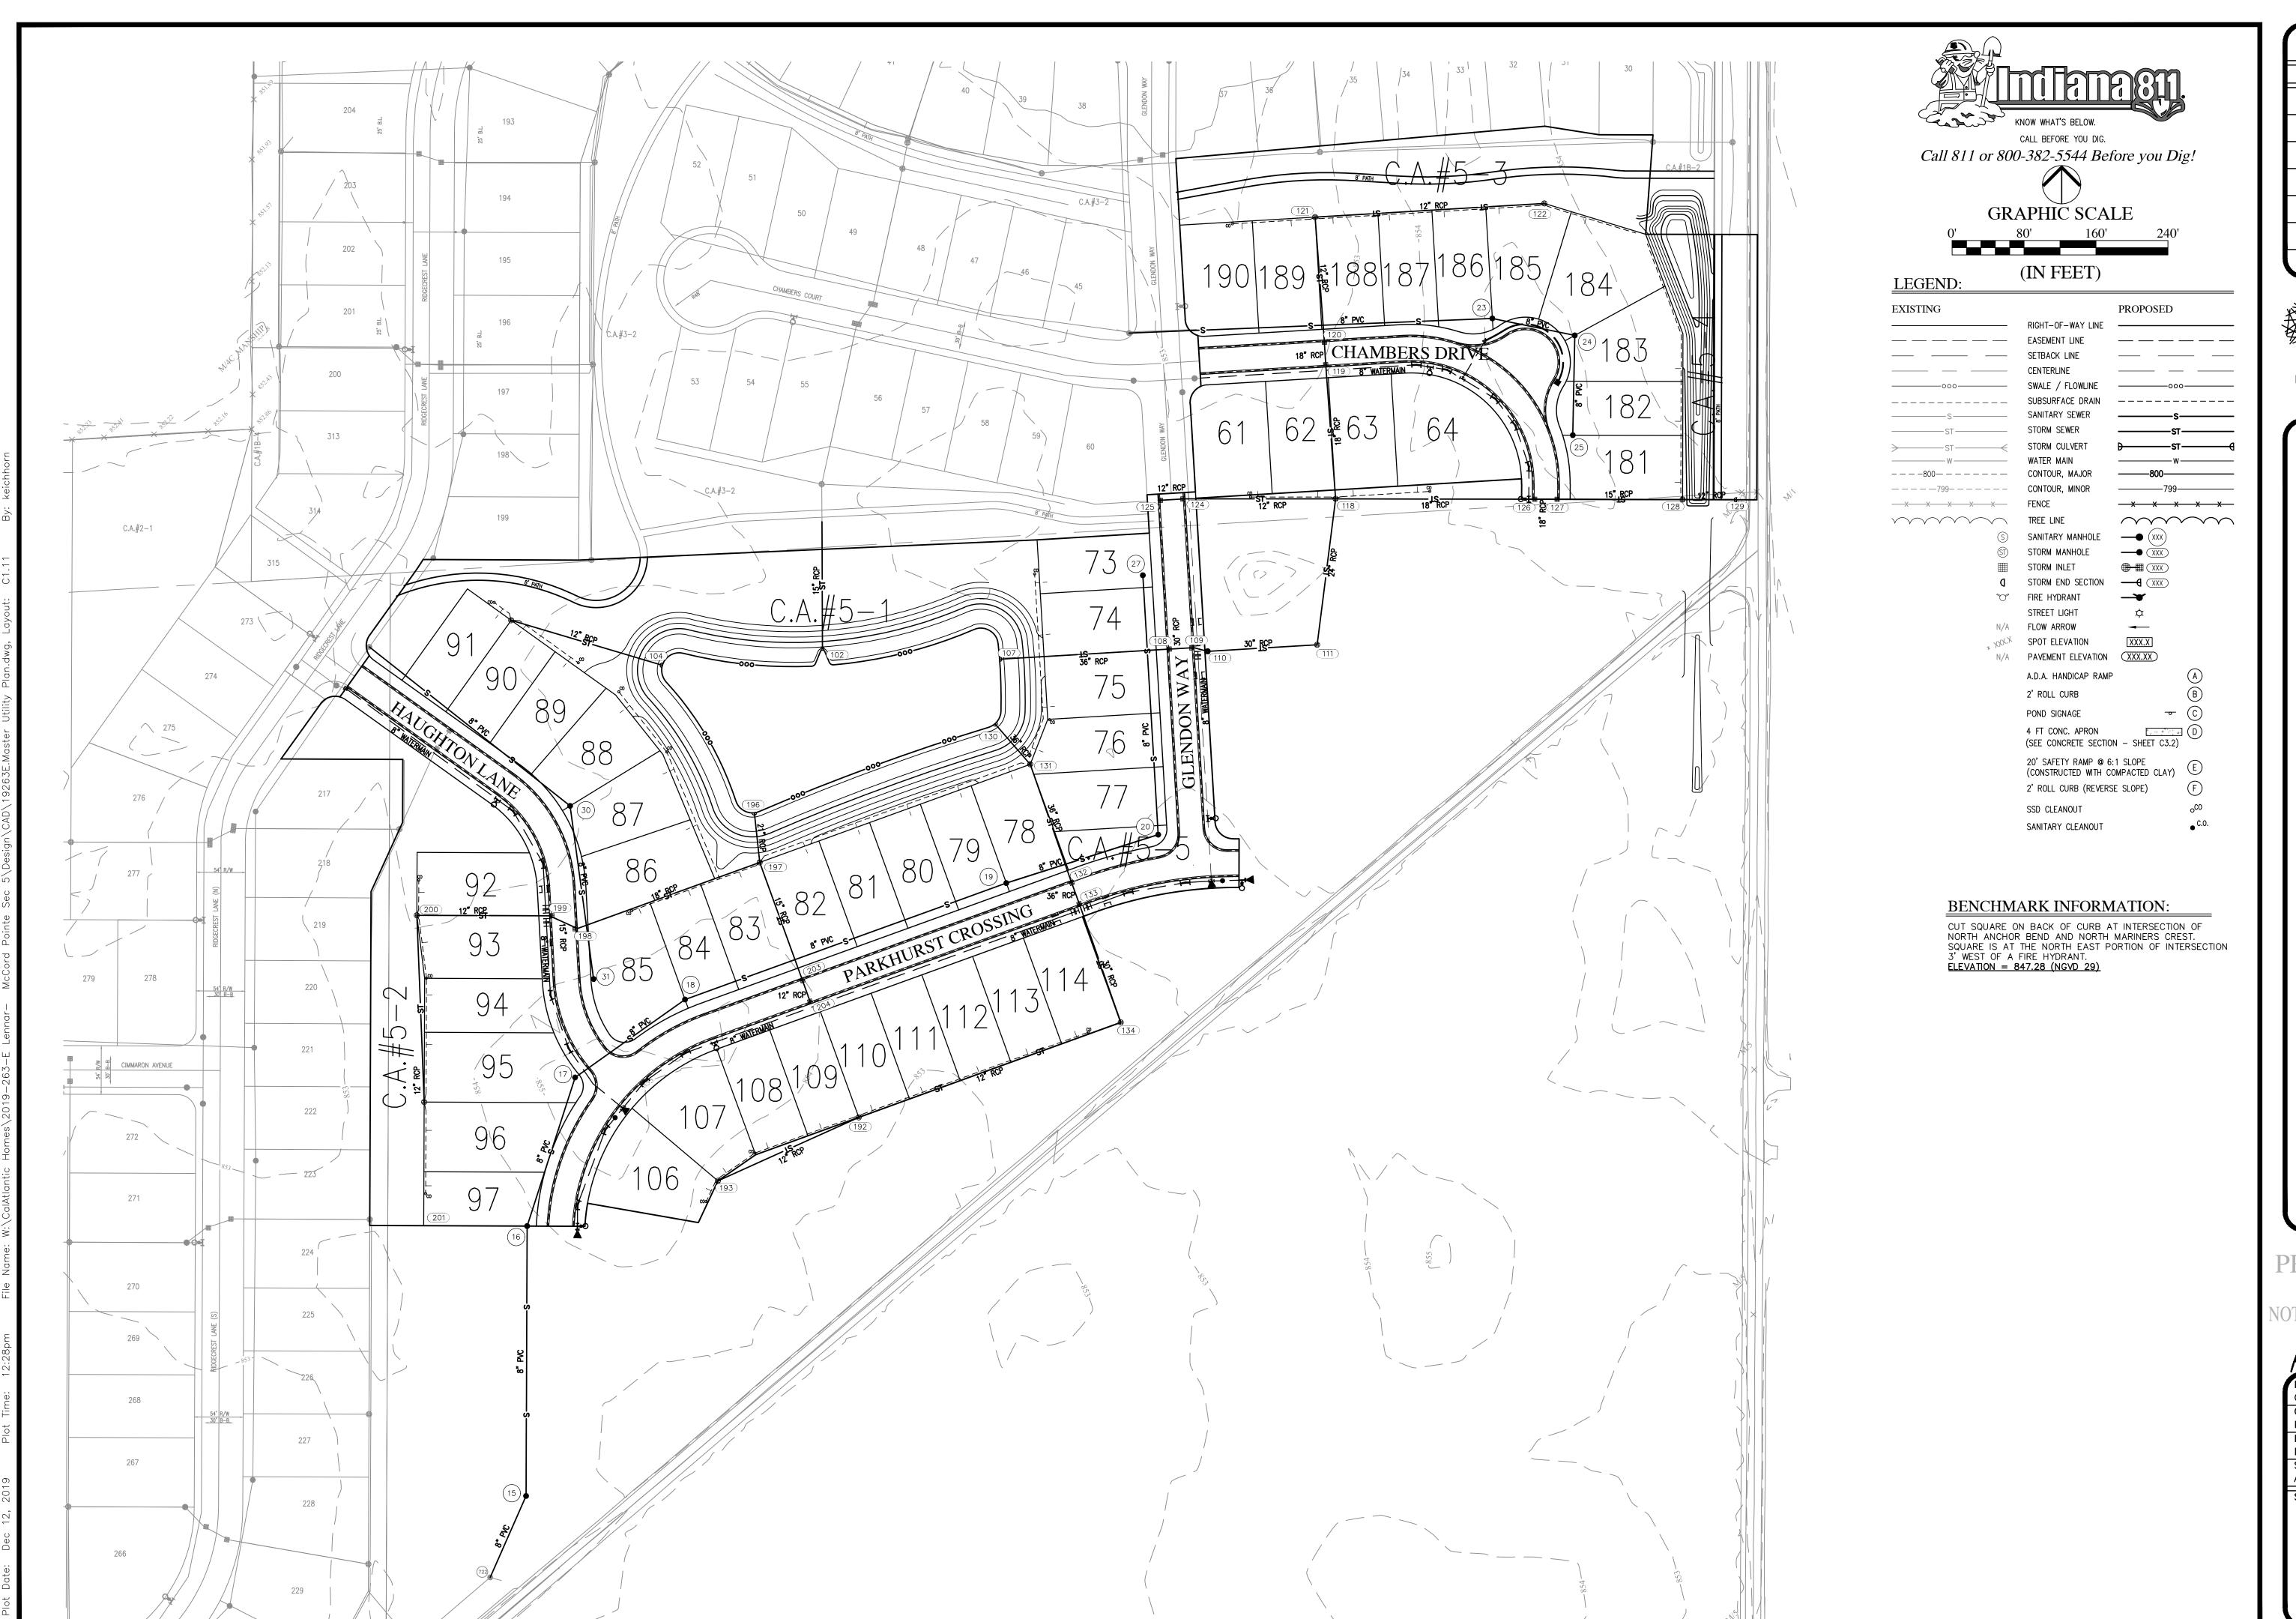

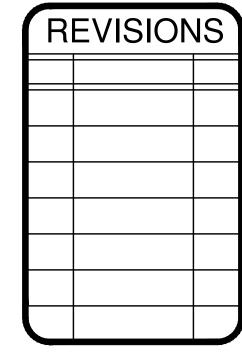



RDSVILLE, INDIANA TER UTILITY PLAN


DRAWN BY
GM/TS
CHECKED BY
KE
DATE
DECEMBER 3, 2019
SCALE
AS SHOWN


AS SHOWN

SHEET

C1.11

MASTER UTILITY PLAN

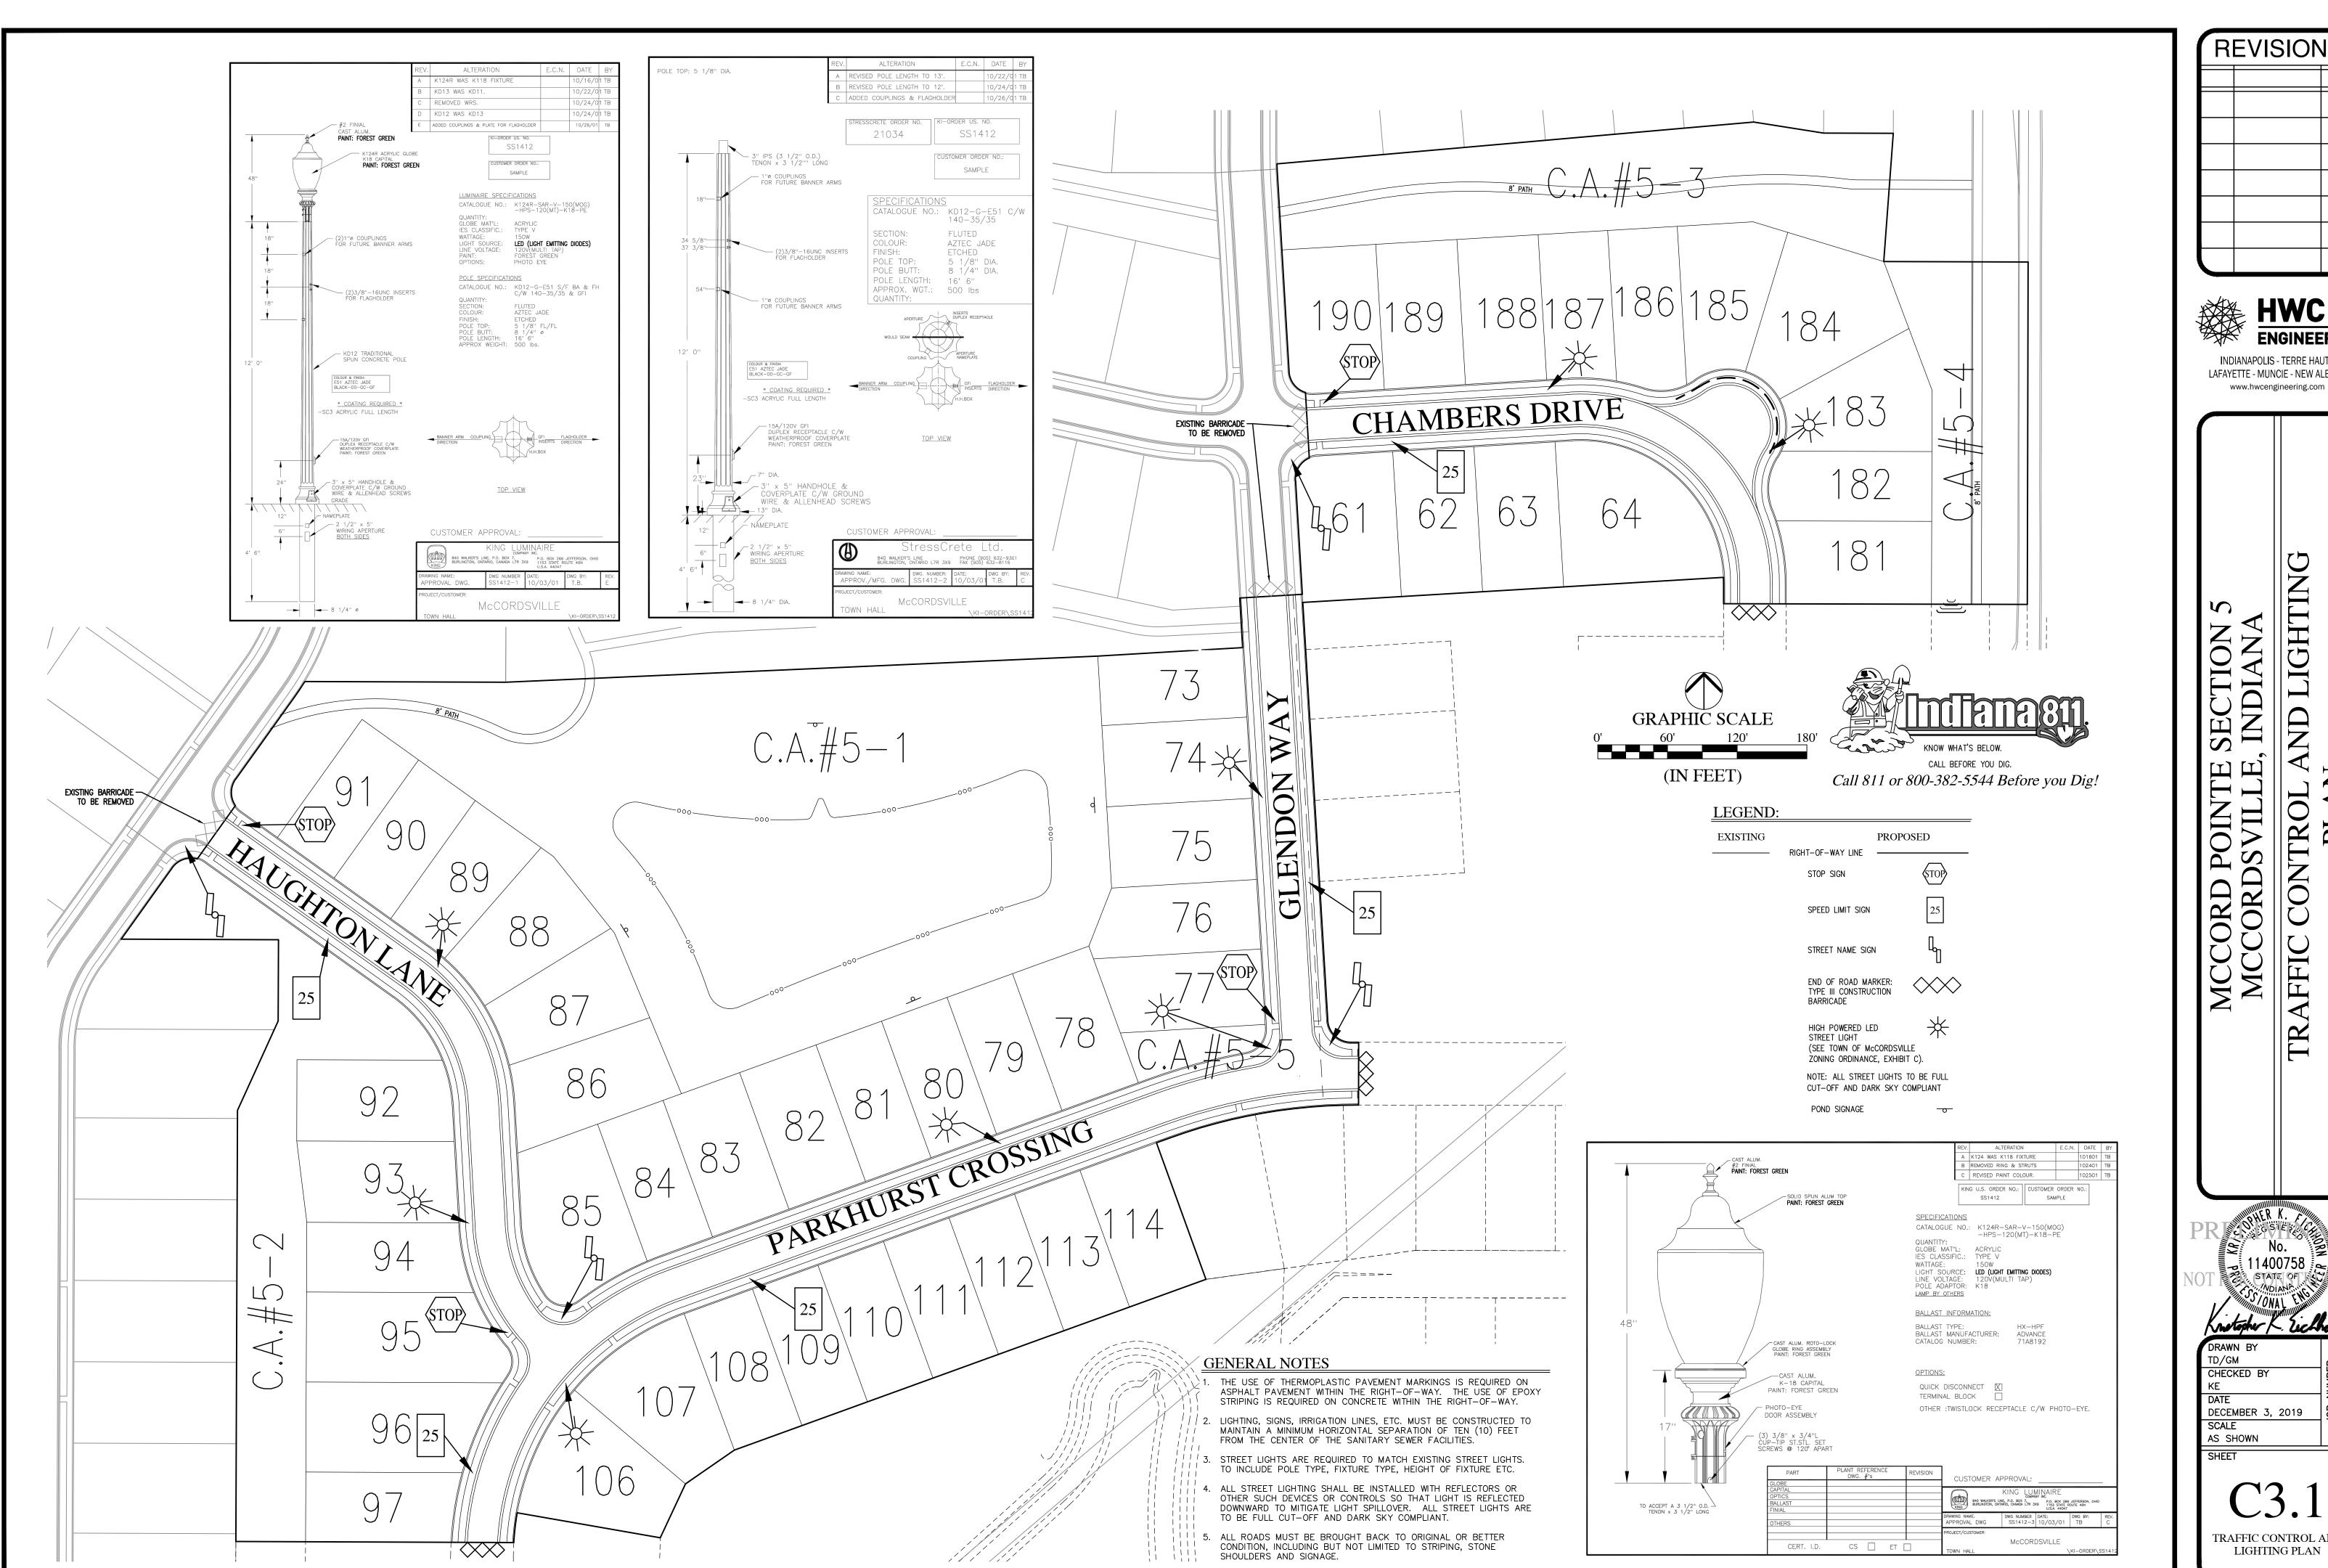


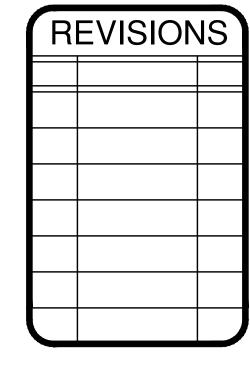




LIGHTING SECTION., INDIANA

POIN SVII MCCORD P MCCORDS

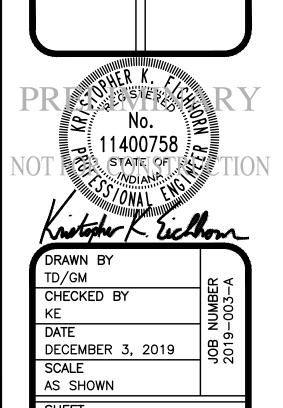

TRAFFIC CONTROL AND LIGHTING PLAN

© 2019

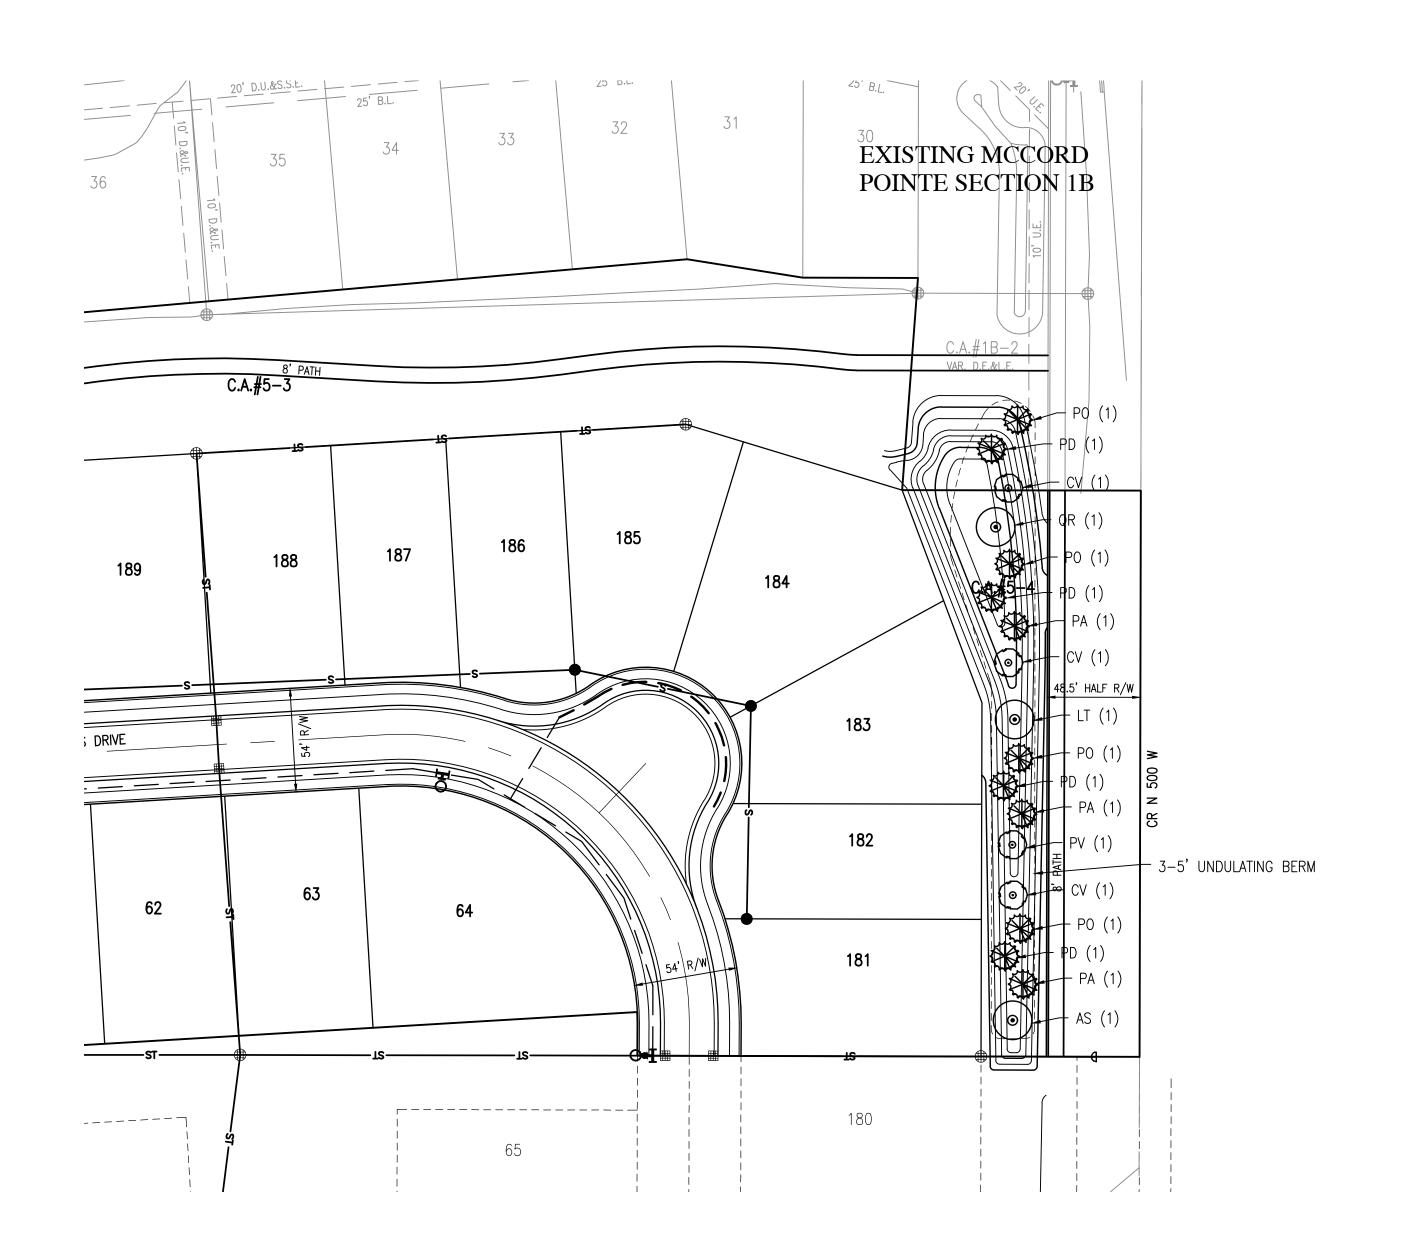


PLANT MATERIAL SCHEDULE

KEY	BOTANICAL NAME	COMMON NAME	QUANTITY	SIZE	REMARKS
AS	ACER SCCHARUM 'LEGACY'	LEGACY SUGAR MAPLE	1	2" B&B	CENTRAL LEADER, HEADED UP TO 4' MIN
CV	CRATEAGUS VIRDIS 'WINTER KING'	WINTER KING HAWTHORN	2	2" B&B	GOOD BRANCH STRUCTURE HEADED UP TO 4' MIN
LT	LIRIODENDRON TULIPIFERA	TULIP TREE	1	2" B&B	CENTRAL LEADER, HEADED UP TO 4' MIN
PA	PICEA ABIES	NORWAY SPRUCE	3	6" B&B	SINGLE LEADER, FULL, MATCHING SPECIMENS
PD	PICEA GLAUCA 'DENSATA'	BLACK HILLS SPRUCE	3	6" B&B	SINGLE LEADER, FULL, MATCHING SPECIMENS
РО	PICEA OMORIKA	SERBIAN SPRUCE	3	6" B&B	SINGLE LEADER, FULL, MATCHING SPECIMENS
PV	PRUNUS VIRGINIANA 'CANADA RED'	CANADA RED CHOKECHERRY	1	2" B&B	CENTRAL LEADER, HEADED UP TO 4' MIN
QR	QUERCUS RUBRA	RED OAK	1	2" B&B	CENTRAL LEADER, HEADED UP TO 4' MIN

NOTE:

SUPPLEMENTAL TREE PLANTINGS AT A RATE OF 5 TREES PER ACRE ARE REQUIRED IN CA 5-1, CA 5-3 AND CA 5-5.

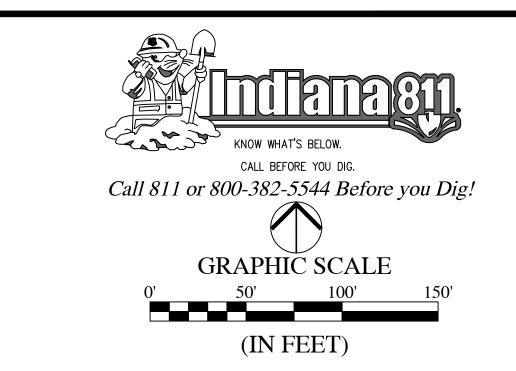

EXISTING		PROPOSED	
	RIGHT-OF-WAY LINE		
	EASEMENT LINE		
	SETBACK LINE		
	CENTERLINE		
	SWALE / FLOWLINE SUBSURFACE DRAIN	000)——
	SANITARY SEWER		
ST	STORM SEWER	s-	
>ST	STORM CULVERT	DST	
	WATER MAIN	w-	
800	CONTOUR, MAJOR	800	
	CONTOUR, MINOR	799-	
XXXX	FENCE	xx	×
	TREE LINE	$\overbrace{\hspace{1cm}}$	
(\$)	SANITARY MANHOLE	— (xxx)	
ST	STORM MANHOLE	\longrightarrow (XXX)	
	STORM INLET	⊕ ⊞ XXX	
0	STORM END SECTION	─⊕	
8	FIRE HYDRANT	_	
N/A	STREET LIGHT FLOW ARROW	*	
**************************************	SPOT ELEVATION	XXX.X	
\ \/A	PAVEMENT ELEVATION	(XXX.XX)	
	A.D.A. HANDICAP RAMP		(A)
	2' ROLL CURB		(B)
	POND SIGNAGE	-o-	<u>(C)</u>
	4 FT CONC. APRON (SEE CONCRETE SECTION	N – SHEET C3.2)	
	20' SAFETY RAMP @ 6: (CONSTRUCTED WITH CO		E
	2' ROLL CURB (REVERS	E SLOPE)	F
	SSD CLEANOUT		o ^{CO}
	SANITARY CLEANOUT		C.O.

T	ANDSCA	DE I	EGE	ND.
L	Δ NDSC Γ	\mathbf{u}		יעו

XXX QUANTITY / KEY

ENTRY MONUMENT

PERENNIAL BED

SHADE TREE

EVERGREEN TREE

ORNAMENTAL TREE

DECIDUOUS SHRUB

GRASSES

REVISIONS



INDIANAPOLIS - TERRE HAUTE LAFAYETTE - MUNCIE - NEW ALBANY www.hwcengineering.com

> CORDSVILLE, INDIAL LANDSCAPE PLAN

DRAWN BY
GM/TS
CHECKED BY
KE
DATE
DECEMBER 3, 2019

L1.0

SCALE AS SHOWN

© 2019