BROAD ACRE

W 600 North and Mt. Comfort Rd. McCordsville, IN

Cityscape Residential

7 March 2024

Project Team Directory

Owner/Developer: **Archview Properties** 10 W. Carmel Drive Suite 200 Carmel, IN 40632 Phone: 317-374-7802

General Contractor: Cityscape Residential Construction 10 W. Carmel Drive

Suite 200 Carmel, IN 40632 Phone: 317-574-1600 Fax: - - -

Architect:

SGN+A, Inc. 315 West Ponce de Leon Avenue Suite 755 Decatur, Georgia 30030 Phone: 404-373-7370 Fax: 404-373-7372

Landscape Consultant: SGN+A, Inc. 315 West Ponce de Leon Avenue Suite 755 Decatur, Georgia 30030 Phone: 404-373-7370

Fax: 404-373-7372

Phone: 816-531-4144

Structural Engineer: Bob D. Campbel & Co. Structural Engineers 4338 Belleview Ave. Kansas City, MO 64111

Fax: - - -Mechanical, Electrical, and Plumbing Engineer: Latimer Sommers & Associates, P.A.

8625 College Boulevard Suite 102 Overland Park, KS 66210 Phone: (785-806-7967 Fax: ---

Direct Consultants to the Owner:

Civil Engineer: Kimley-Horn 250 East 96th Street Suite 580 Indianapolis, Indiana 46240 Phone: 317-218-9563 Fax: - - -

Interior Designer: Mitsch Design 200 South Rangeline Road Suite 213 Carmel, Indiana 46032 Phone: 317-573-2222 Fax: 317-573-2230

Contact: Jennifer Sewell

E-mail: jsewell@cityscaperesidential.com

Contact: Mike Patarino E-mail: mpatarino@cityscaperesidential.com

Contact: Daniel Ajiboye E-mail: dajiboye@sgnplusa.com

Contact: Brian Nonemaker E-mail: bnonemaker@sgnplusa.com

Contact: Chris Beverlin

E-mail: CBeverlin@bdc-engrs.com

Contact: Richard Bearmore E-mail: <u>rbeardmore@lsapa.com</u>

Contact: Bryan Sheward **E-mail:** bryan.sheward@kimley-horn.com

Contact: Richard Bunnell E-mail: rbunnell@mitschdesign.com

Project Code Information

W 600 North and Mt. Comfort Rd. (assigned street address tbd) **Project Location:**

McCordsville, IN

Project Scope: 11 Residential Apartment Buildings 1 Resident Amenity Building: Leasing Office & Clubhouse

1 Maintenance Building

1 Trash Enclosure structure

Applicable Building Code(s): Town of McCordsville Local Codes and Zoning Ordinances Article 13 - Building Codes:

1. Fire and Building Safety Standards; and 2. State Building Code. Article 14 - Indiana Residential Code; Article 16 - Indiana Plumbing Code; Article 17 - Indiana Electrical Code; Article 18 - Indiana Mechanical Code;

Article 19 - Indiana Energy Conservation Code; Article 20 - Indiana Swimming Pool Code; Article 22 - Indiana Fire Code Article 25 - Indiana Fuel Gas Code

Base Code Standards 2012 International Building Code 2018 International Mechanical Code 2018 International Plumbing Code 2017 NFPA 70 National Electric Code 2018 International Fuel Gas Code

2007 ASHRA 90.1 2018 International Energy Conservation Code 2018 International Residential Code 2021 International Fire Code

Construction Type Classications: IBC Chapter 5 Area Calculations:

MANUAL FOR DESIGN CRITERIA

Deferred Submittals: THE FOLLOWING DRAWINGS SHALL BE SUBMITTED BY THE SUB-CONTRACTOR. SEE THE PROJECT

- **FIRE SPRINKLER SHOP DRAWINGS TO BE SUBMITTED AND TO APPROVED BY INDIANA STATE FIRE MARSHAL OR LOCAL FIRE CHEIF PRIOR TO FABRICATION AND INSTALLATION.**


(SEE PRESCRIPTIVE FIRE PROTECTION SPECIFICATIONS ON SHEET FP1.0) FIRE SPRINKLER SYSTEM TO HAVE THIRD-PARTY MONITORED CONNECTED FLOW-SWITCH ALARM. THIRD-PARTY DOCUMENTATION TO BE PROVIDED PRIOR TO SPRINKLER INSTALLATION. - FIRE ALARM DESIGN SYSTEM TO BE SUBMITTED AND TO APPROVED BY INDIANA STATE FIRE

- PRE-ENGINEERED WOOD FLOOR AND ROOF TRUSSES

MARSHAL OR LOCAL FIRE CHEIF TO INSTALLATION.

- IRRIGATION SYSTEM SHOP DRAWINGS -SEE SPECIFICATIONS AND CIVIL DWGS - "ERRS", BI-DIRECTIONAL RADIO ATTENNA BUILDING-INTEGRATED COMMUNICATIONS SYSTEM (IF APPLICABLE FOR LOCAL EMERGENCY RESPONSE)

Vicinity Map

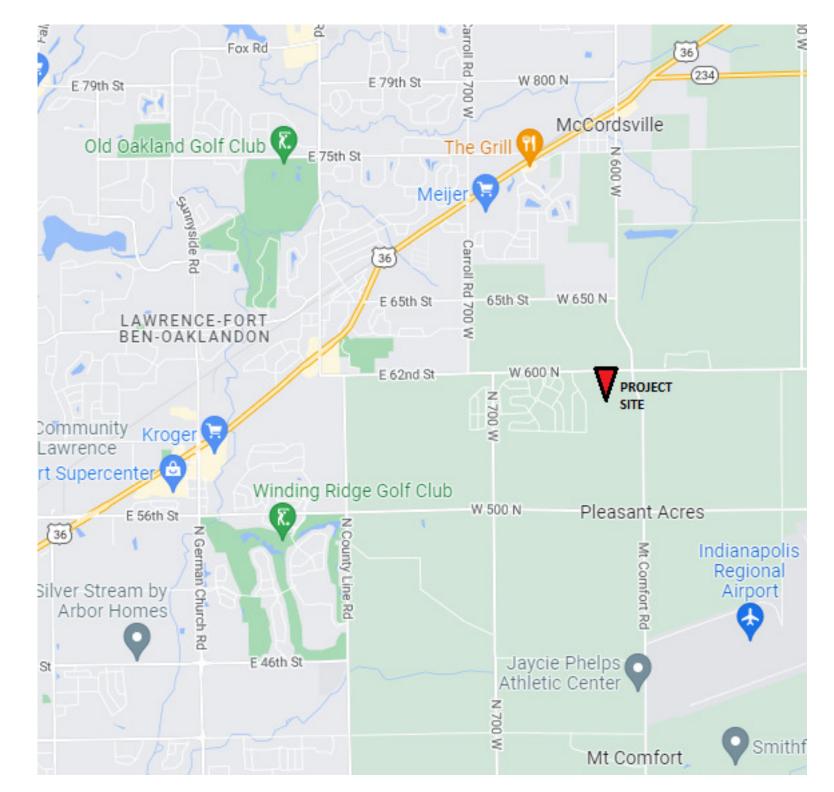

McCordsville, Indiana			BROAD ACRE Unit and Building Area Matrix 1.20.2023													
Bldg. Number	Bldg. Type						Uni	t Type								
			A1	A2	A2.1	А3	A3.1	B2	B2.1	B5	B5.1	C1	TOTALS			
Net heated			668	772	792	735	807	1026	1058	1078	1086	1288			Res. Building GSF	Res. Building Covered GSF
Gross SF			780	900	915	845	920	1193	1188	1219	1222	1437				
1	I	2 story										8	8		11997	12774
2	1	2 story										8	8		11997	12774
3	Ш	2 story						8	8				16		19822	21216
4	11	2 story		8	8								16		15456	16728
5	Ш	2 story						8	8				16		19822	21216
6	31	2 story		8	8								16		15456	16728
7	П	2 story		8	8								16		15456	16728
8	Ш	2 story						8	8				16		19822	21216
9	IV	4 story	16			8	8			8	8		48		50496	54120
10	IV	4 story	16			8	8			8	8		48		50496	54120
11	IV	4 story	16			8	8			8	8		48		50496	54120
			48	24	24	24	24	24	24	24	24	16	<u>256</u>	'		
		Unit Mix		1	44	N_21	I	<u></u>	96	2 3	J	16		Building Type I	23,994	<u>25,548</u>
				56	.3%				37.5%			6.3%		Building Type II	46,368	<u>50,184</u>
														Building Type III	59,466	<u>63,648</u>
Total Unit Net heated SF			32,064	18,528	19,008	17,640	19,368	24,624	25,392	25,872	26,064	20,608	229,168	Building Type IV	<u>151,488</u>	<u>162,360</u>
Total Unit Gross SF			37,440	21,600	21,960	20,280	22,080	28,632	28,512	29,256	29,328	22,992	<u>262,080</u>			
														Total Residential		
Average Unit Net SF													895	Building GSF	<u>281,316</u>	<u>301,740</u>
										Logoing			 i		-	
										<u>Leasing</u> <u>Center -</u>		NET HEATED	GROSS AREA	Maintenance Bldg		
										Clubhouse		7,182 SF	7,379 SF	499 GSF		
															_	




Landscape Architecture

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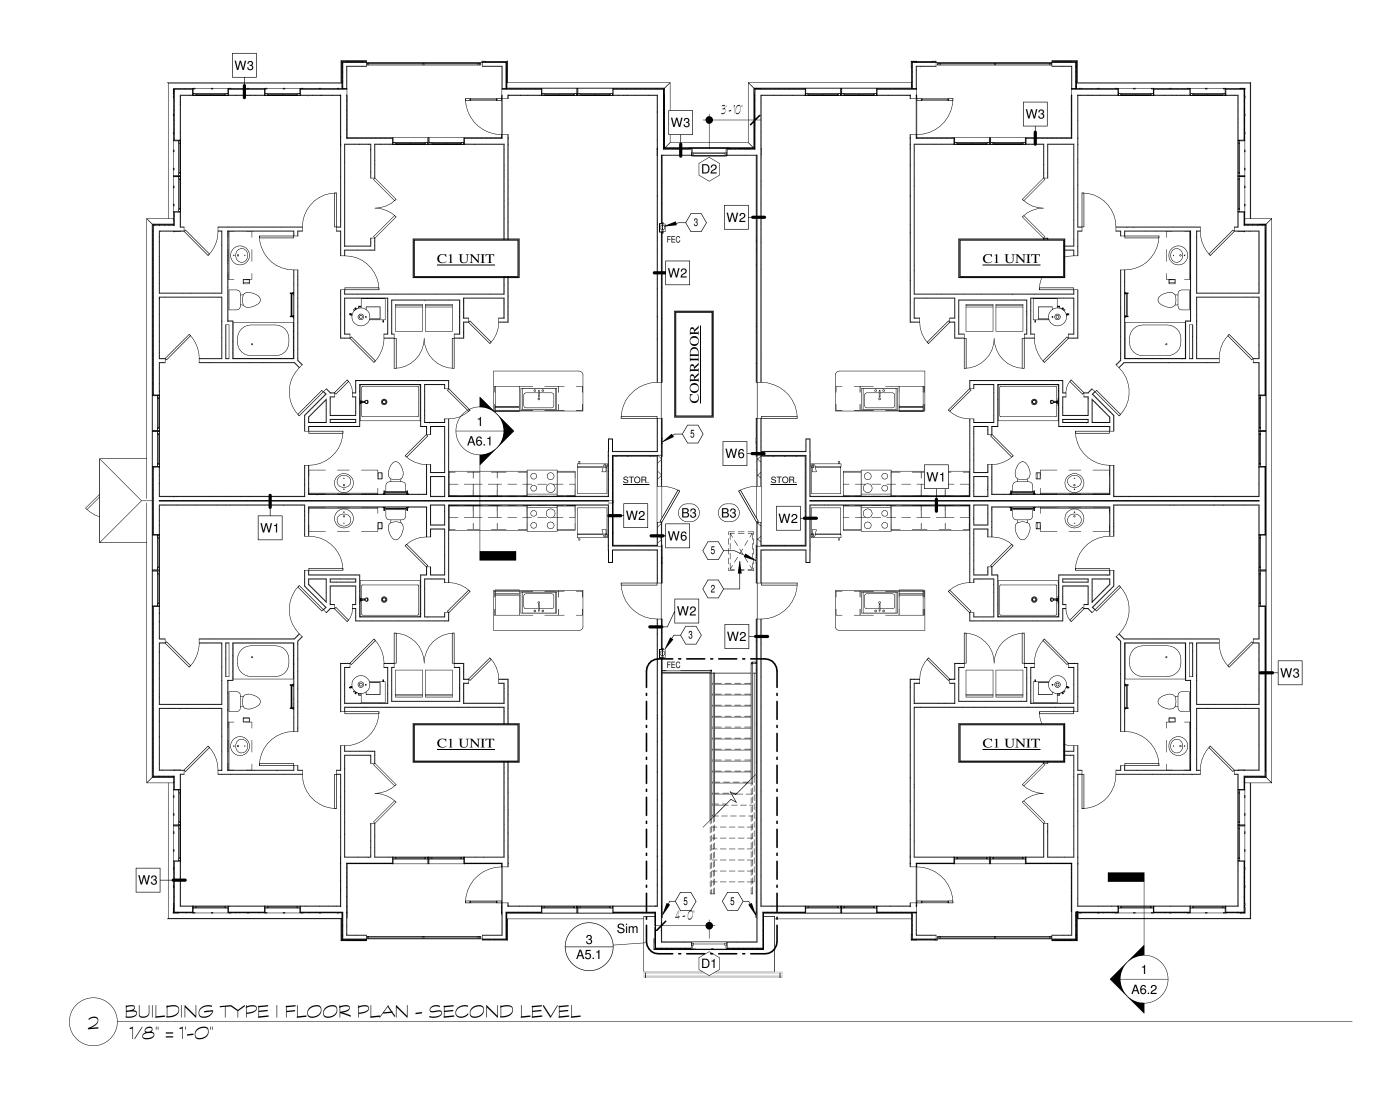
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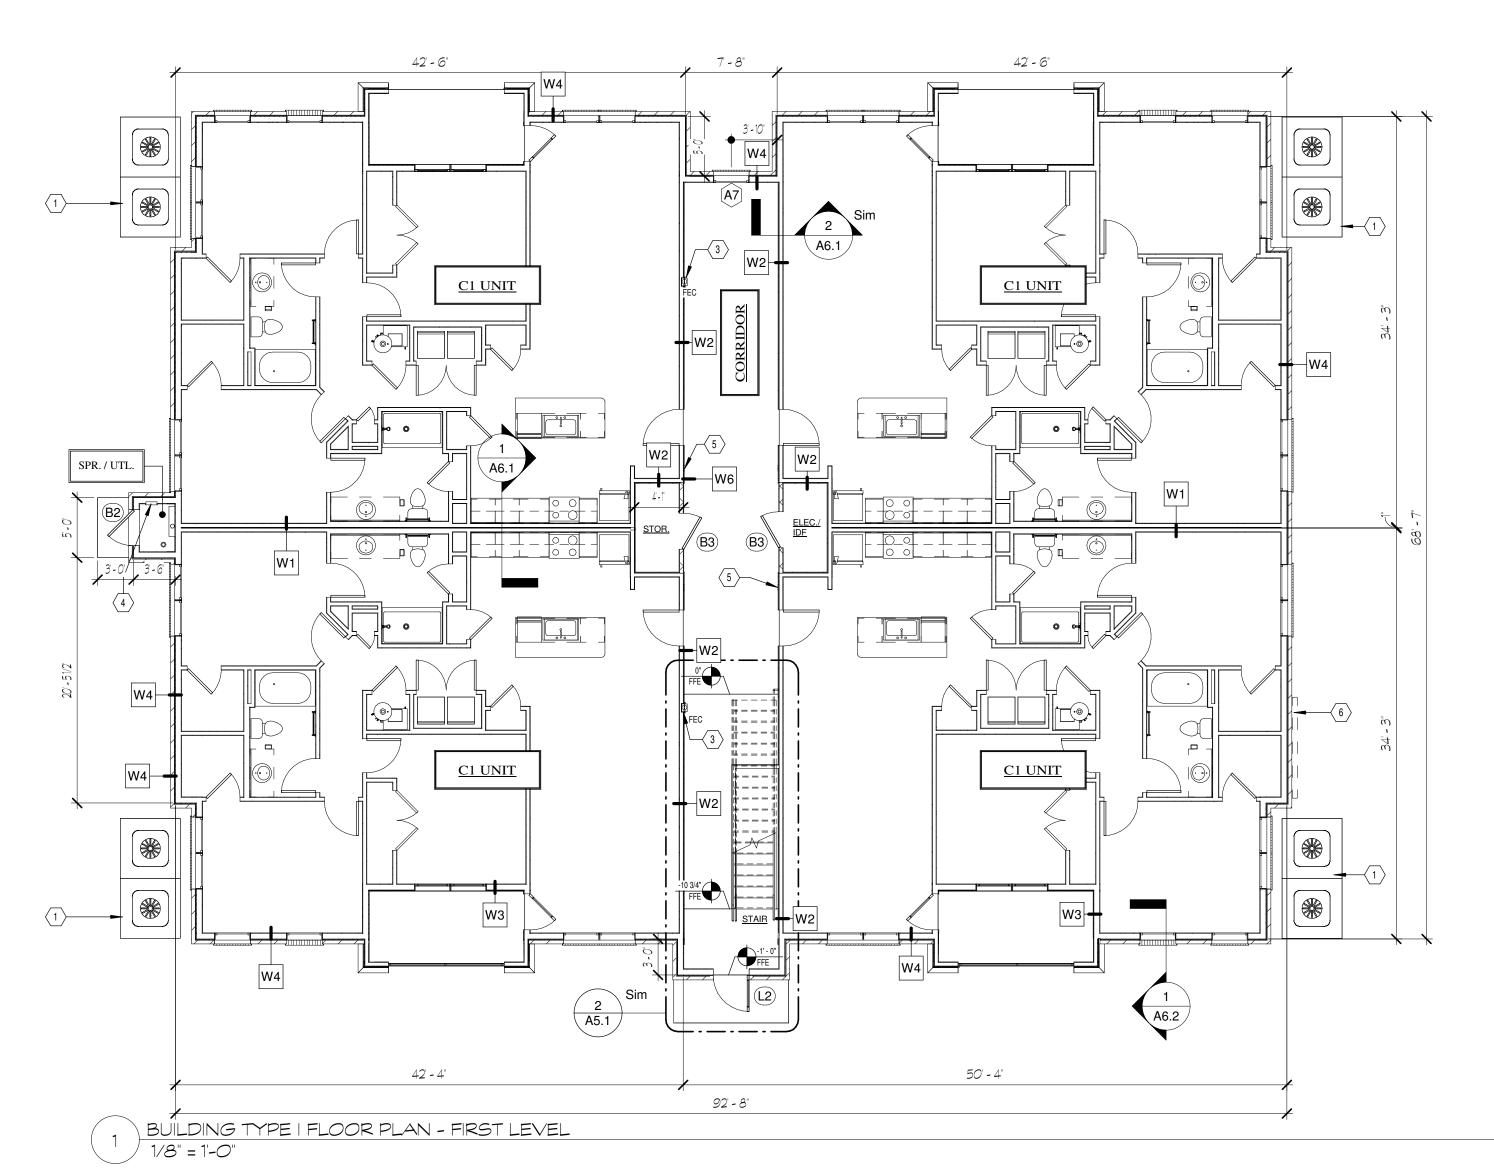
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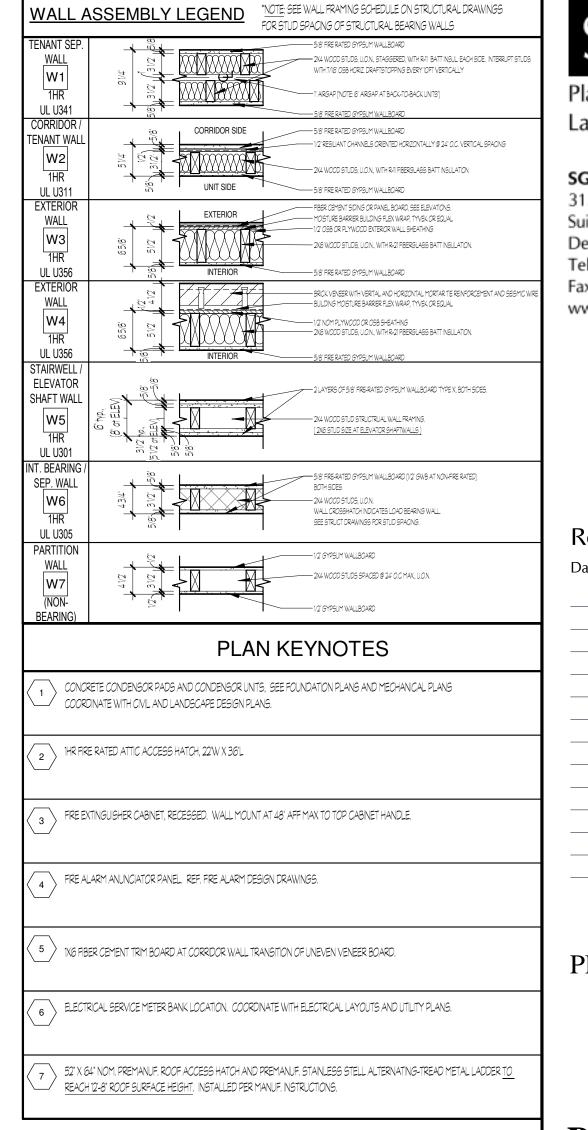
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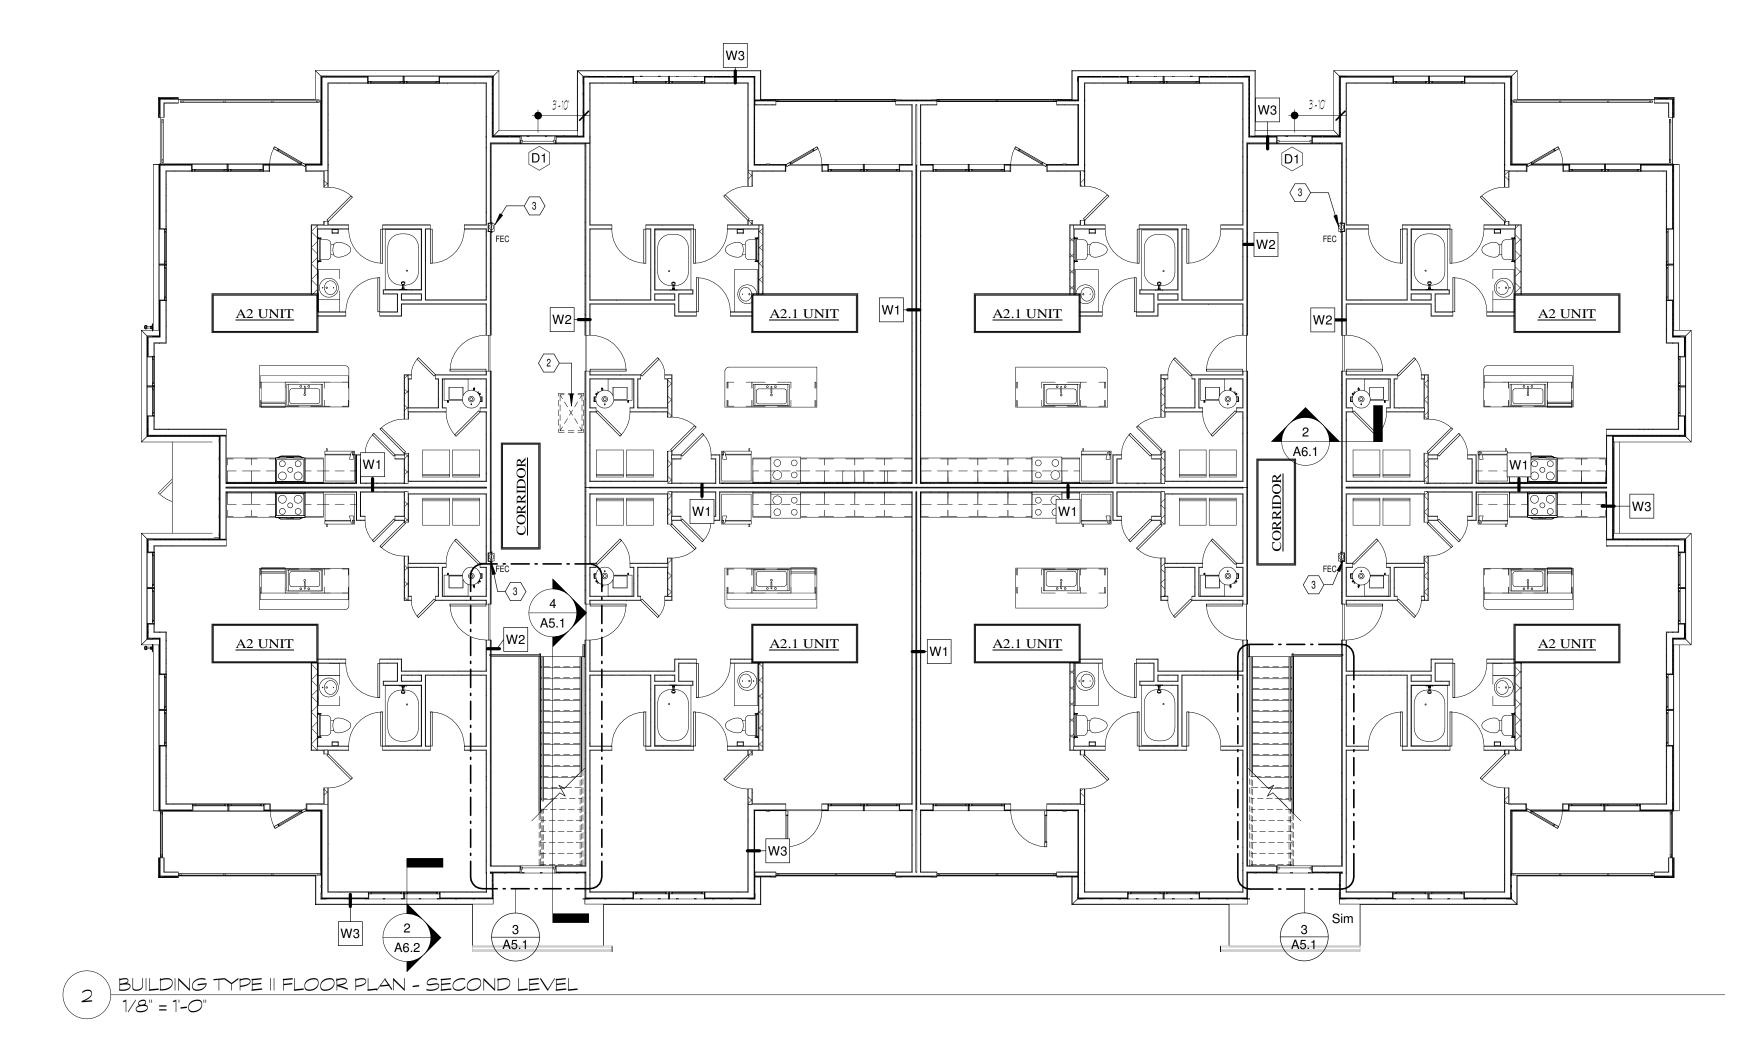
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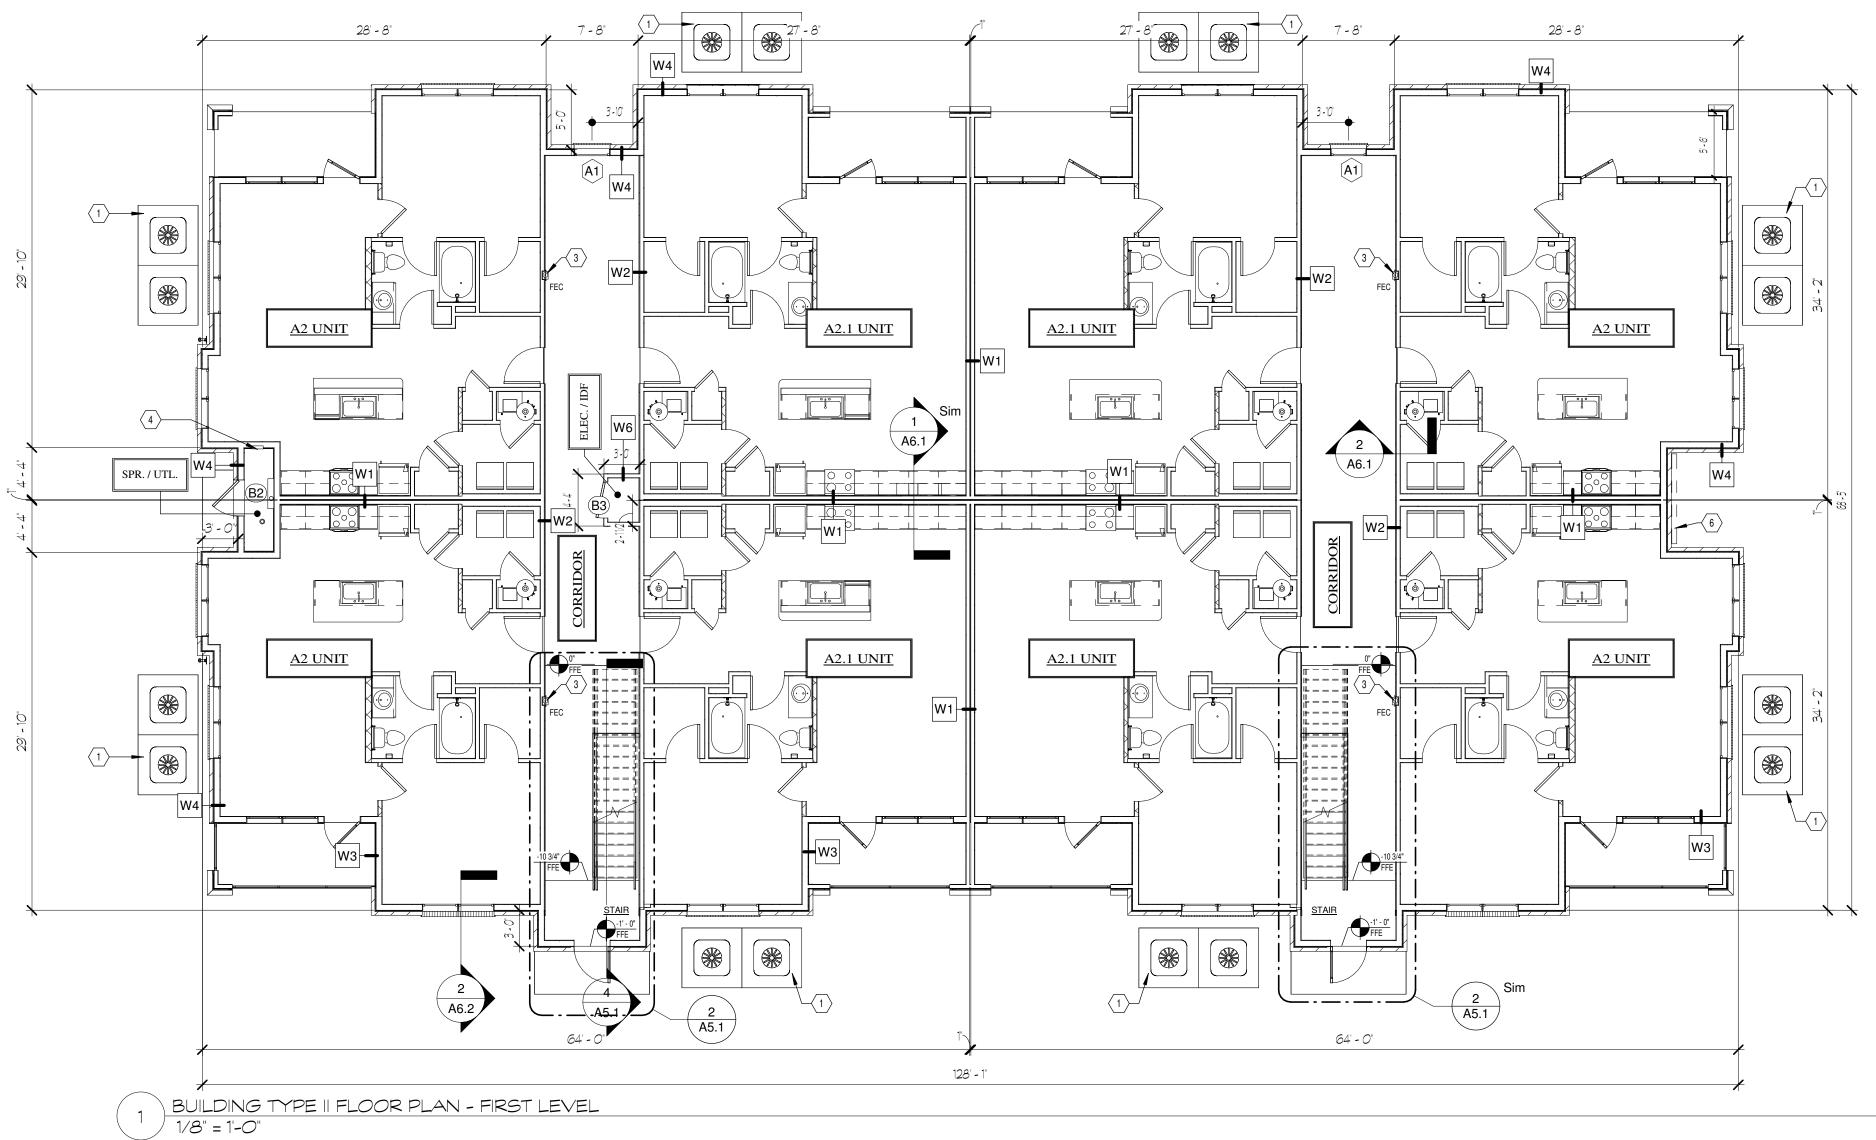
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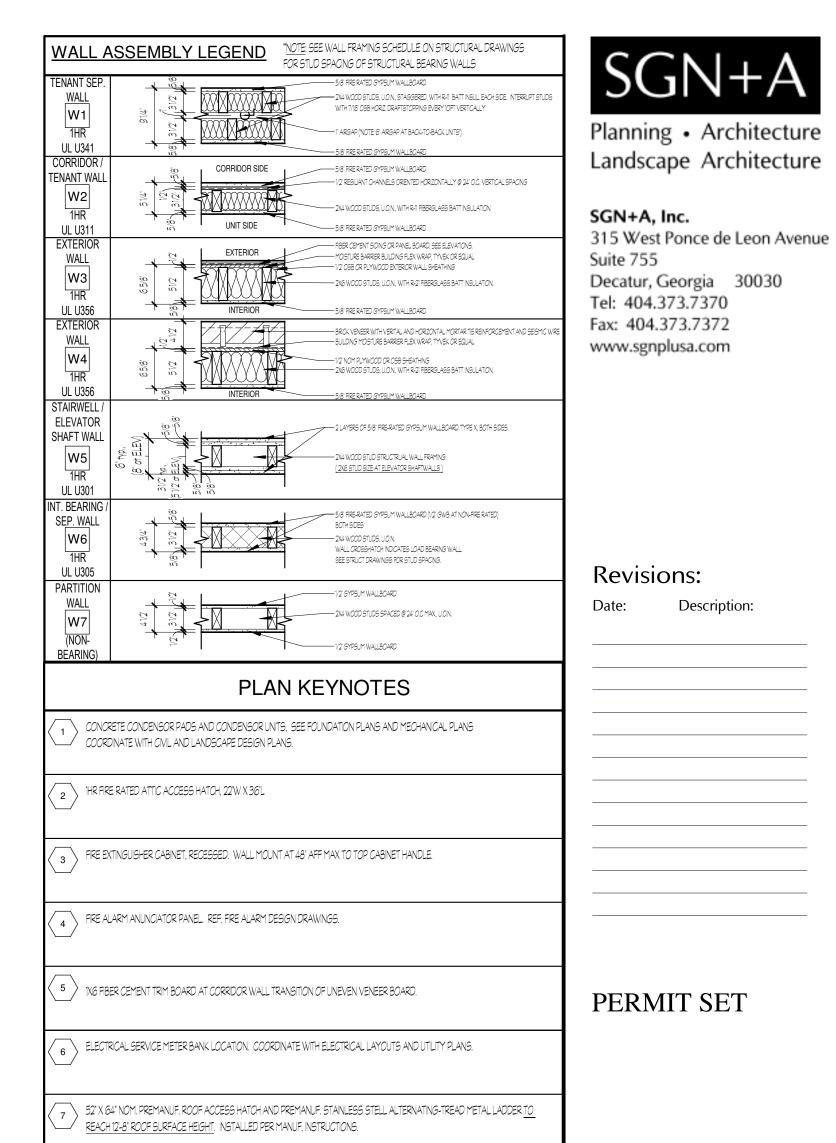
Sheet Title: BUILDING FLOOR PLANS

Date: 7 MARCH 2024

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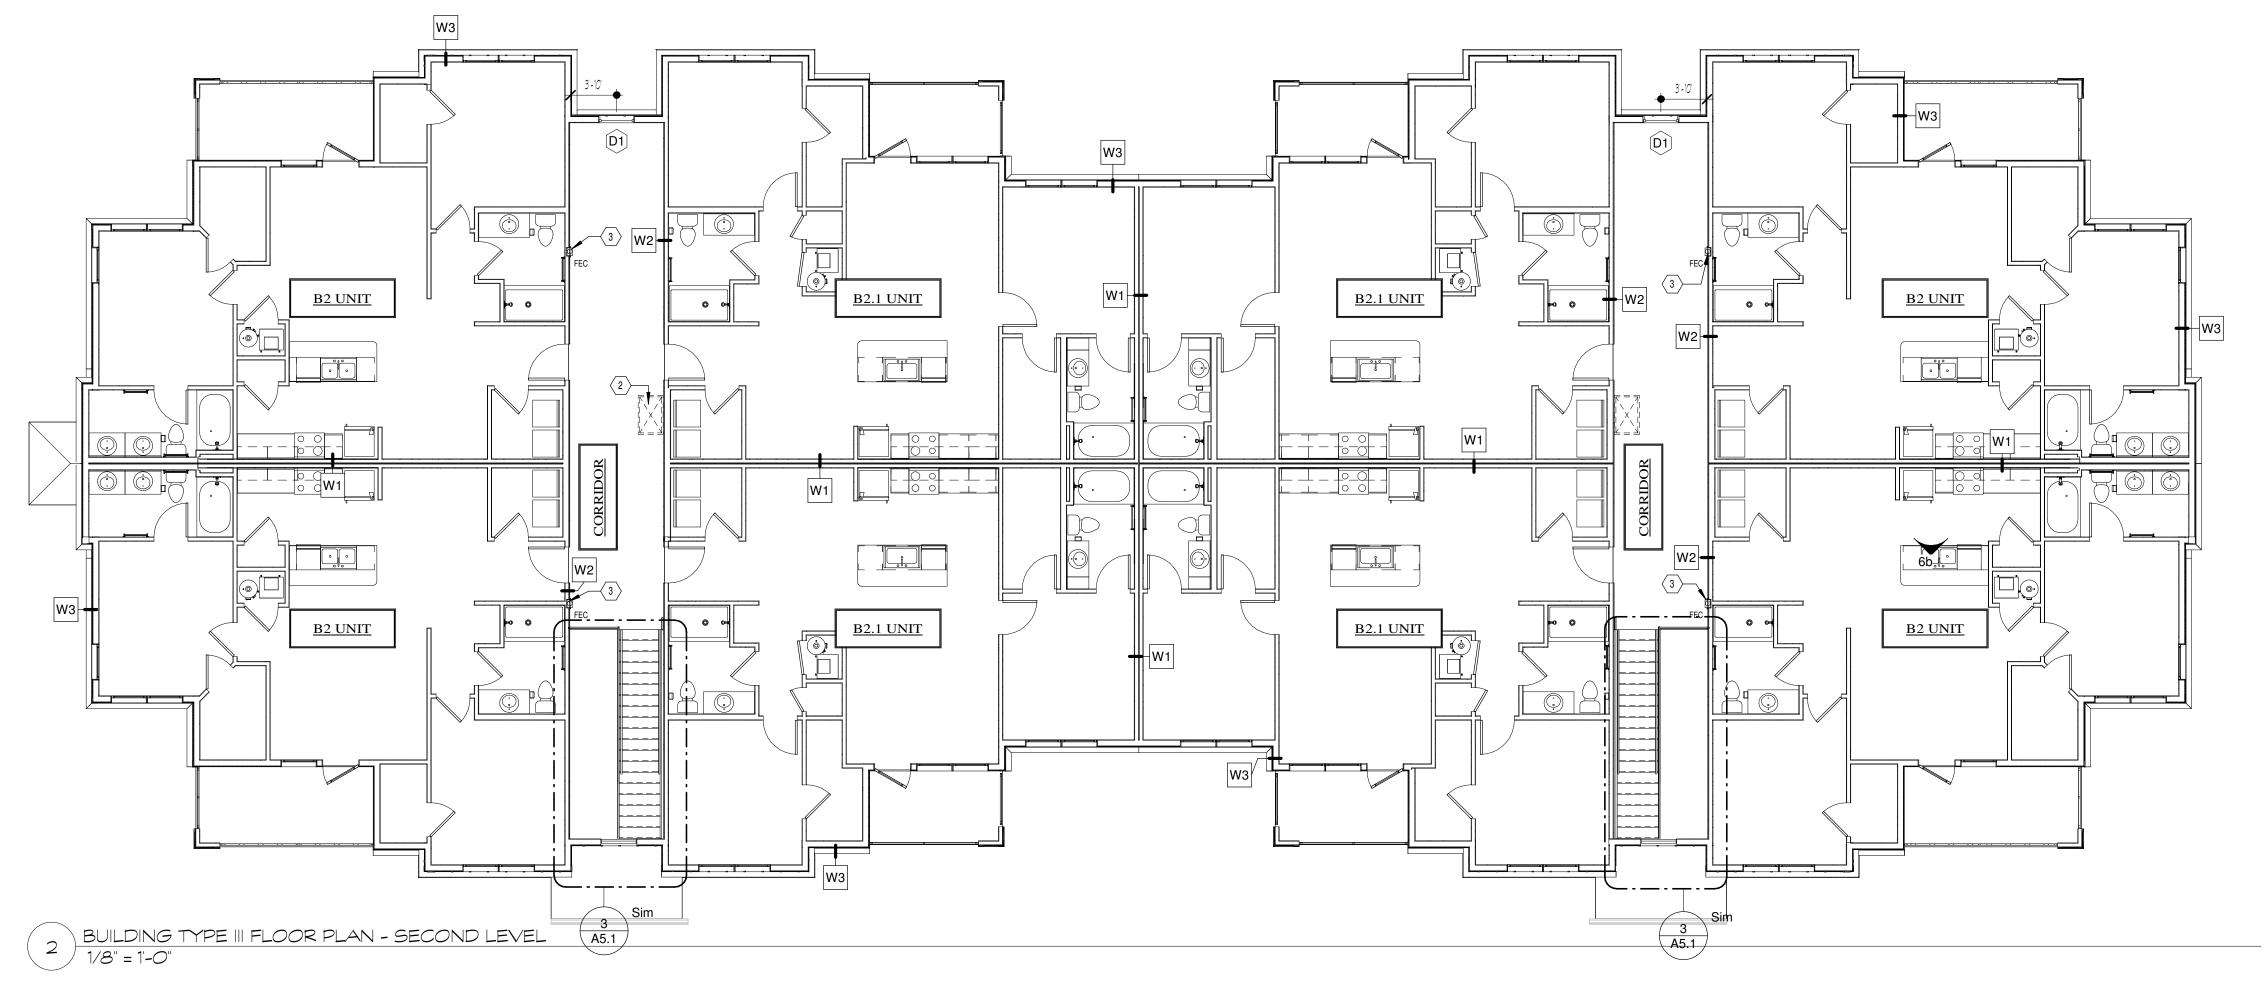
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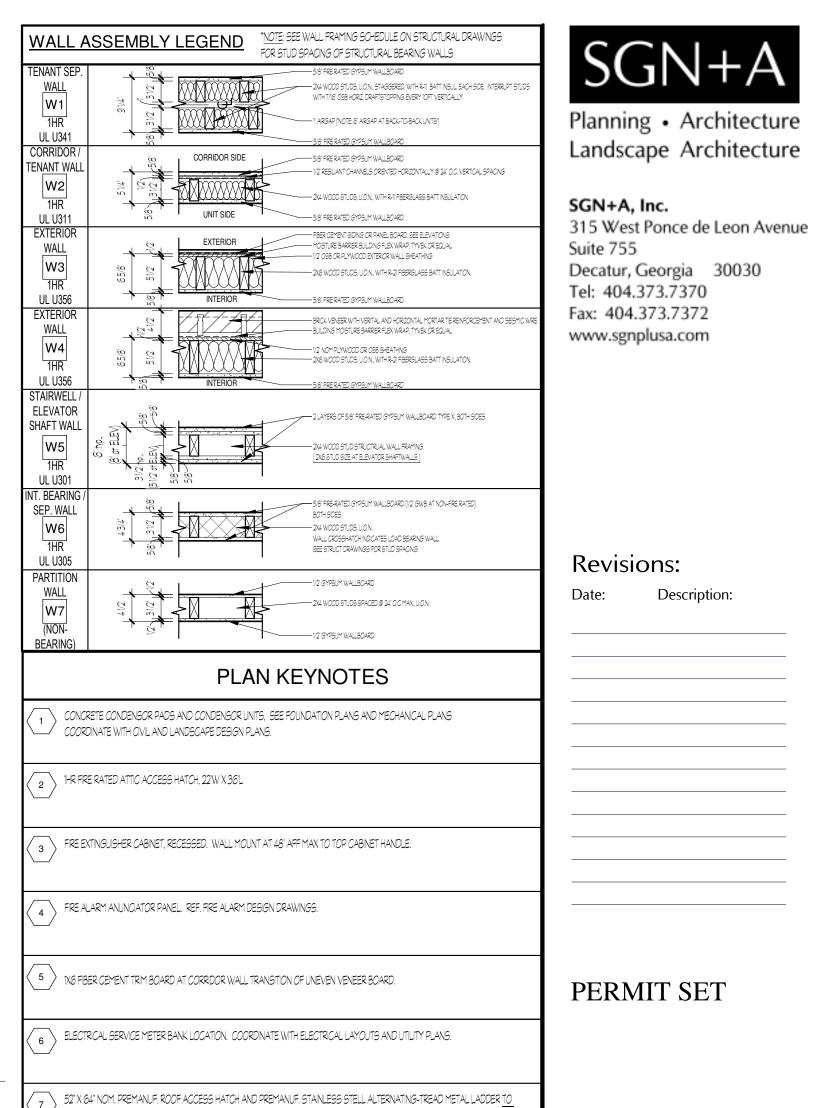
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Sheet Title: **BUILDING FLOOR PLANS**


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REACH 12-8" ROOF SURFACE HEIGHT. INSTALLED PER MANUF, INSTRUCTIONS.

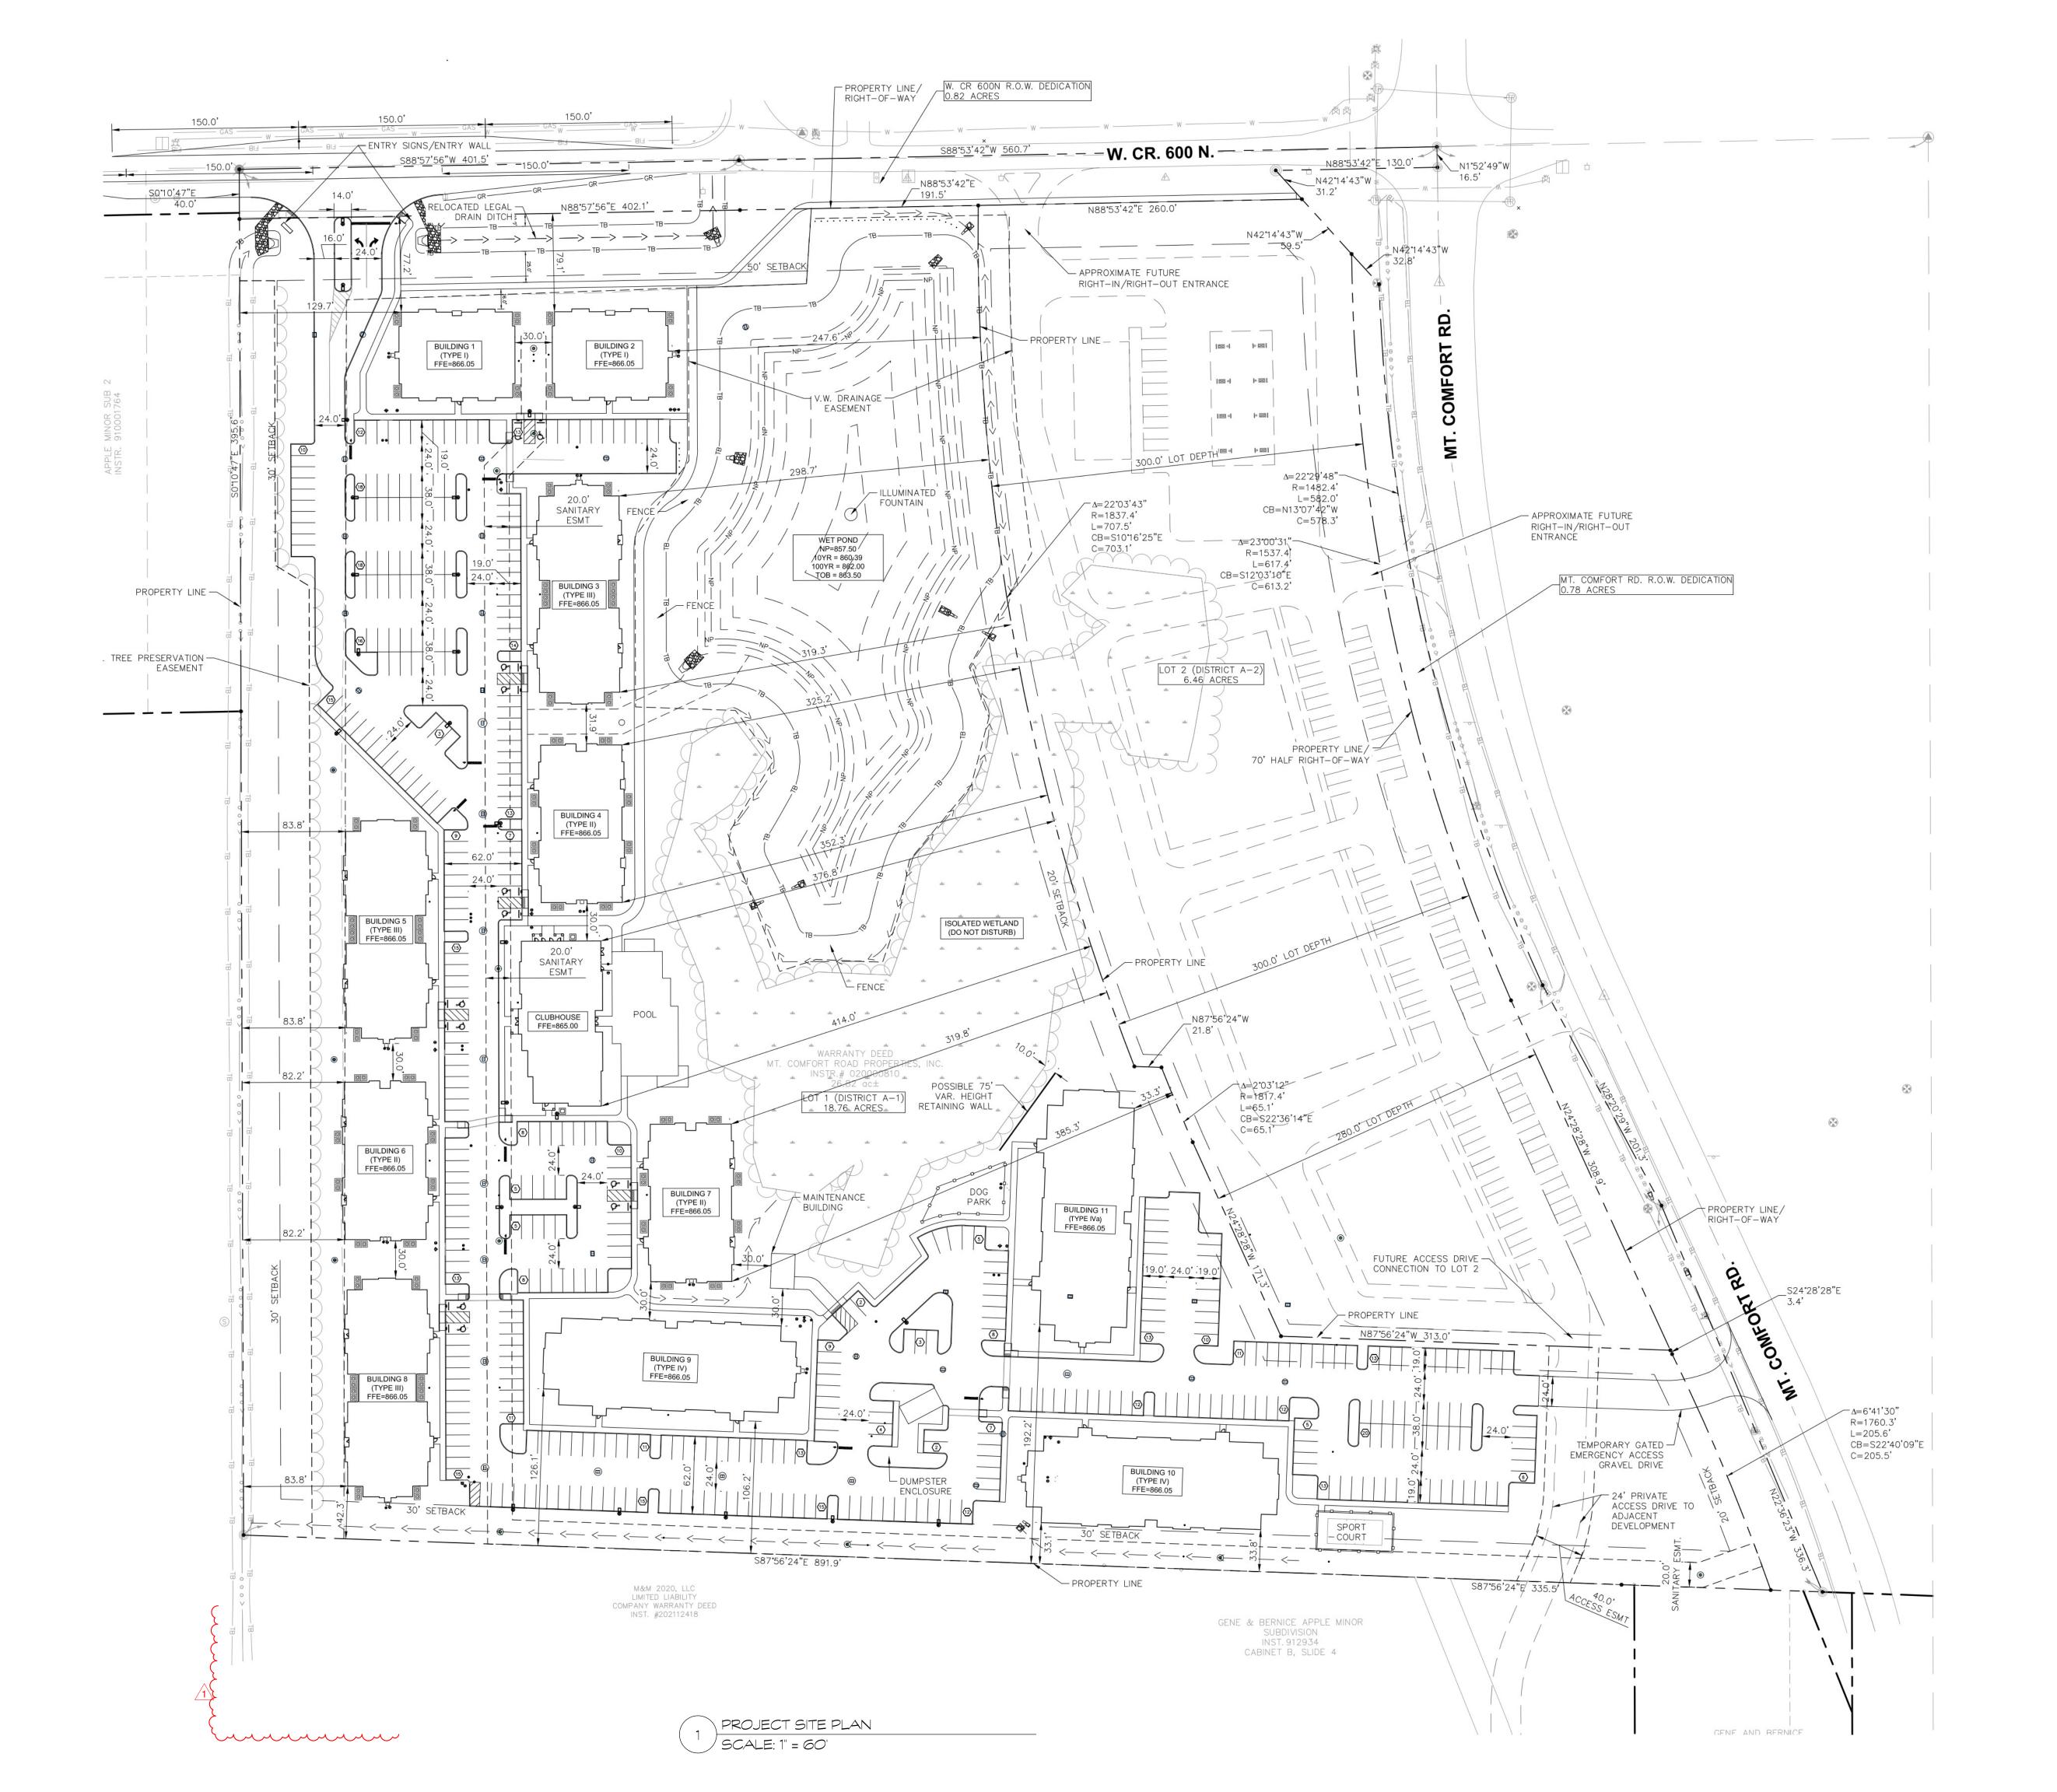

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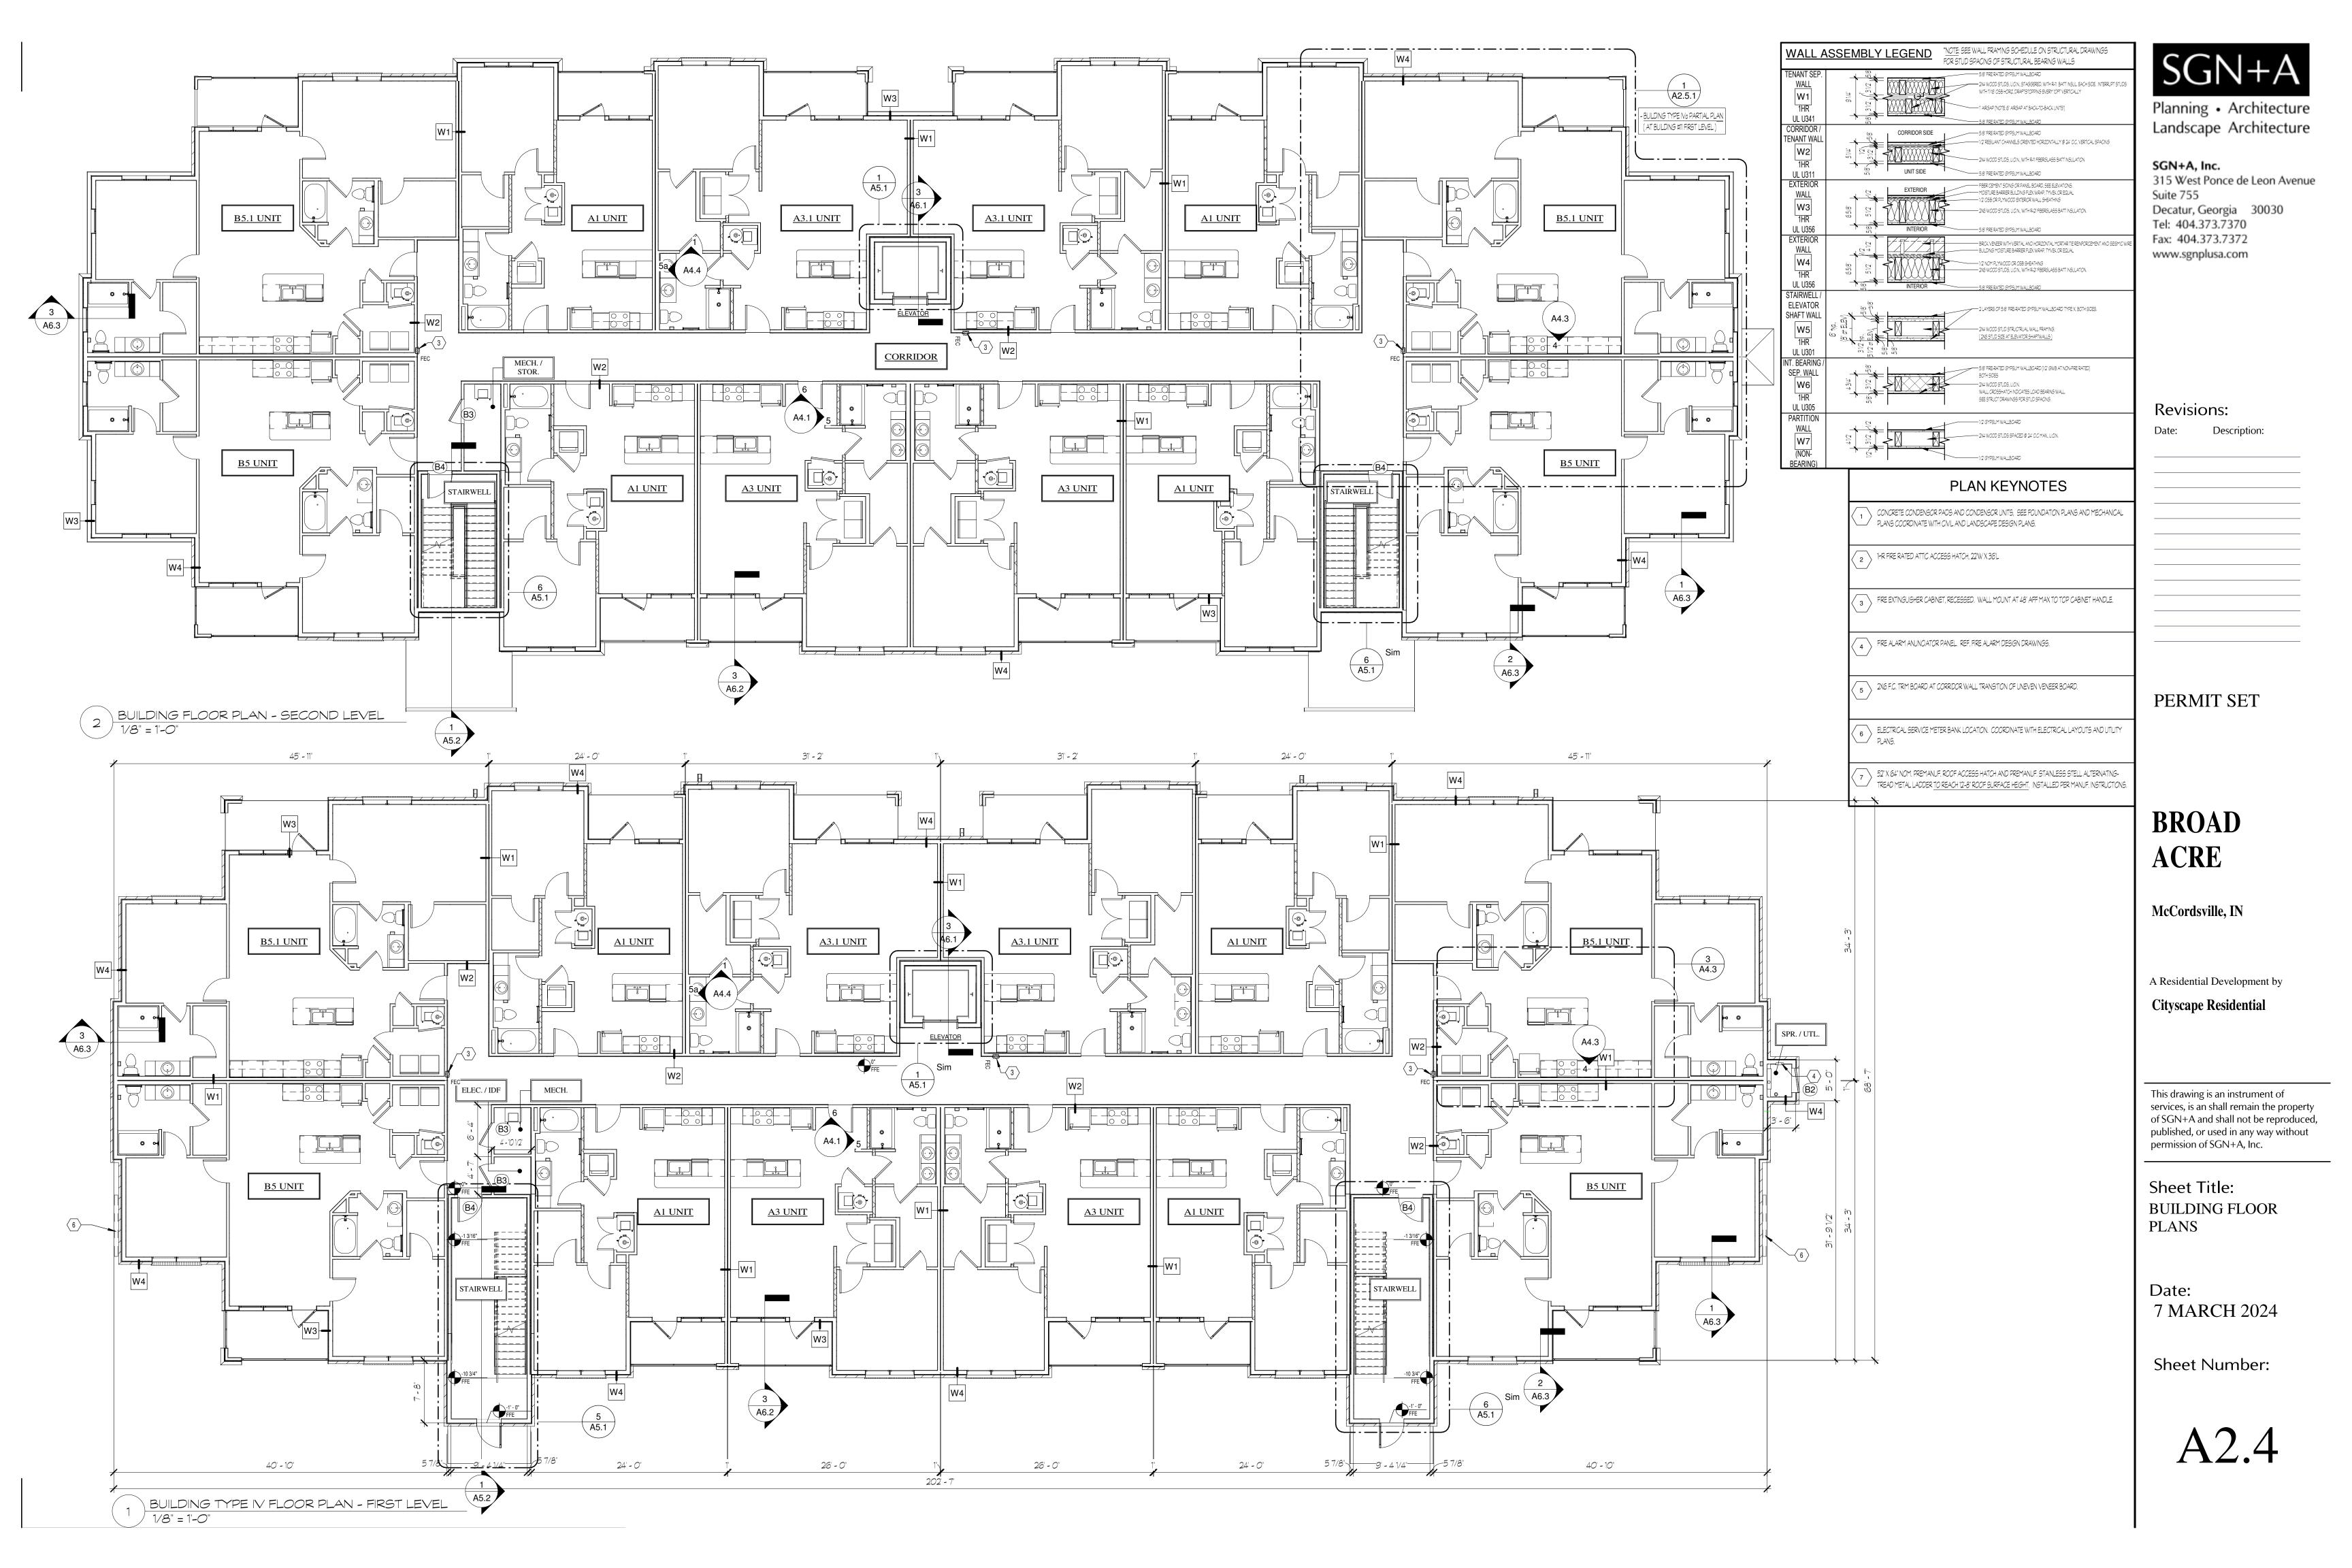
Sheet Title: **BUILDING FLOOR PLANS**

Date: 7 MARCH 2024

Sheet Number:
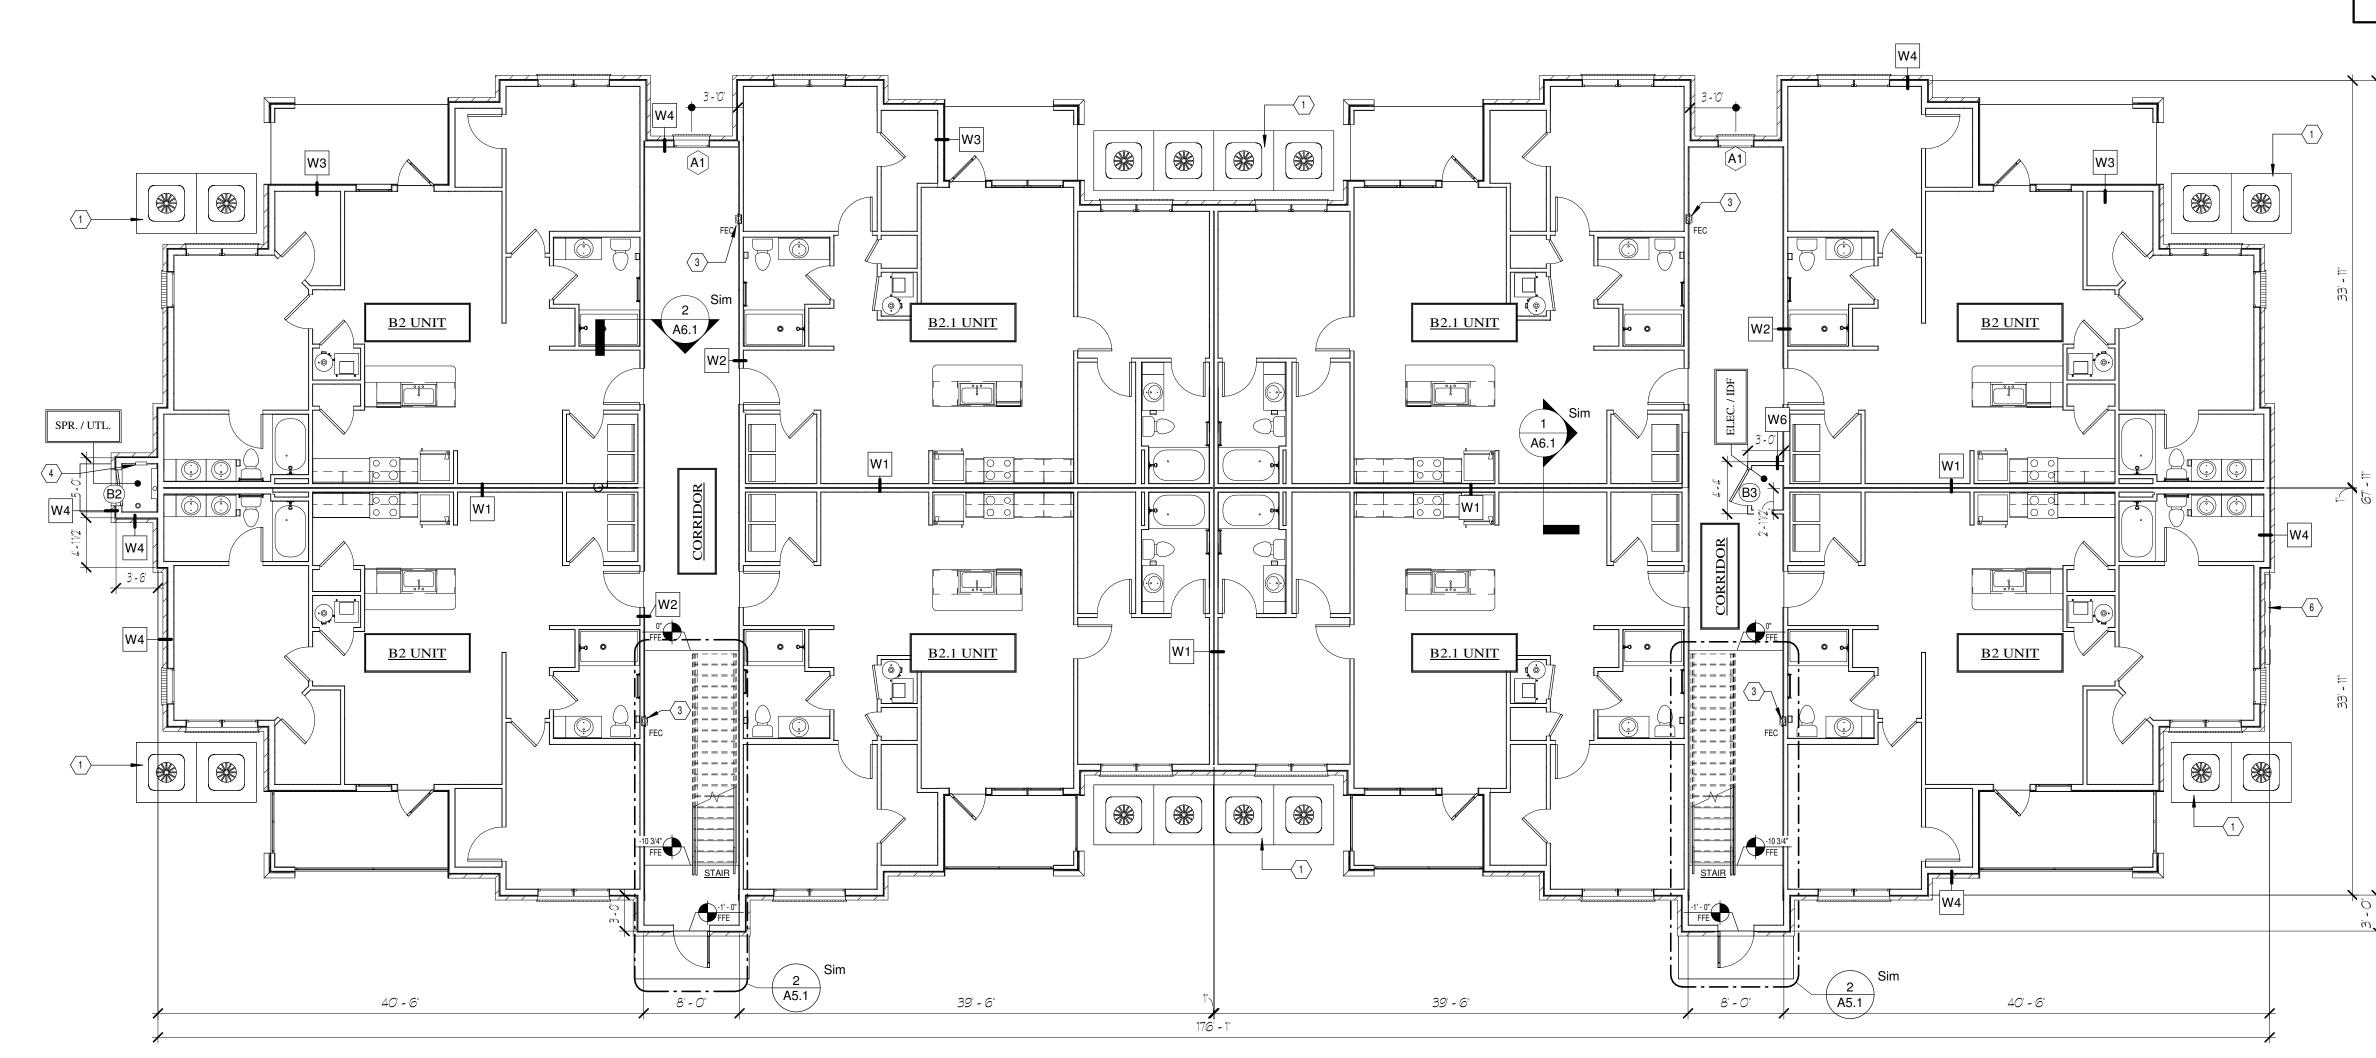
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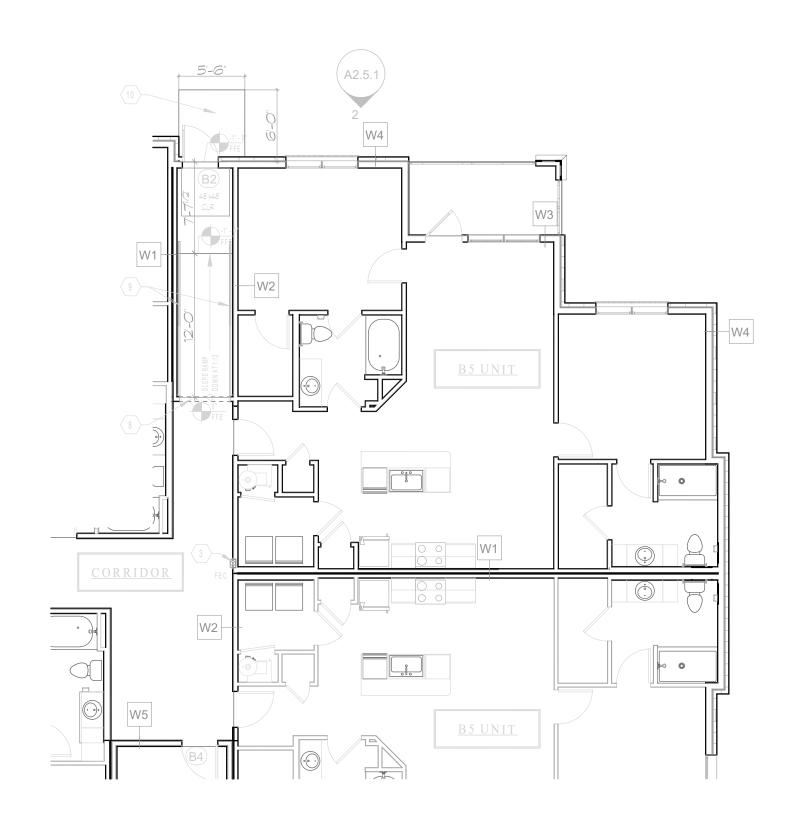
BUILDING TYPE III FLOOR PLAN - FIRST LEVEL






BUILDING TYPE IVA REAR ELEVATION (AT BUILDING #11)

Scale:3/32" = 1'-0"



BUILDING TYPE IVA PARTIAL FIRST FLOOR PLAN (AT BUILDING #11)

Scale:1/8" = 1'-0"

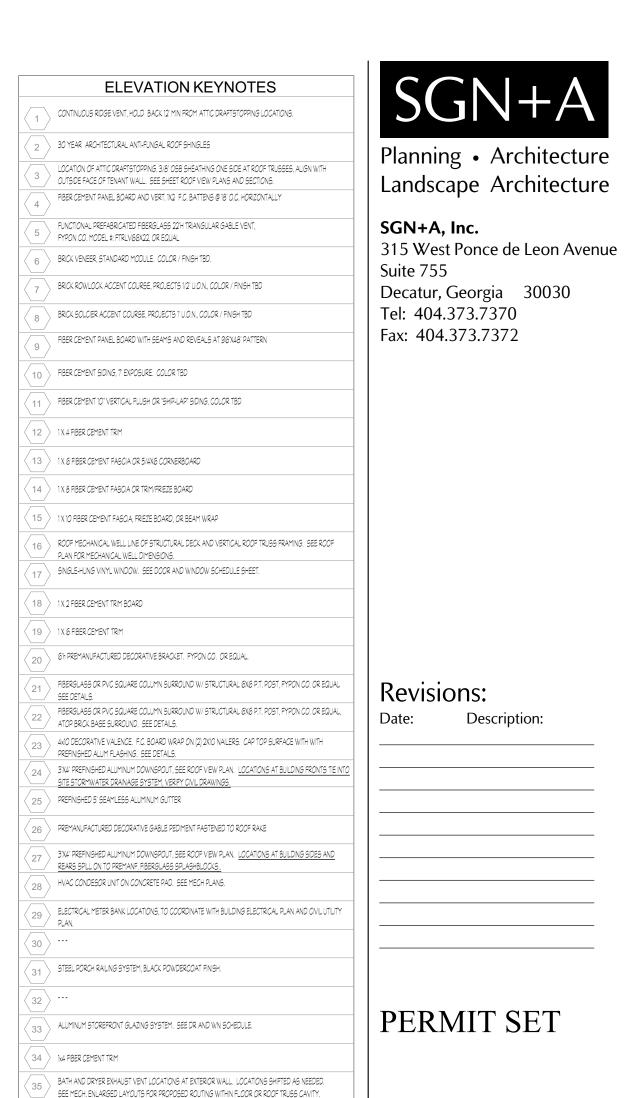

PLAN KEYNOTES

FIRE EXTINGUISHER CABINET, RECESSED. WALL MOUNT AT 48" AFF MAX TO TOP CABINET HANDLE.

ELECTRICAL SERVICE METER BANK LOCATION. COORDINATE WITH ELECTRICAL LAYOUTS AND UTILITY PLANS.

52" X 64" NOM. PREMANUF. ROOF ACCESS HATCH AND PREMANUF. STAINLESS STELL ALTERNATING-TREAD METAL LADDER TO REACH 12-8" ROOF SURFACE HEIGHT. INSTALLED PER MANUF. INSTRUCTIONS.

FIRE ALARM ANUNCIATOR PANEL. REF. FIRE ALARM DESIGN DRAWINGS.

4'0"w x 6'8"h CASED OPENING IN TYPICAL STUD

2X6 F.C. TRIM BOARD AT CORRIDOR WALL TRANSITION OF UNEVEN VENEER BOARD.

1-1/2" DIA. GRASPABLE METAL HANDRAIL @ 36"h CONTINUOUS BOTH

4* CONCRETE PORCH SLAB, SLOPES 1/4:12 TO RUNOFF, U.O.N. SEE STRUCTURAL FOUNDATION PLANS.

CONCRETE CONDENSOR PADS AND CONDENSOR UNITS, SEE FOUNDATION PLANS AND MECHANICAL PLANS COORDINATE WITH CIVILAND LANDCAPING PLANS.

BROAD ACRE

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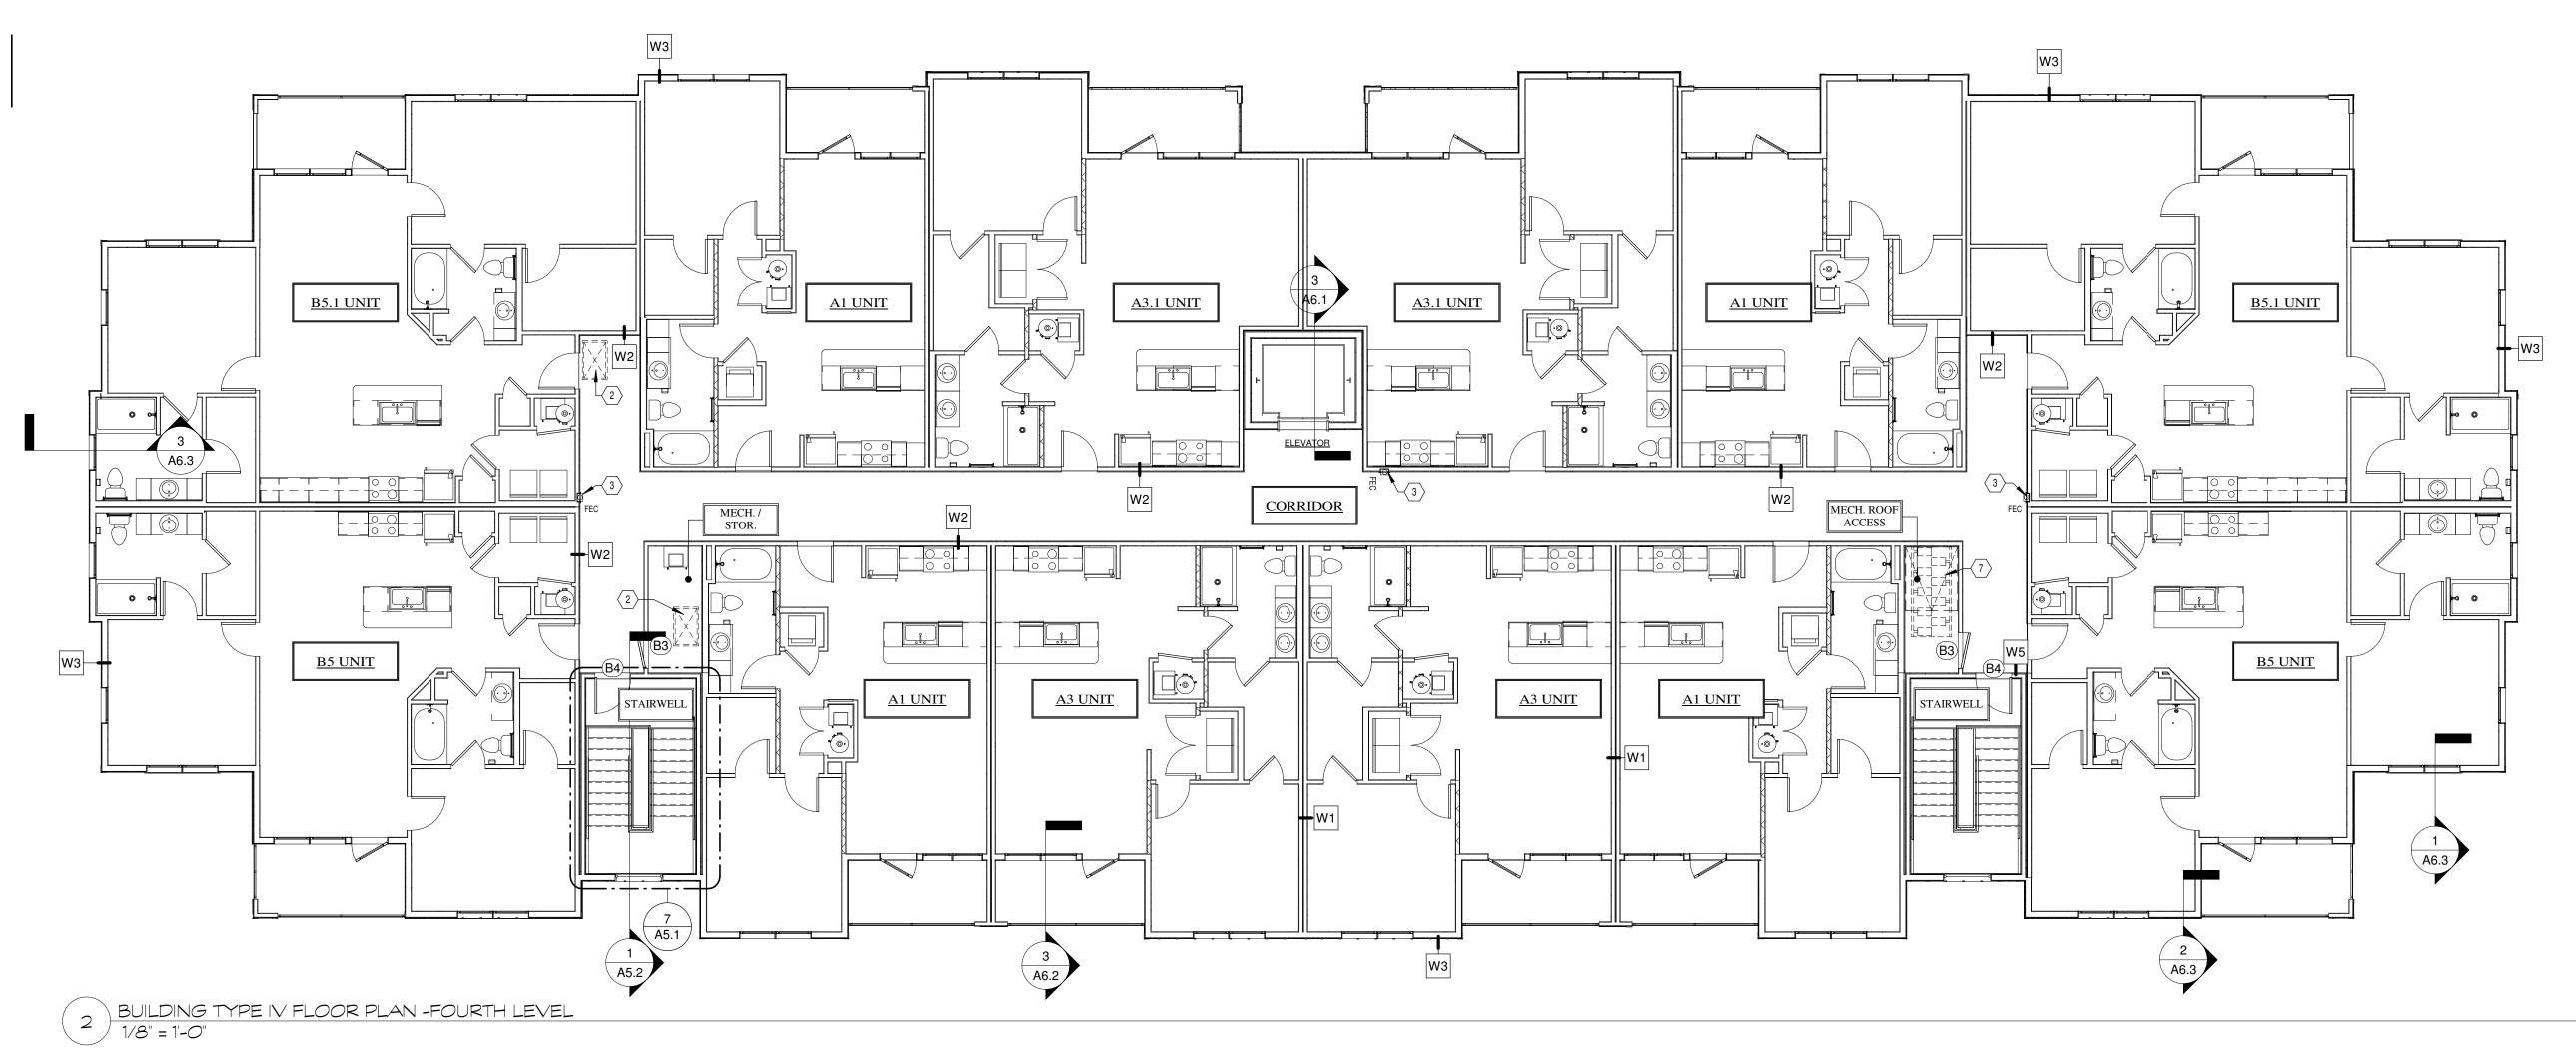
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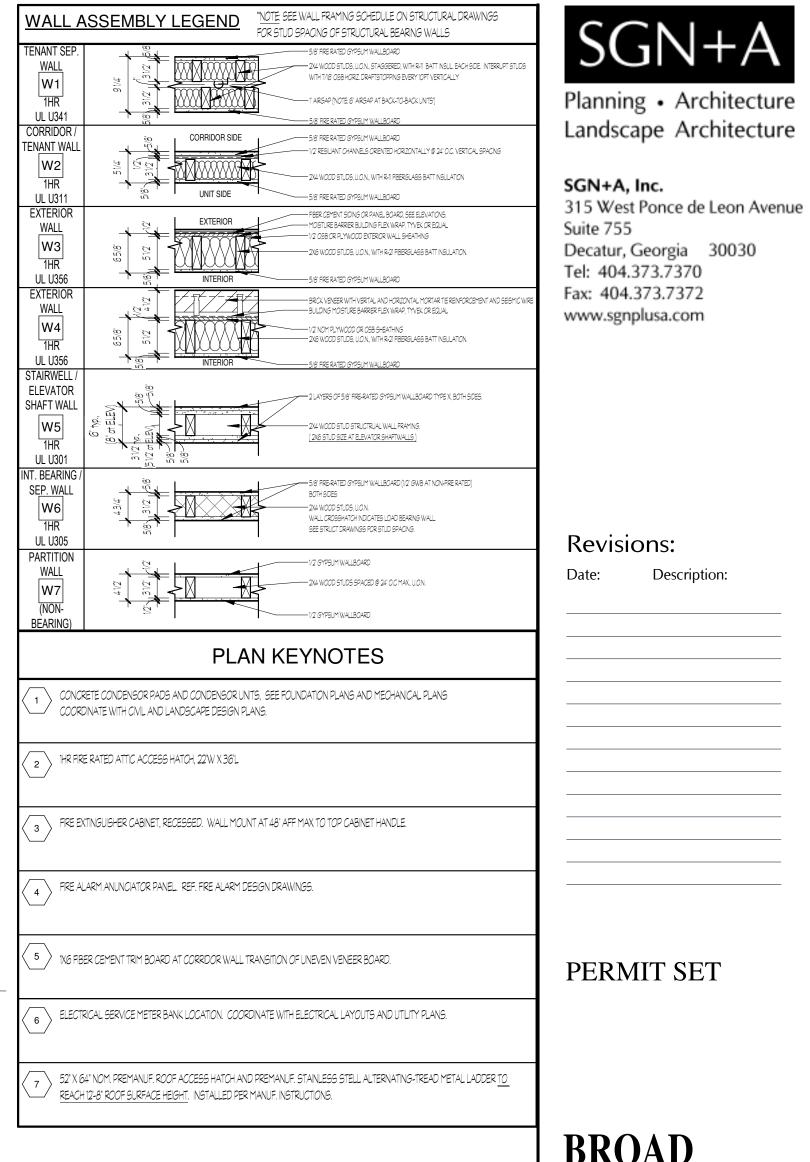
Sheet Title: BUILDING IVa PARTIAL PLAN AND REAR BUILDING ELEVATION

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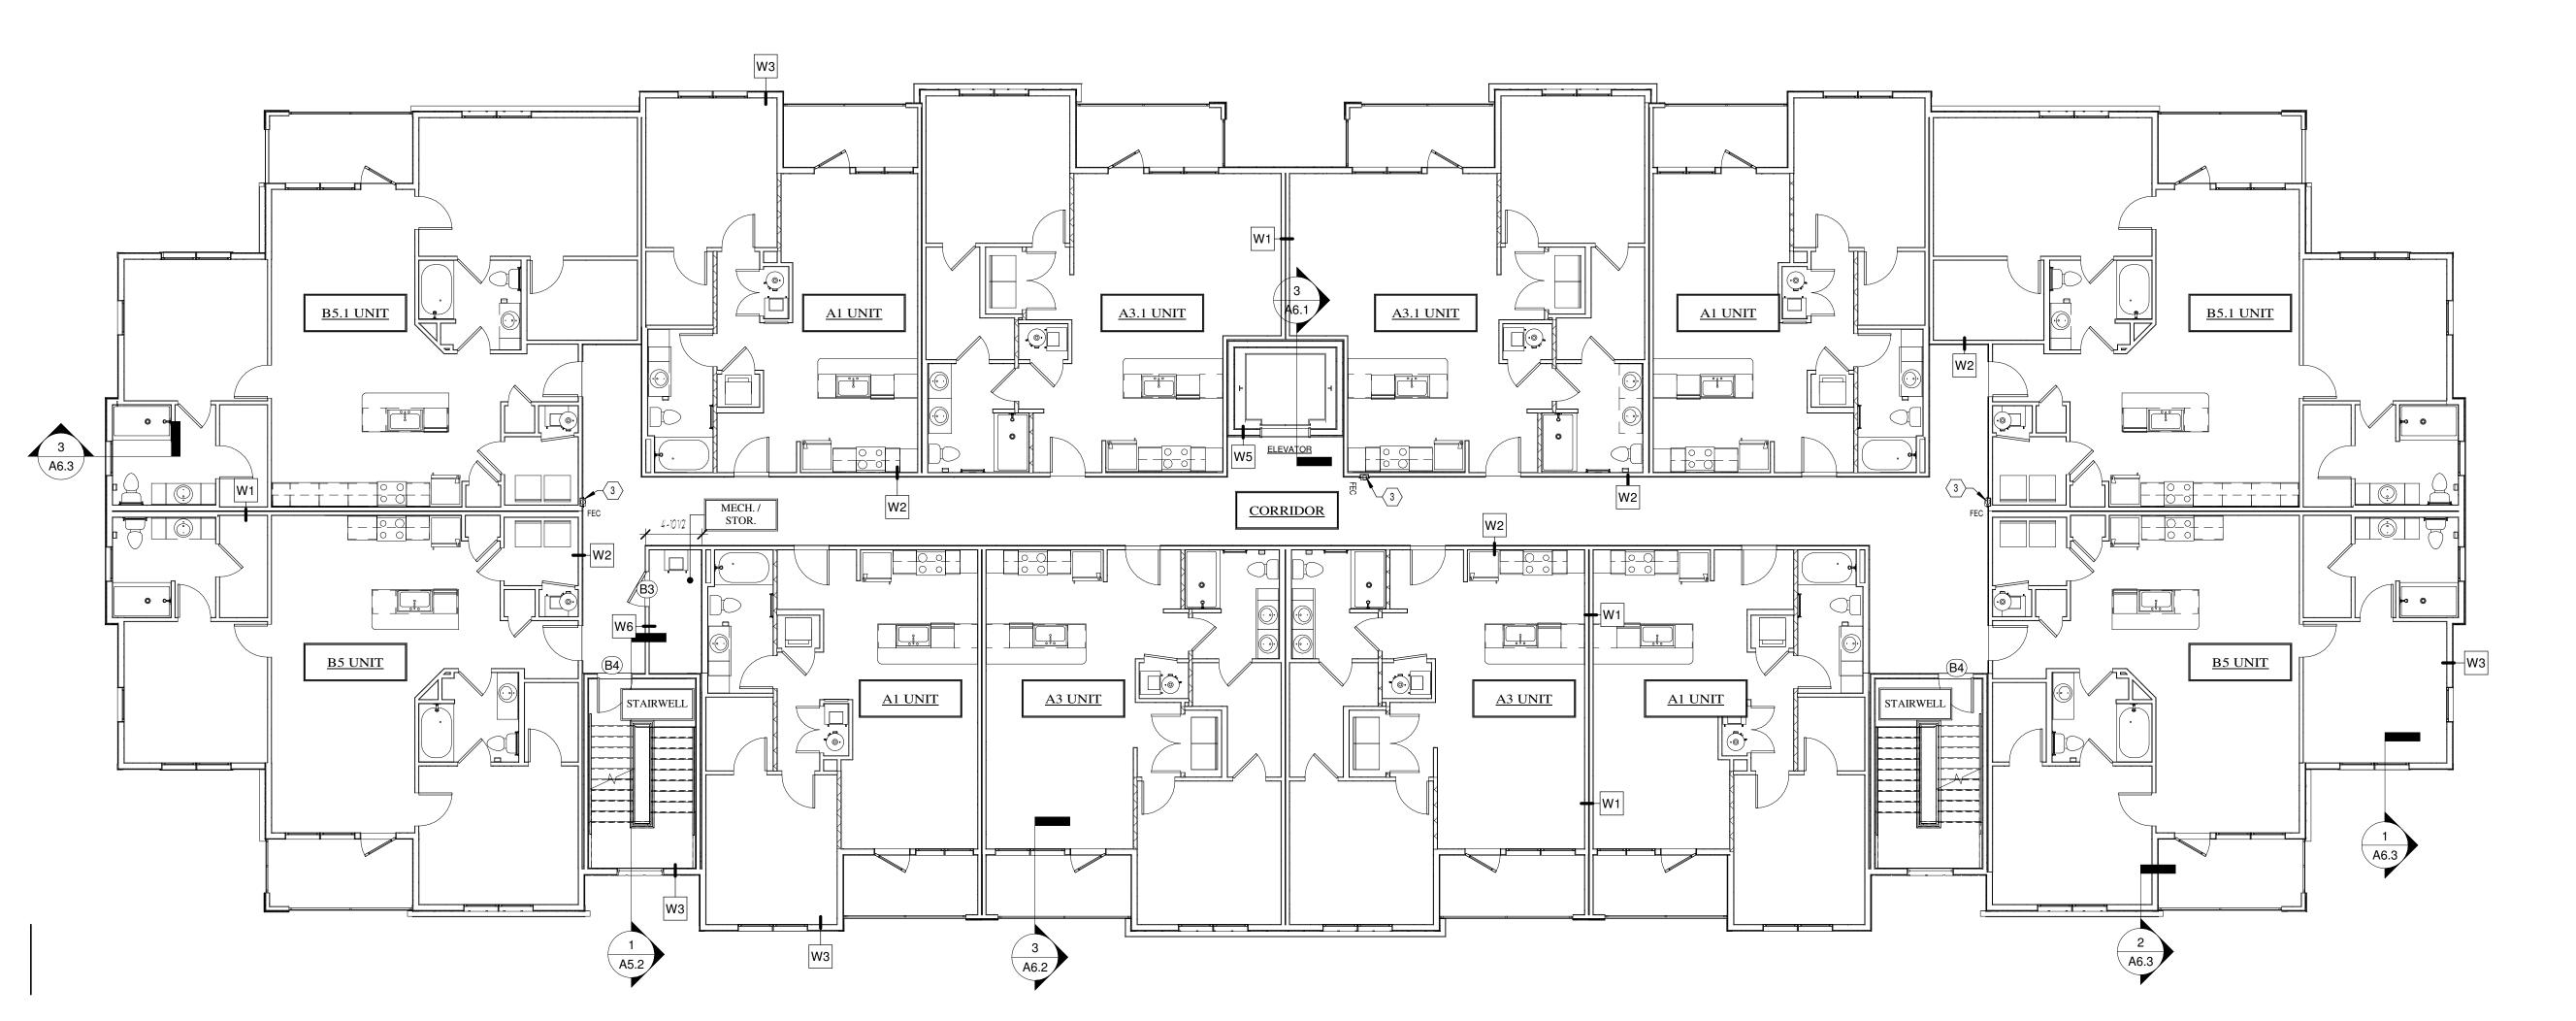
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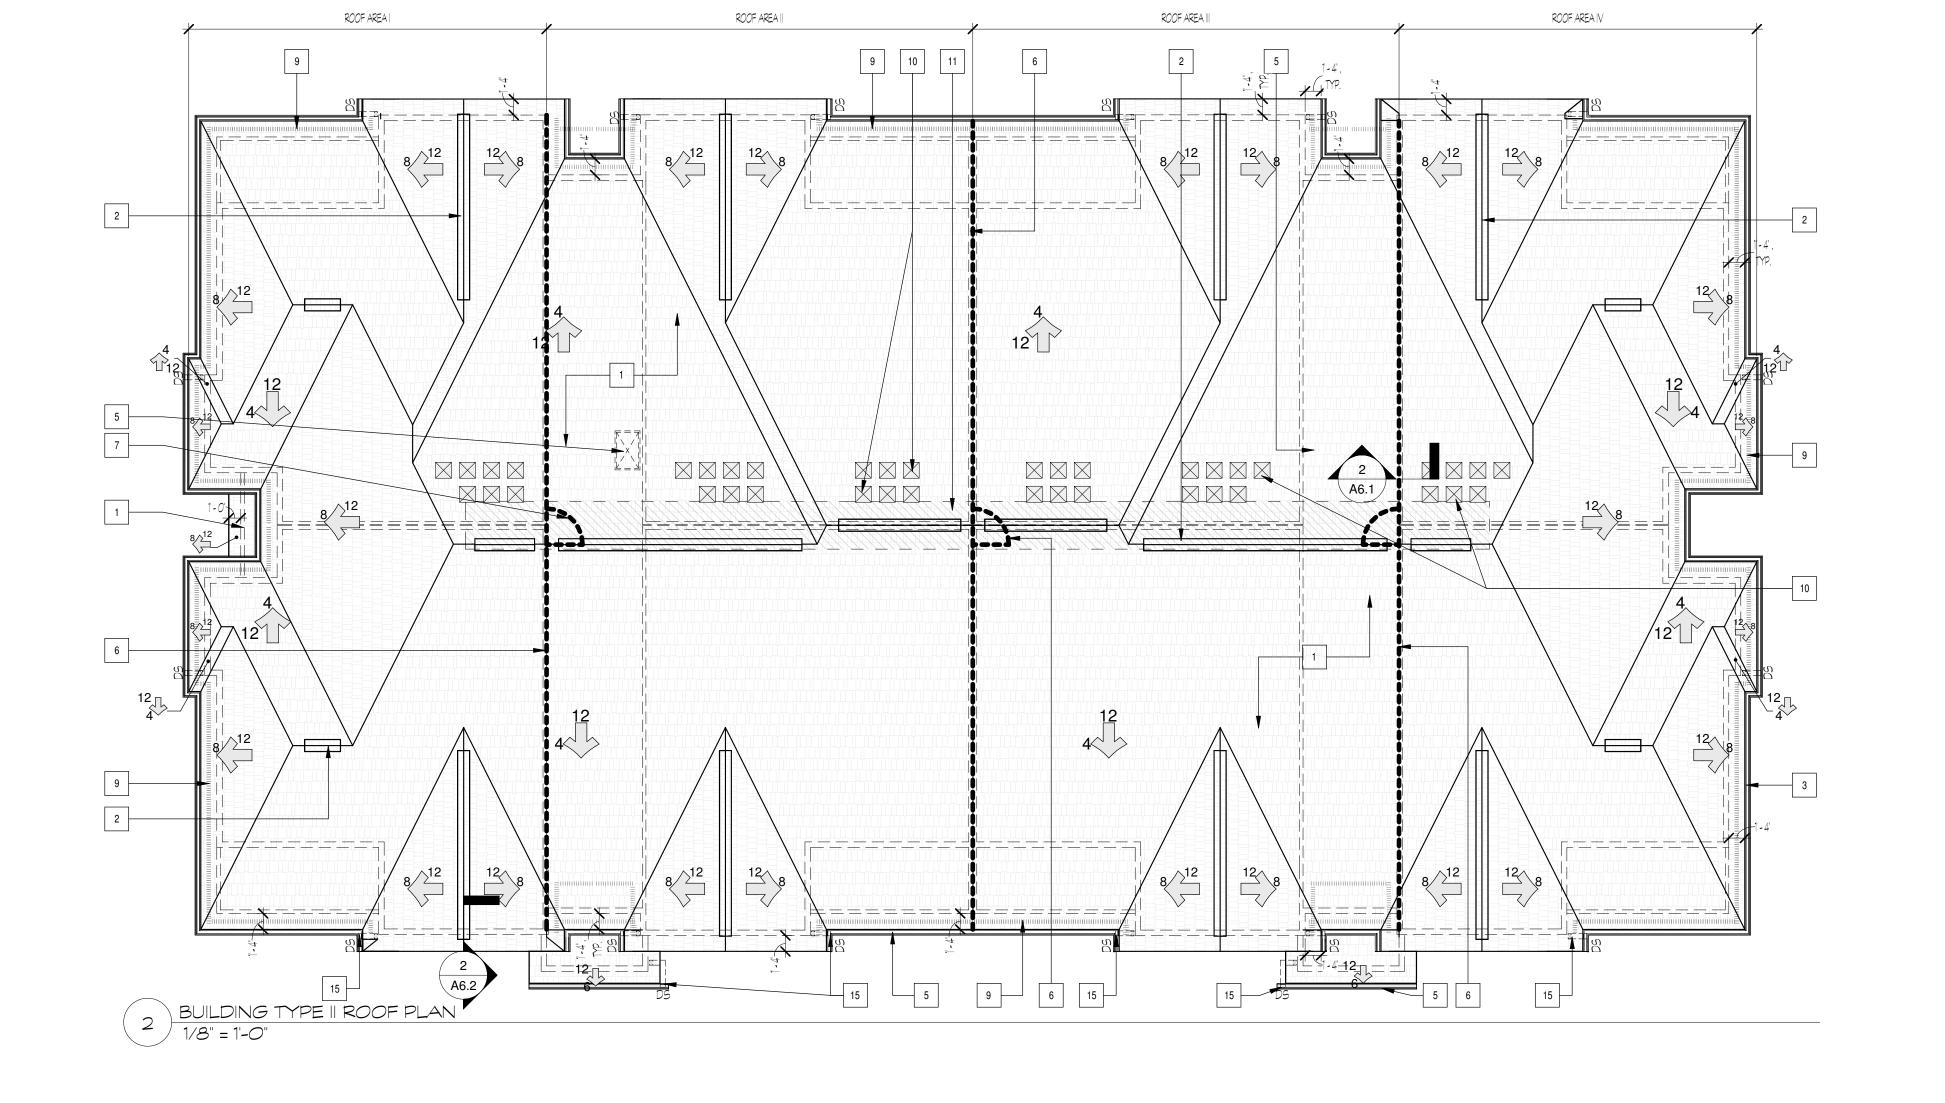
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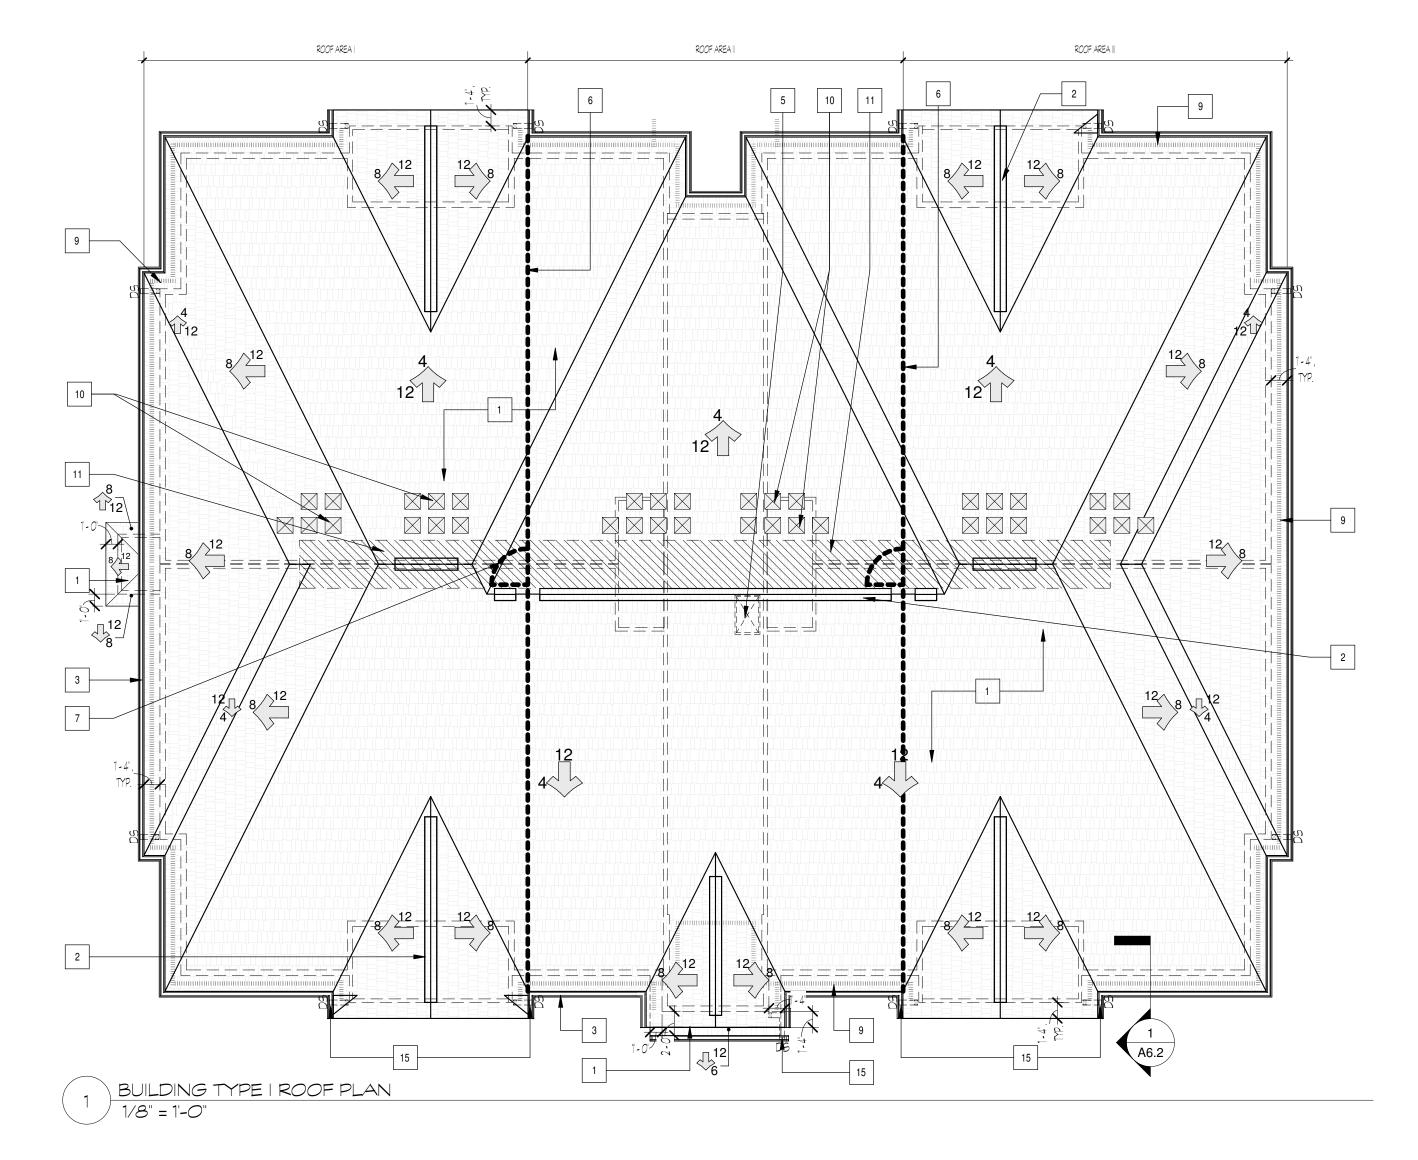
Sheet Title: **BUILDING FLOOR PLANS**

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ROOF PLAN KEYNOTES 30 YEAR ARCHITECTURAL ANTI-FUNGAL ROOF SHINGLES Planning • Architecture CONTINUOUS RIDGE VENT, INSTALL PER MANUFACTURER INSTRUCTIONS. TO PROVIDE 14.8 SQ IN MIN OF NET FREE-AIR VENTILATION PER LINEAR FT. Landscape Architecture PREFINISHED 5' SEAMLESS ALUMINMUM GUTTER AND DOWNSPOUTS. SEE ELEVATIONS. COORDINATE DOWNSPOUTS WITH STORMWATER DRAINAGE CONNECTIONS, SEE CIVIL DRAWINGS. 4 CONDENSOR UNITS FOR MECHANICAL HVAC SYSTEMS MOUNTED ATOP P.T. TIMBERS SET ON LOW SLOPE ROOF SURFACE. SEE DETAILS. SGN+A, Inc. 315 West Ponce de Leon Avenue 1HR FIRE RATED ATTIC ACCESS HATCH, 22'W X 36"L Suite 755 Decatur, Georgia 30030 LOCATION OF ATTIC DRAFTSTOPPING. 3/8' OSB SHEATHING ONE SIDE AT ROOF TRUSSES, AUGN WITH OUTSIDE FACE OF Tel: 404.373.7370 TENANT WALL. SEE SHEET A6.X Fax: 404.373.7372 ACCESS DOOR THROUGH DRAFTSTOPPING. SEE DTL 14/A6.10. www.sgnplusa.com SINGLE PLY TPO ROOF MEMBRANE AT LOW SLOPE ROOF PLANE 9 PERFORATED 3/16' FIBER CEMENT SOFFIT VENT LOCATIONS. TO PROVIDE 15 SQ IN MIN OF NET FREE-AIR VENTILATION PER LINEAR FT. PREMANFUCTURED SURFACE MOUNTED ROOF VENTS, TO PROVIDE 144 SQ IN MIN OF NET FREE-AIR VENTILATION EA PROVIDE QUANITY AS INDICATED BY ROOF AREA VENTILATION CALCULATIONS. 4f WIDE BUILT CATWALK IN ATTIC. 5/8' APA SPAN RATED PLYWOOD FASTENED OVER BOTTOM CHORDS OF ROOF TRUSSES. NAILERS AND BLOCKING AS NEEDED. 4' ROOF DRAIN AND OVERFLOW DRAIN RAINWATER DRAIN PIPES ROUTED THROU ROOF TRUSS CAVITY AT 1:12 MIN SLOPE, TYP. Revisions: ROOF DRAIN DOWNPIPE IN EXT. STUD WALL. SEE BUILDING ELEVATIONS FOR OUTLET LOCATIONS AT BOT. OF EXT. WALL. Date: Description: 14 ROOF DRAIN OVERFLOW OUTLET AT ROOF SOFFIT DOWNSPOUTS AT FRONT OF BUILDING ONLY TIE TO UNDERGROUND STORMWATER MGMT SYSTEM. OTHERWISE TYPICALLY SPILL OUT ON PREFAB. FIBERGLASS SPLASH BLOCKS ON FINISHED GRADE. FACE OF STUD BEARING WALL AND/OR BEAM BELOW ROOF

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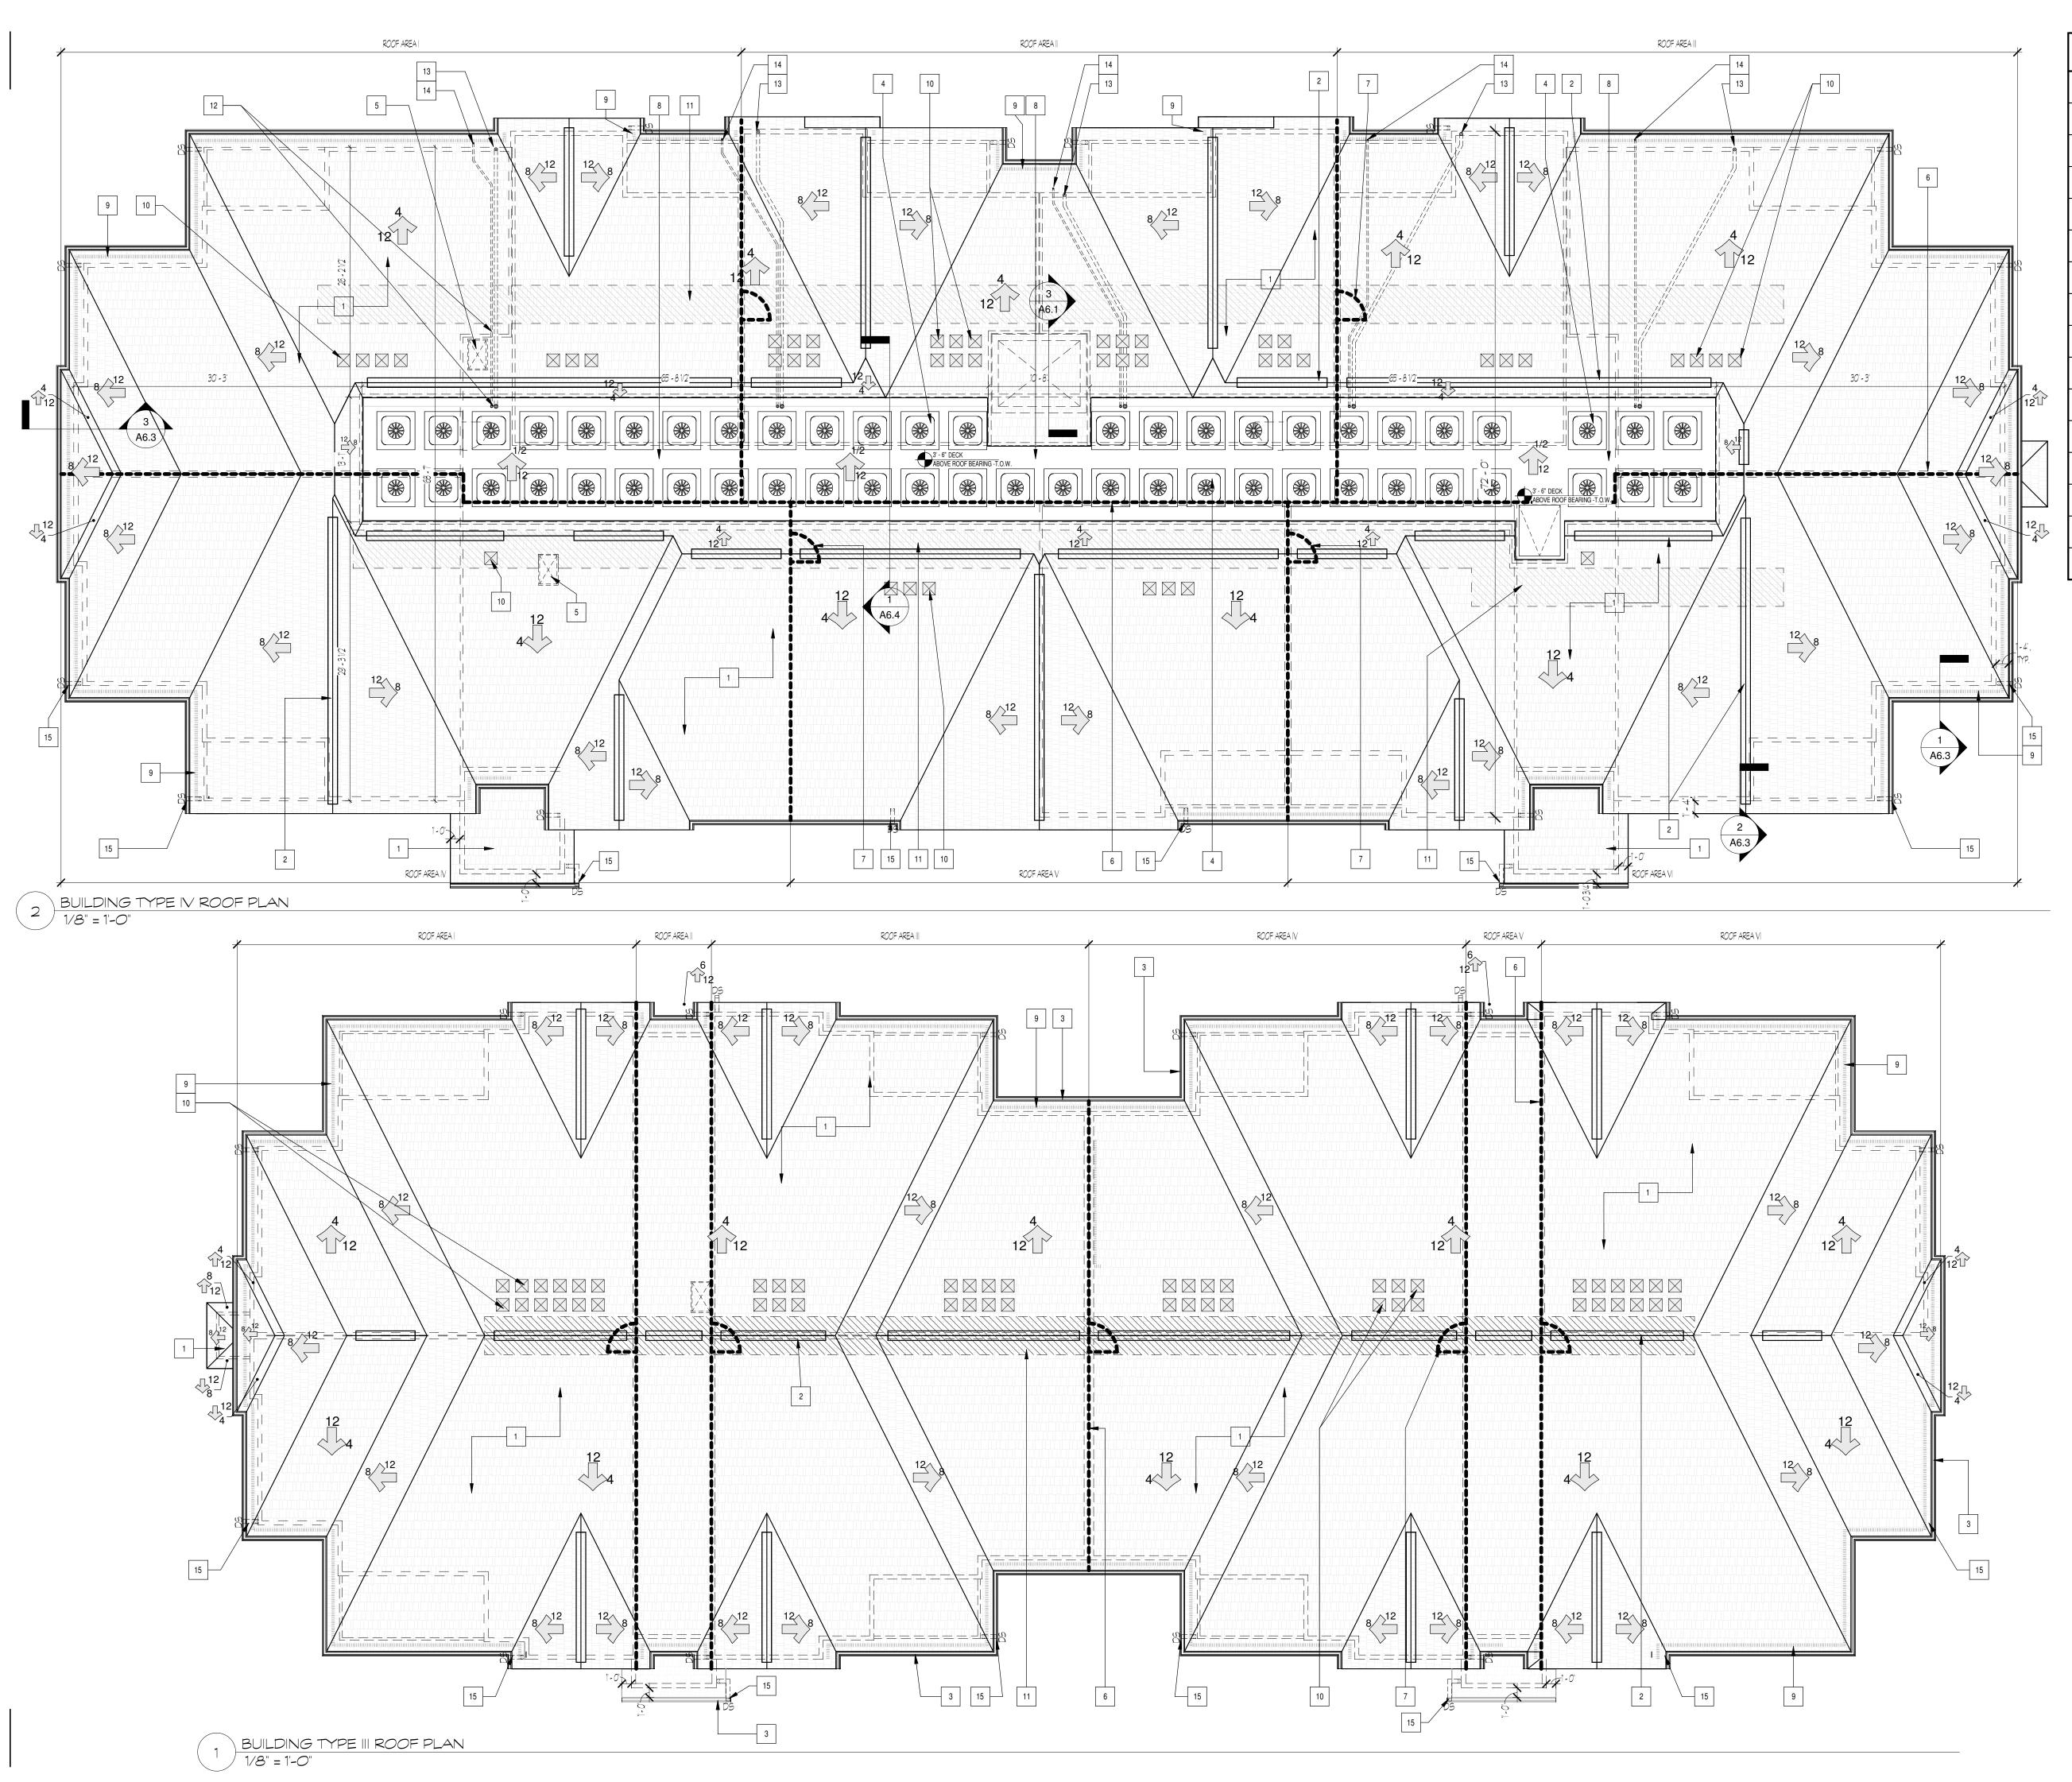
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Sheet Title: ROOF PLANS

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ROOF PLAN KEYNOTES

- 30 YEAR ARCHITECTURAL ANTI-FUNGAL ROOF SHINGLES
- CONTINUOUS RIDGE VENT, INSTALL PER MANUFACTURER INSTRUCTIONS.
 TO PROVIDE 14.8 SQ IN MIN OF NET FREE-AIR VENTILATION PER LINEAR FT.
- PREFINISHED 5' SEAMLESS ALUMINMUM GUTTER AND DOWNSPOUTS. SEE ELEVATIONS.

 COORDINATE DOWNSPOUTS WITH STORMWATER DRAINAGE CONNECTIONS, SEE CIVIL DRAWINGS.
- CONDENSOR UNITS FOR MECHANICAL HVAC SYSTEMS MOUNTED ATOP P.T. TIMBERS SET ON LOW SLOPE ROOF SURFACE.

 SEE DETAILS.
- 5 1HR FIRE RATED ATTIC ACCESS HATCH, 22'W X 36'L
- 6 LOCATION OF ATTIC DRAFTSTOPPING. 3/8' OSB SHEATHING ONE SIDE AT ROOF TRUSSES, ALIGN WITH OUTSIDE FACE OF TENANT WALL. SEE SHEET AGX
- ACCESS DOOR THROUGH DRAFTSTOPPING. SEE DTL 14/A6.10.
- SINGLE PLY TPO ROOF MEMBRANE AT LOW SLOPE ROOF PLANE
- PERFORATED 3/16' FIBER CEMENT SOFFIT VENT LOCATIONS.

 TO PROVIDE 15 SQ IN MIN OF NET FREE-AIR VENTILATION PER LINEAR FT.
- PREMANFLICTURED SURFACE MOUNTED ROOF VENTS, TO PROVIDE 144 SQ IN MIN OF NET FREE-AIR VENTILATION EA.
- oxed PROVIDE QUANITY AS INDICATED BY ROOF AREA VENTILATION CALCULATIONS.
- 46 WIDE BUILT CATWALK IN ATTIC. 5/8' APA SPAN RATED PLYWOOD FASTENED OVER BOTTOM CHORDS OF ROOF TRUSSES. NAILERS AND BLOCKING AS NEEDED.
- 4' ROOF DRAIN AND OVERFLOW DRAIN RAINWATER DRAIN PIPES ROUTED THROU ROOF TRUSS CAVITY AT 1:12 MIN SLOPE, TYP.
- ROOF DRAIN DOWNPIPE IN EXT. STUD WALL. SEE BUILDING ELEVATIONS FOR OUTLET LOCATIONS AT BOT. OF EXT. WALL.
- ROOF DRAIN OVERFLOW OUTLET AT ROOF SOFFIT
- DOWNSPOUTS AT FRONT OF BUILDING ONLY TIE TO UNDERGROUND STORMWATER MGMT SYSTEM.
 OTHERWISE TYPICALLY SPILL OUT ON PREFAB. FIBERGLAGS SPLAGH BLOCKS ON FINISHED GRADE.
- FACE OF STUD BEARING WALL AND/OR BEAM BELOW ROOF

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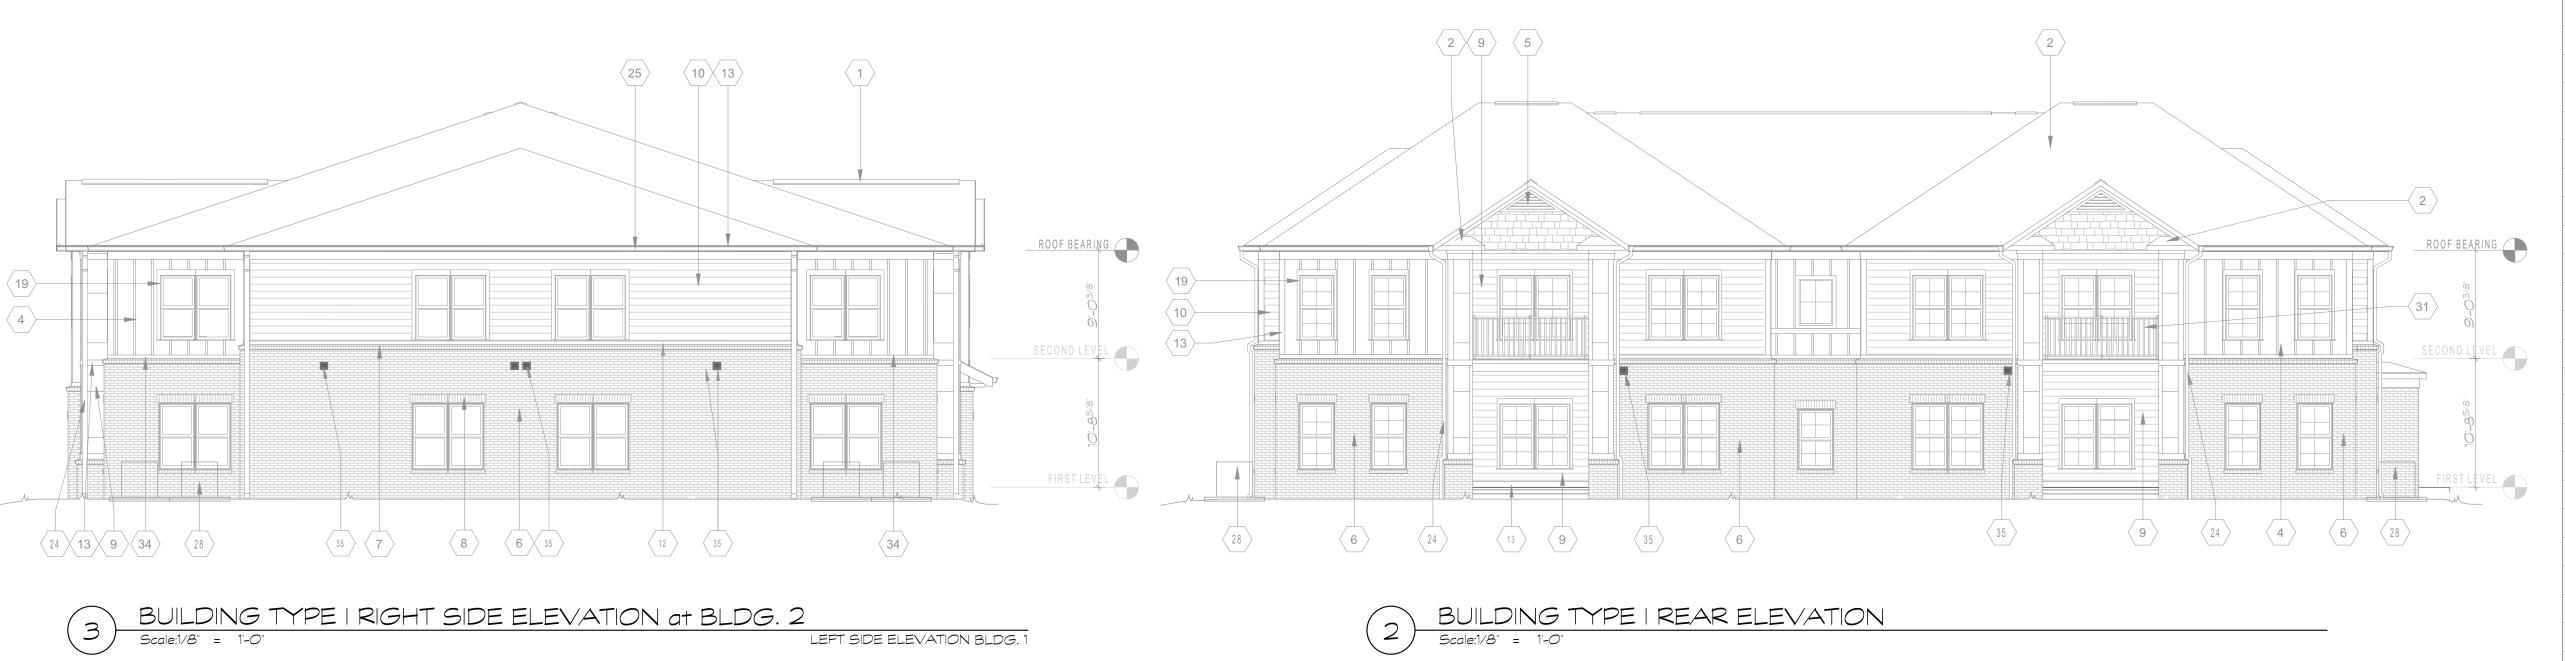
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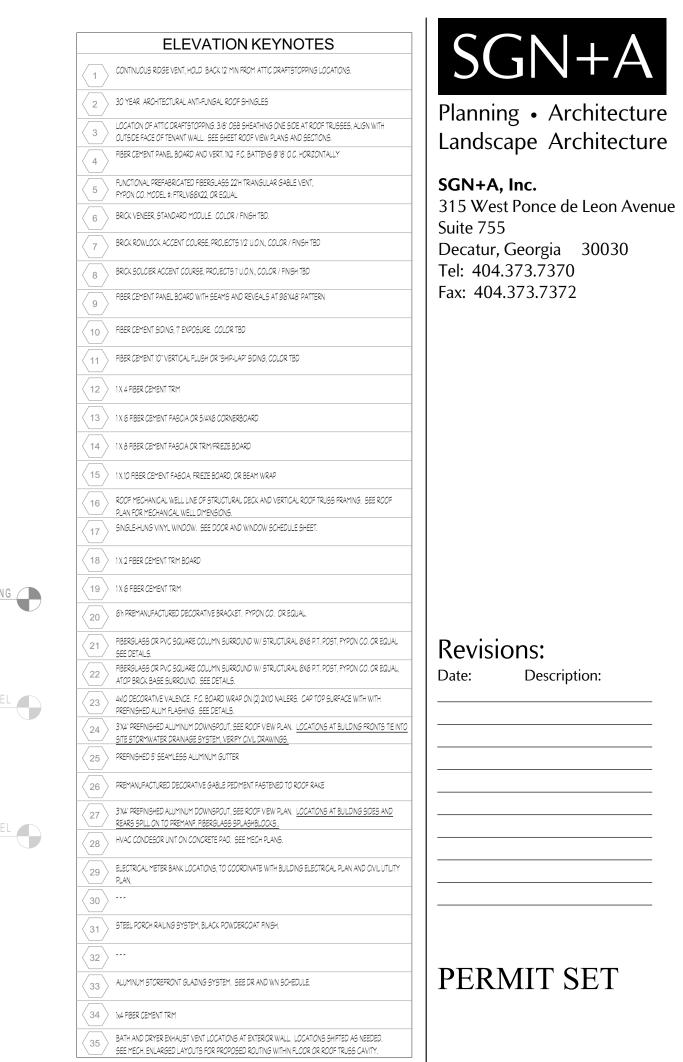
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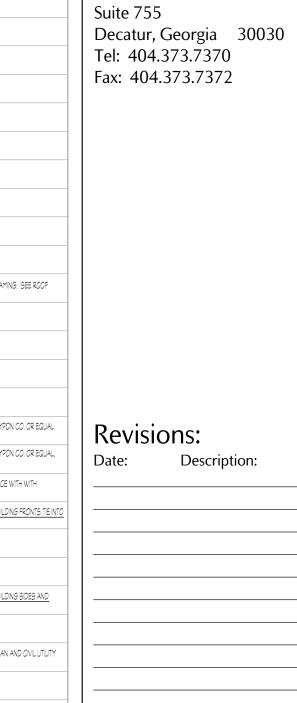
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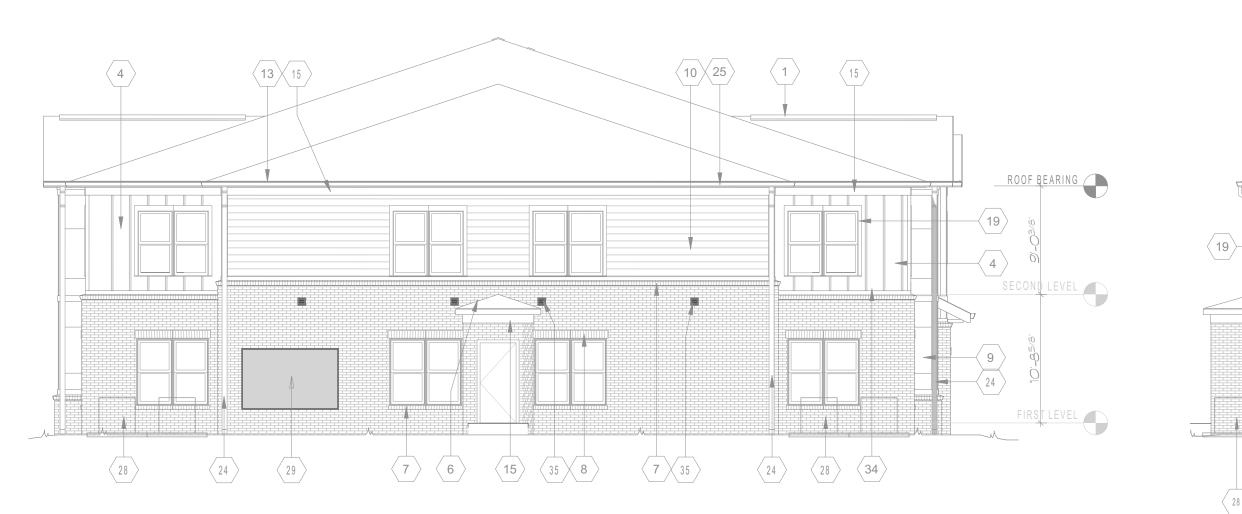
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Sheet Title: BUILDING ELEVATIONS, TYPE I

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BUILDING TYPE II LEFT SIDE ELEVATION

Scale:1/8" = 1'-0"






BUILDING TYPE II REAR ELEVATION Scale:1/8" = 1'-0"



BUILDING TYPE || FRONT ELEVATION

Scale:1/8" = 1'-0"

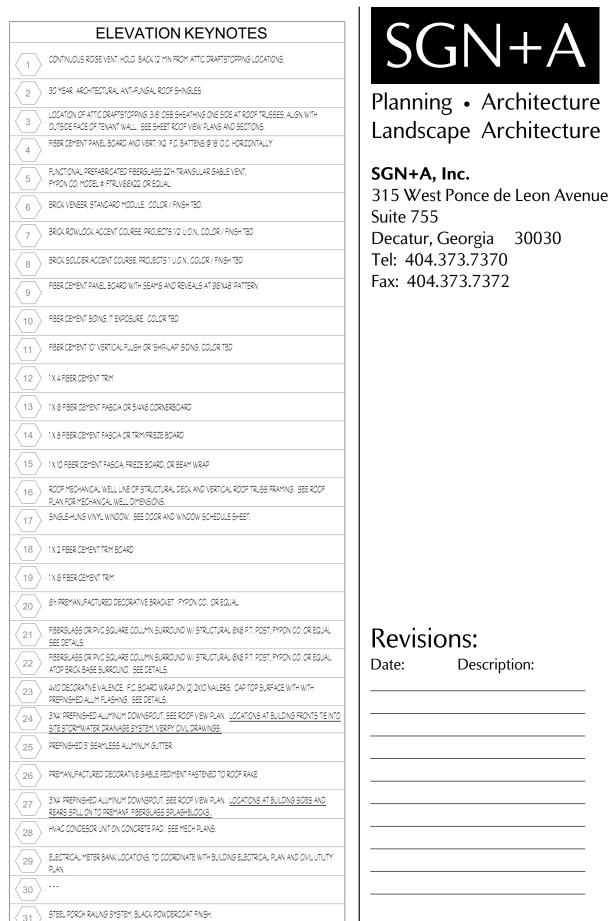

ALUMINUM STOREFRONT GLAZING SYSTEM. SEE DR AND WN SCHEDULE.

BATH AND DRYER EXHAUST VENT LOCATIONS AT EXTEROR WALL. LOCATIONS SHIFTED AS NEEDED. SEE MECH. ENLARGED LAYOUTS FOR PROPOSED ROUTING WITHIN FLOOR OR ROOF TRUSS CAVITY.

34 > 1x4 FIBER CEMENT TRIM

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Description:

BROAD ACRE

McCordsville, IN

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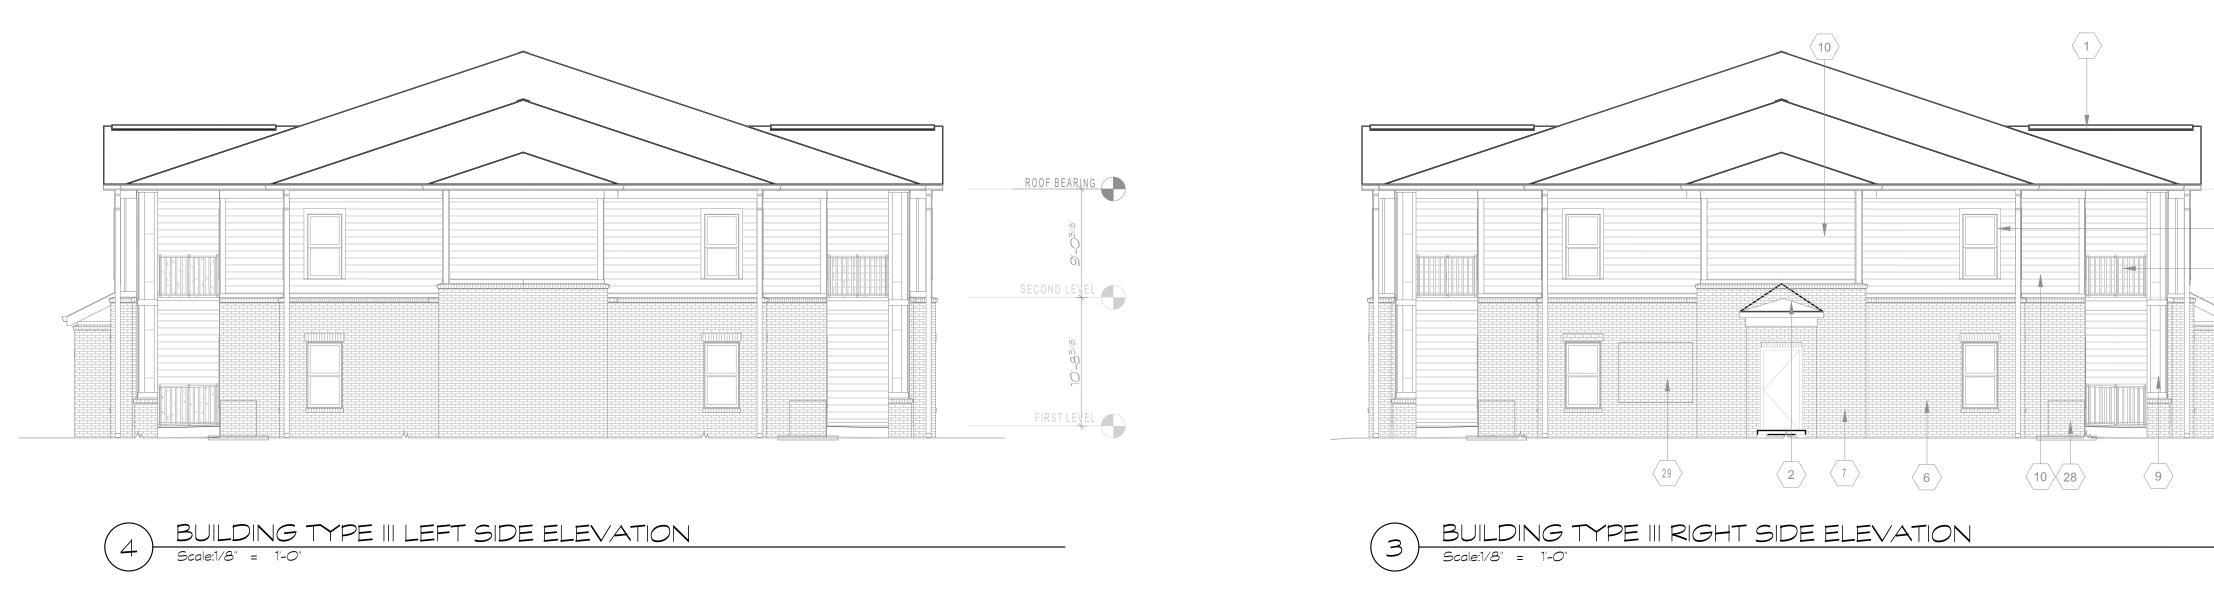
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Sheet Title: BUILDING ELEVATIONS, TYPE II

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BUILDING TYPE III FRONT ELEVATION

Scale:1/8" = 1-0"

	ELEVATION KEYNOTES
$\langle 1 \rangle$	CONTINUOUS RIDGE VENT, HOLD. BACK 12 MIN FROM ATTIC DRAFTSTOPPING LOCATIONS.
2	30 YEAR ARCHITECTURAL ANTI-FUNGAL ROOF SHINGLES
3	LOCATION OF ATTIC DRAFTSTOPPING, 3/8' OSB SHEATHING ONE SIDE AT ROOF TRUSSES, ALIGN WITH OUTSIDE FACE OF TENANT WALL. SEE SHEET ROOF VIEW PLANS AND SECTIONS.
4	FIBER CEMENT PANEL BOARD AND VERT, 1X2 F.C. BATTENS @ 18" O.C. HORIZONTALLY
$\sqrt{5}$	FUNCTIONAL PREFABRICATED FIBERGLASS 22'H TRIANGULAR GABLE VENT, FYPON CO. MODEL #: FTRLV66X22, OR EQUAL
6	BRCK VENEER, STANDARD MODULE. COLOR / FNISH TBD.
$\overline{\left\langle 7\right\rangle }$	BRICK ROWLOCK ACCENT COURSE, PROJECTS 1/2 U.O.N., COLOR / FINSH TBD
8	BRICK SOLCIER ACCENT COURSE, PROJECTS I' U.O.N., COLOR / FINISH TBD
9	FIBER CEMENT PANEL BOARD WITH SEAMS AND REVEALS AT 96 X48' PATTERN
(10)	FIBER CEMENT 9/DING, 7 EXPOSURE. COLOR TBD
(11)	FIBER CEMENT 10' VERTICAL FLUSH OR 'SHIP-LAP' SIDING, COLOR TBD
(12)	1X 4 FIBER CEMENT TRIM
(13)	1X 6 FIBER CEMENT FASCIA OR 5/4X6 CORNERBOARD
14	1 X & FIBER CEMENT FASOA OR TRIMYFRIEZE BOARD
(15)	1X 10 FIBER CEMENT FAGOIA, FREZE BOARO, OR BEAM WRAP
16	ROOF MECHANICAL WELL LINE OF STRUCTURAL DECK AND VERTICAL ROOF TRUSS FRAMING. SEE ROOF PLAN FOR MECHANICAL WELL DIMENSIONS.
(17)	SINGLE-HUNG VINYL WINDOW. SEE DOOR AND WINDOW SCHEDULE SHEET.
(18)	1X 2 FIBER CEMENT TRIM BOARD
(19)	1X G FIBER CEMENT TRIM
20	6'h PREMANUFACTURED DECORATIVE BRACKET. FYPON CO. OR EQUAL.
21	FIBERGLAGS OR PVC SQUARE COLUMN SURROUND W/STRUCTURAL 6X6 P.T. POST, PYPON CO. OR EQUAL SEE DETAILS.
22	FIBERGLAGS OR PVC SQUARE COLUMN SURROUND W/STRUCTURAL 6%6 P.T. POST, PYPON CO. OR EQUAL, ATOP BRICK BAGE SURROUND. SEE DETAILS.
23	4NO DECORATIVE VALENCE. F.C. BOARD WRAP ON (2) 2NO NAILERS. CAP TOP SURFACE WITH WITH PREFINGHED ALUM FLAGHING. SEE DETAILS.
24	3X4' PREFINGHED ALLMINUM DOWNSPOUT, SEE ROOF VIEW PLAN. LOCATIONS AT BUILDING FRONTS TIE IN 9TE STORMWATER DRANAGE SYSTEM, VERIFY OVIL DRAWINGS.
25	PREFINGHED 5' SEAMLESS ALUMINUM GUTTER
26	PREMANUFACTURED DECORATIVE GABLE PEDIMENT FASTENED TO ROOF RAKE
27	3'X4' PREFINGHED ALUMINUM DOWNSPOUT, SEE ROOF VIEW PLAN. <u>LOCATIONS AT BUILDING SIDES AND REARS SPILL</u> ON TO PREMANF, FIBERGLAGS SPLAGHBLOCKS
28	HVAC CONDESOR UNIT ON CONCRETE PAD. SEE MECH PLANS.
29	ELECTRICAL METER BANK LOCATIONS, TO COORDINATE WITH BUILDING ELECTRICAL PLAN AND CIVIL UTILITY PLAN.
30	
31	STEEL PORCH RAILING SYSTEM, BLACK POWDERCOAT FINSH.
32	
33	ALUMINUM STOREFRONT GLAZING SYSTEM. SEE DR AND WN SCHEDULE.
$\overline{}$	

BATH AND DRYER EXHAUST VENT LOCATIONS AT EXTEROR WALL. LOCATIONS SHIFTED AS NEEDED. SEE MECH. ENLARGED LAYOUTS FOR PROPOSED ROUTING WITHIN FLOOR OR ROOF TRUSS CAVITY.

ROOF BEARING

BROAD ACRE

PERMIT SET

Planning • Architecture

Landscape Architecture

315 West Ponce de Leon Avenue

Decatur, Georgia 30030

Tel: 404.373.7370 Fax: 404.373.7372

Revisions:

Description:

SGN+A, Inc.

Suite 755

McCordsville, IN

A Residential Development by
Cityscape Residential


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Sheet Title:
BUILDING
ELEVATIONS,
TYPE III

Date:

7 MARCH 2024

Sheet Number:



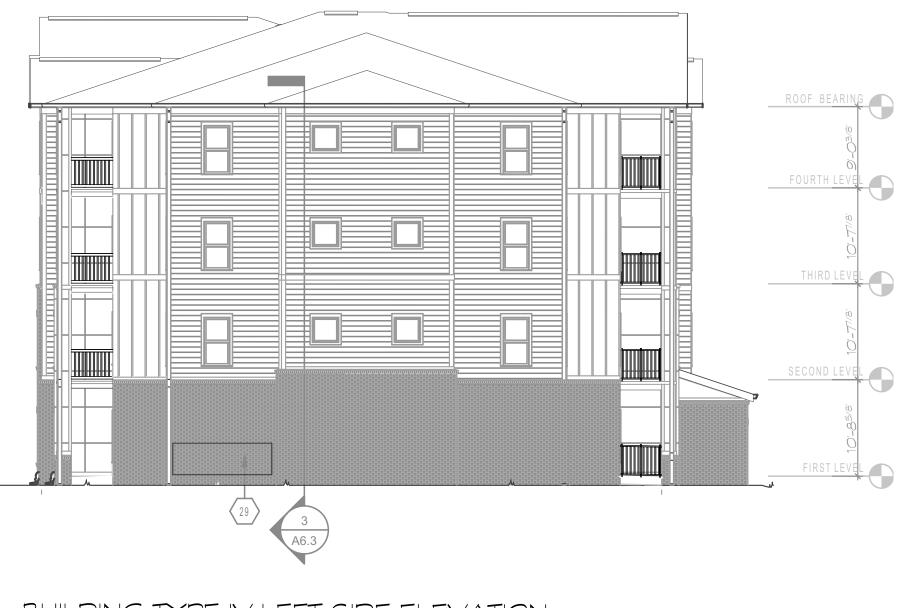

BUILDING TYPE IV LEFT SIDE ELEVATION





BUILDING TYPE IV REAR ELEVATION

Scale:3/32" = 1-0"



BUILDING TYPE IV FRONT ELEVATION Scale:3/32" = 1'-0"



BATH AND DRYER EXHAUST VENT LOCATIONS AT EXTERIOR WALL. LOCATIONS SHIFTED AS NEEDED. SEE MECH. ENLARGED LAYOUTS FOR PROPOSED ROUTING WITHIN FLOOR OR ROOF TRUSS CAVITY.

> BROAD ACRE

Description:

McCordsville, IN

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Sheet Title: BUILDING ELEVATIONS, TYPE IV

Date:

7 MARCH 2024

Sheet Number:



BUILDING TYPE IV LEFT SIDE ELEVATION, BUILDING 10 Scale:3/32" = 1'-0"



BUILDING TYPE IV REAR ELEVATION, BUILDING 11
Scale:3/32" = 1'-0"

	ELEVATION KEYNOTES	
(1) CON	VINUOUS ROGE VENT, HOLD BACK 12' MIN FROM ATTIC DRAFTSTOPPING LOCATIONS.	SGN+A
2 301	YEAR ARCHITECTURAL ANTI-FUNGAL ROOF SHINGLES	Planning • Architectu
/ 2 \	ATION OF ATTIC DRAFTSTOPPING, 3/6" OSB SHEATHING ONE SIDE AT ROOF TRUSSES, ALIGN WITH SIDE FACE OF TENANT WALL. SEE SHEET ROOF VIEW PLANS AND SECTIONS.	Landscape Architectu
4 FIBE	R CEMENT PANEL BOARD AND VERT, 1/2 F.C. BATTENS @ 16" O.C. HORIZONTALLY	Lanuscape Architecti
/ 5	CTIONAL PREFABRICATED FIBERGLASS 22'H TRIANGULAR GABLE VENT, ON CO. MODEL #: FTRLV66X22, OR EQUAL	SGN+A, Inc.
6 BRIC	X VENEER, STANDARO MODULE. COLOR / FINSH TBD.	315 West Ponce de Leon Av Suite 755
7 BRIC	CK ROWLOCK ACCENT COURSE, PROJECTS 1/2 U.O.N., COLOR / FINISH TBD	Decatur, Georgia 30030
8 BRIC	CK SOLCIER ACCENT COURSE, PROJECTS 1" U.O.N., COLOR / FINISH TBD	Tel: 404.373.7370
9 FIBE	R CEMENT PANEL BOARD WITH SEAMS AND REVEALS AT 96X48" PATTERN	Fax: 404.373.7372
10 FIBE	R CEMENT SIDING, 7 EXPOSURE. COLOR TBD	
11 FIBE	R CEMENT 10' VERTICAL FLUSH OR 'SHIP-LAP' SIDING, COLOR TBD	
12 1X4	FIBER CEMENT TRIM	
(13) 1X6	FIBER CEMENT FASCIA OR 5/4X6 CORNERBOARD	
(14) 1X8	I FIBER CEMENT FASCIA OR TRIMIFREZE BOARO	
(15) 1X10	O FIBER CEMENT FAGCIA, FRIEZE BOARD, OR BEAM WRAP	
10 /	OF MECHANICAL WELL LINE OF STRUCTURAL DECK AND VERTICAL ROOF TRUSS FRAMING. SEE ROOF IN FOR MECHANICAL WELL DIMENSIONS.	
(17) SING	FLE-HUNG VINYL WINDOW. SEE DOOR AND WINDOW SCHEDULE SHEET.	
(18) 1X2	FBER CEMENT TRIM BOARD	
(19) 1X6	FIBER CEMENT TRIM	
20 6h F	PREMANUFACTURED DECORATIVE BRACKET, FYPON CO. OR EQUAL.	
(21)	RGLASS OR PVC SQUARE COLUMN SURROUND W/STRUCTURAL 6X6 P.T. POST, PYPON CO. OR EQUAL DETAILS.	Revisions:
(22)	RGLAGS OR PVC SQUARE COLUMN SURROUND W/STRUCTURAL 6X6 P.T. POST, PYPON CO. OR EQUAL, P BRICK BAGE SURROUND. SEE DETAILS.	Date: Description:
\ 23 /	I DECORATIVE VALENCE. F.C. BOARD WRAP ON (2) 2X10 NALERS. CAP TOP SURFACE WITH WITH FINISHED ALUM FLASHING. SEE DETAILS.	
\ - ' /	PREFINISHED ALUMINUM DOWNSPOUT, SEE ROOF VIEW PLAN. LOCATIONS AT BUILDING FRONTS TE INTO ISTORMWATER DRAINAGE SYSTEM, VERIFY CIVIL DRAWINGS.	
$\overline{}$	FINISHED 5' SEAYLESS ALUMINUM GUTTER	
26 PRE	MANUFACTURED DECORATIVE GABLE PEDIMENT FASTENED TO ROOF RAKE	
\ Z /	PREFINGHED ALUMINUM DOWNSPOUT, SEE ROOF VIEW PLAN. <u>LOCATIONS AT BUILDING GIDES AND</u> RS SPILL ON TO PREMANF, FIBERGLAGS SPLAGHBLOCKS	
28 HVA	C CONDESOR UNIT ON CONCRETE PAD. SEE MECH PLANS.	
29 ELEC	CTRICAL METER BANK LOCATIONS, TO COORDINATE WITH BUILDING ELECTRICAL PLAN AND CIVIL UTILITY N.	
30		
31 STEE	EL PORCH RAILING SYSTEM, BLACK POWDERCOAT FINISH.	

ALUMINUM STOREFRONT GLAZING SYSTEM. SEE DR AND WN SCHEDULE.

BATH AND DRYER EXHAUST VENT LOCATIONS AT EXTERIOR WALL. LOCATIONS SHIFTED AS NEEDED.

SEE MECH. ENLARGED LAYOUTS FOR PROPOSED ROUTING WITHIN FLOOR OR ROOF TRUSS CAVITY.

PERMIT SET

BROAD ACRE

McCordsville, IN


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Sheet Title: BUILDING ELEVATIONS, TYPE IV, BUILDINGS 10 & Date:


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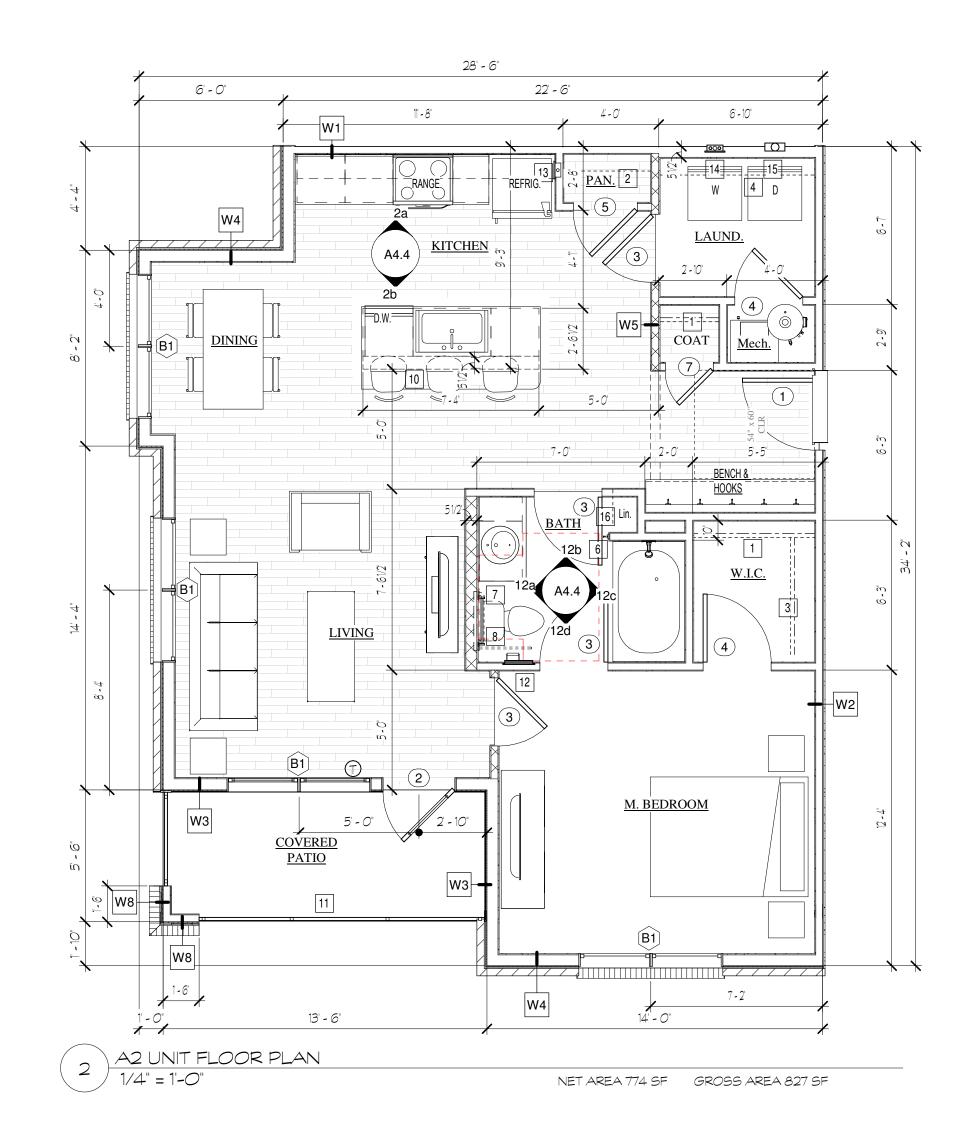



4 A3 UNIT TYPE PLAN
1/4" = 1'-0"

NET AREA 730 SF GROSS AREA 775 SF



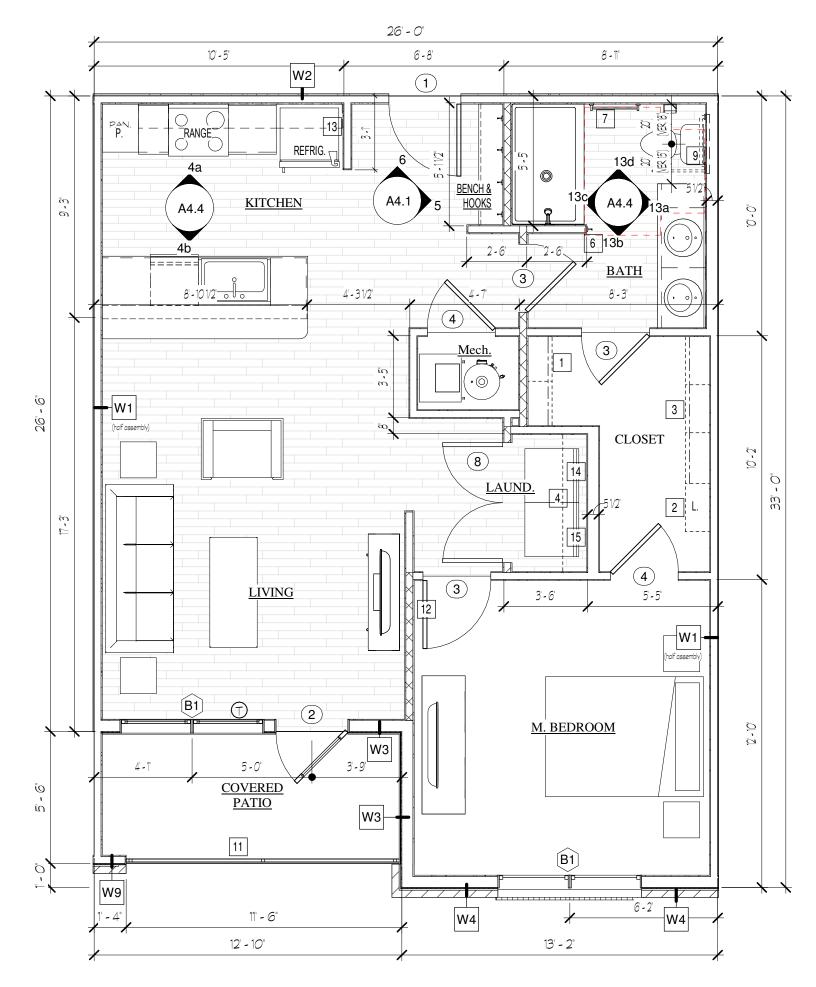


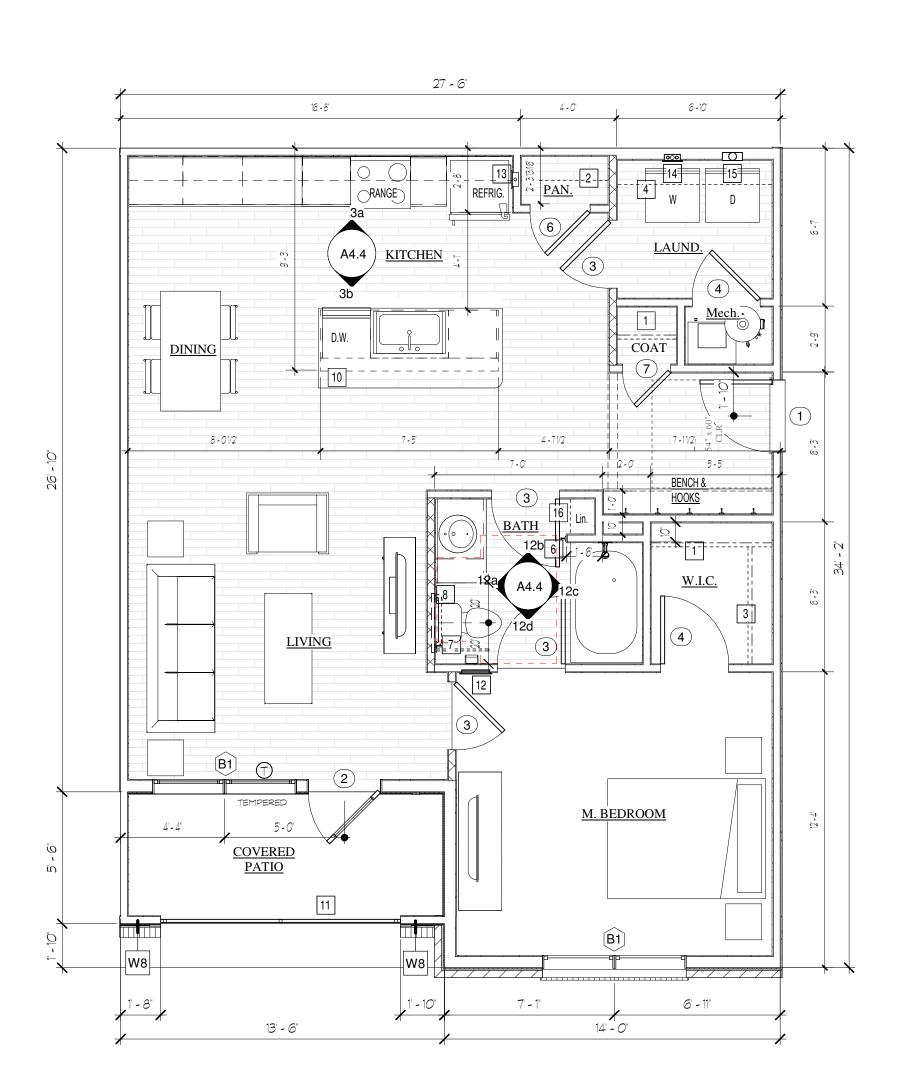


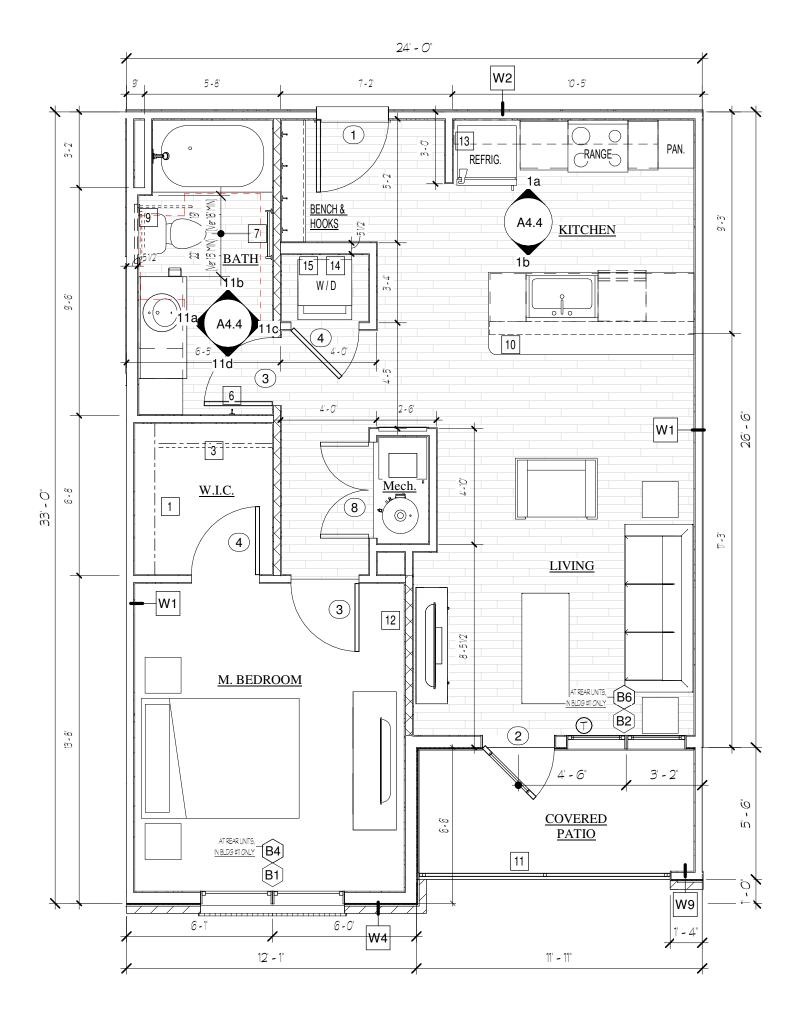

NET AREA 672 SF GROSS AREA 715 SF

A1 UNIT FLOOR PLAN

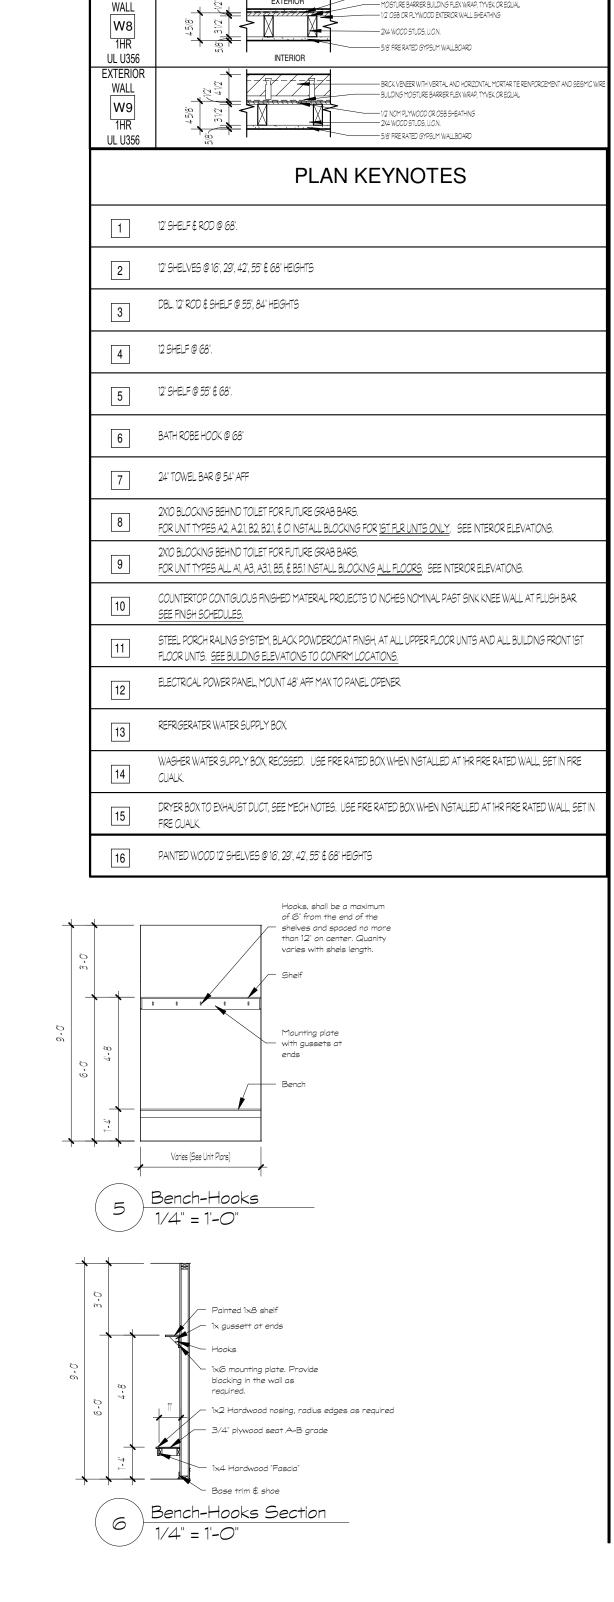

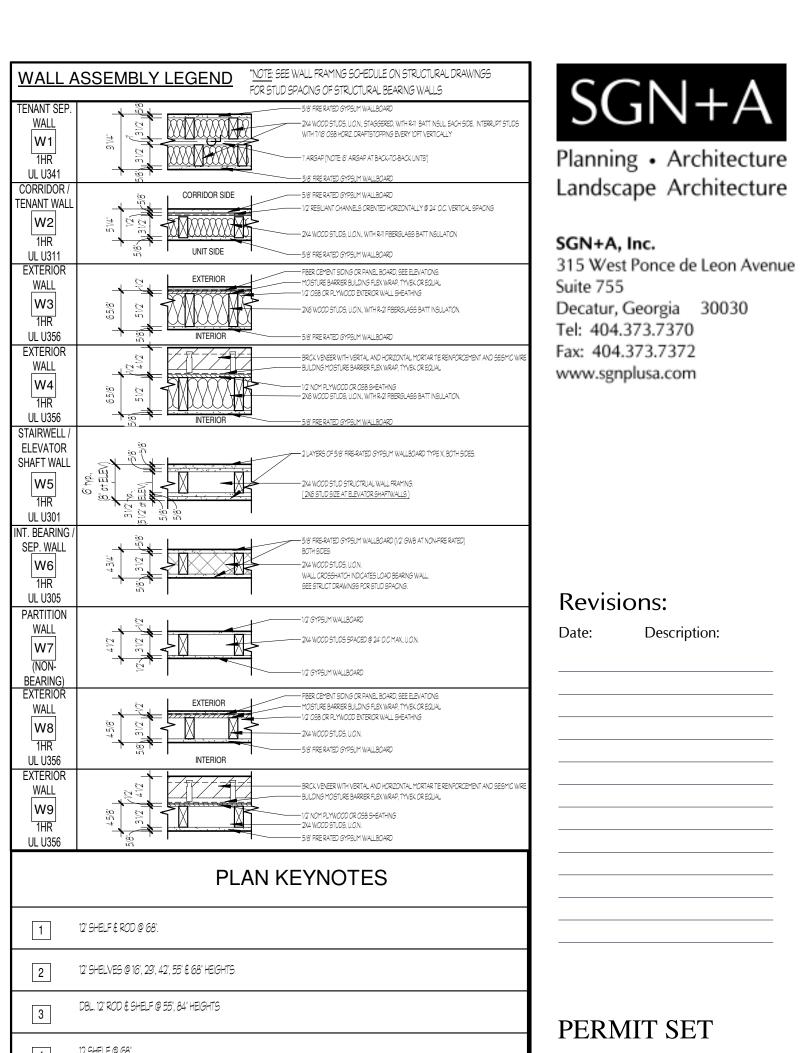

BROAD

McCordsville, IN

ACRE

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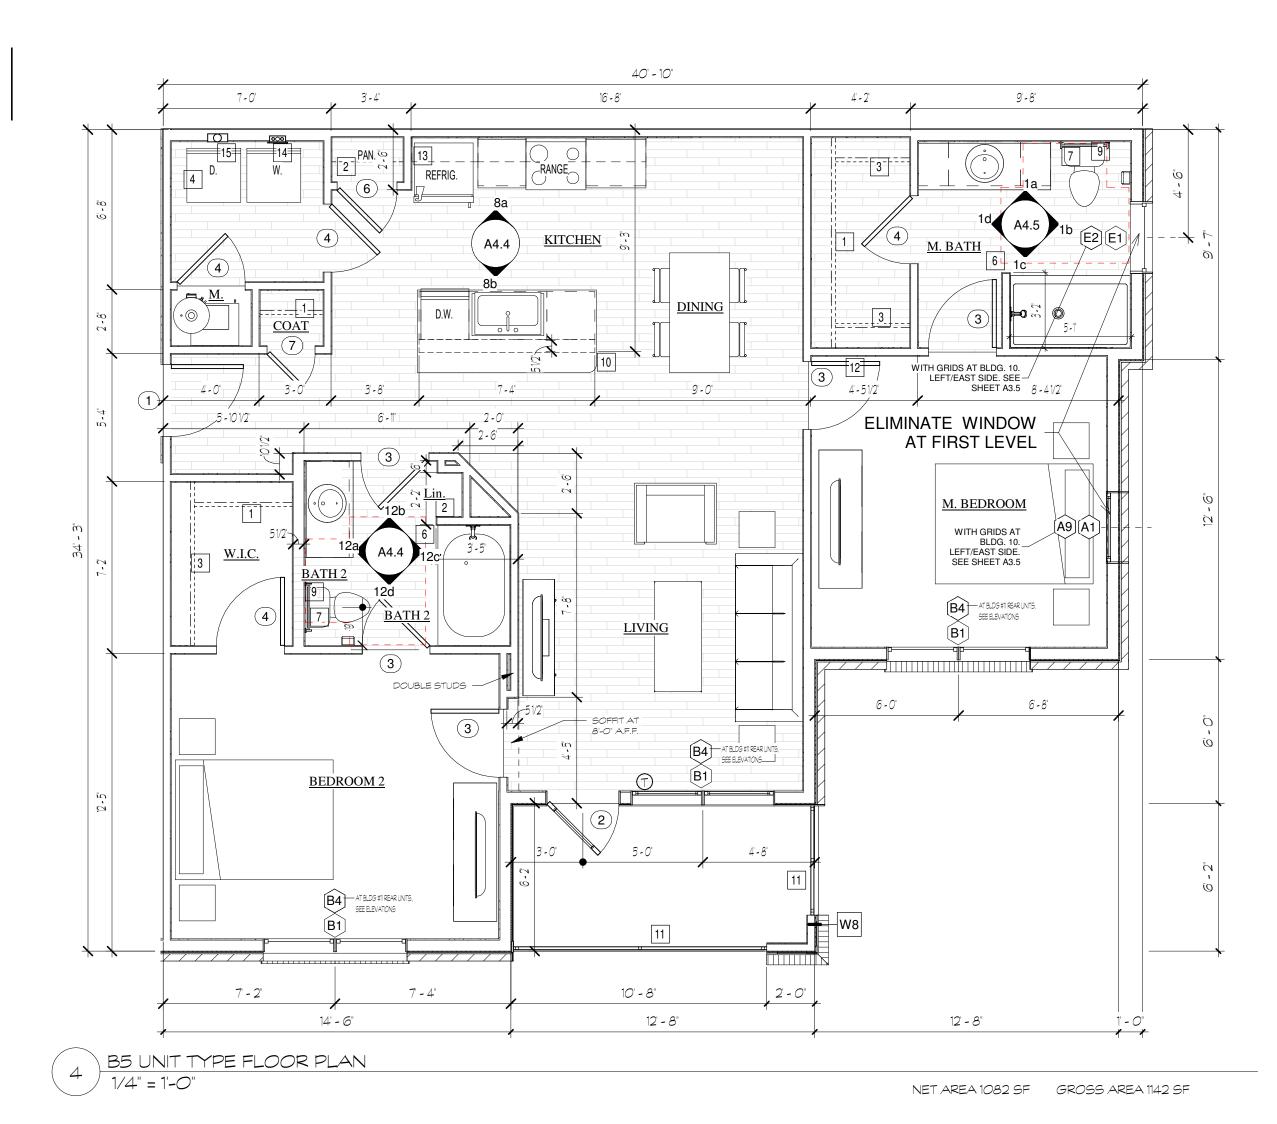
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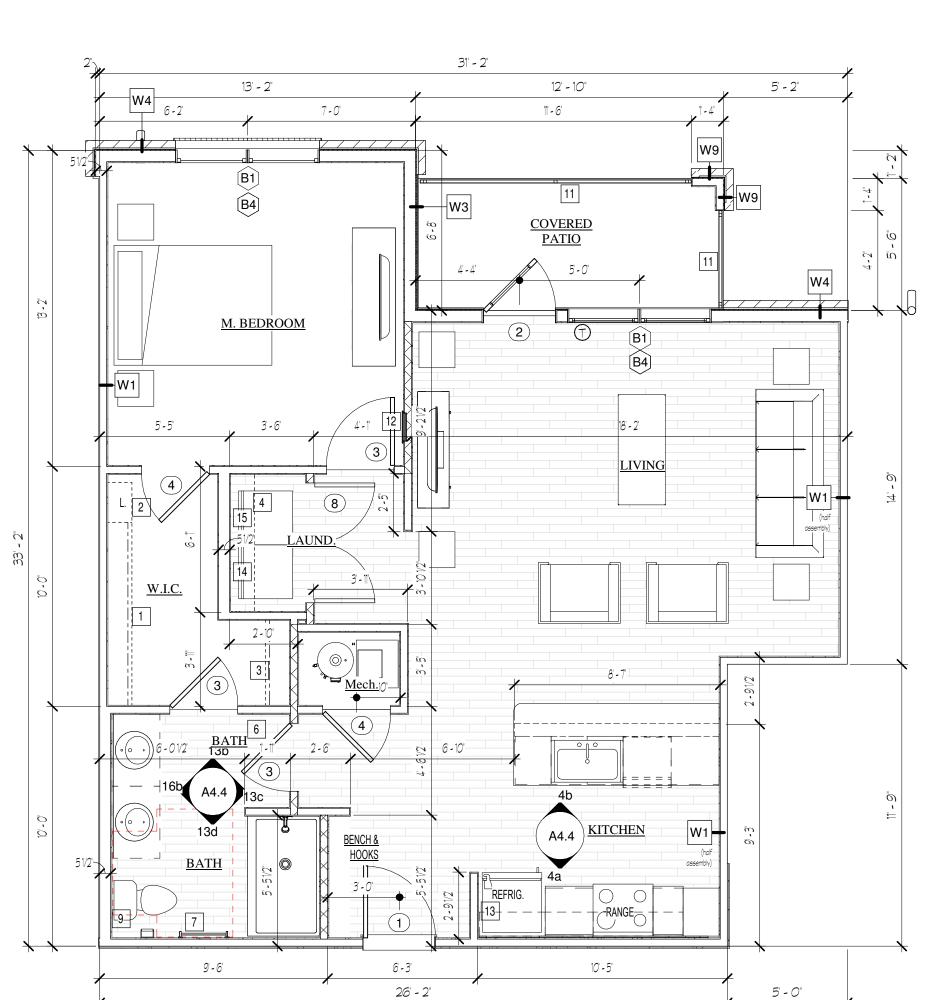
Sheet Title: UNIT FLOOR PLANS

Date: 7 MARCH 2024


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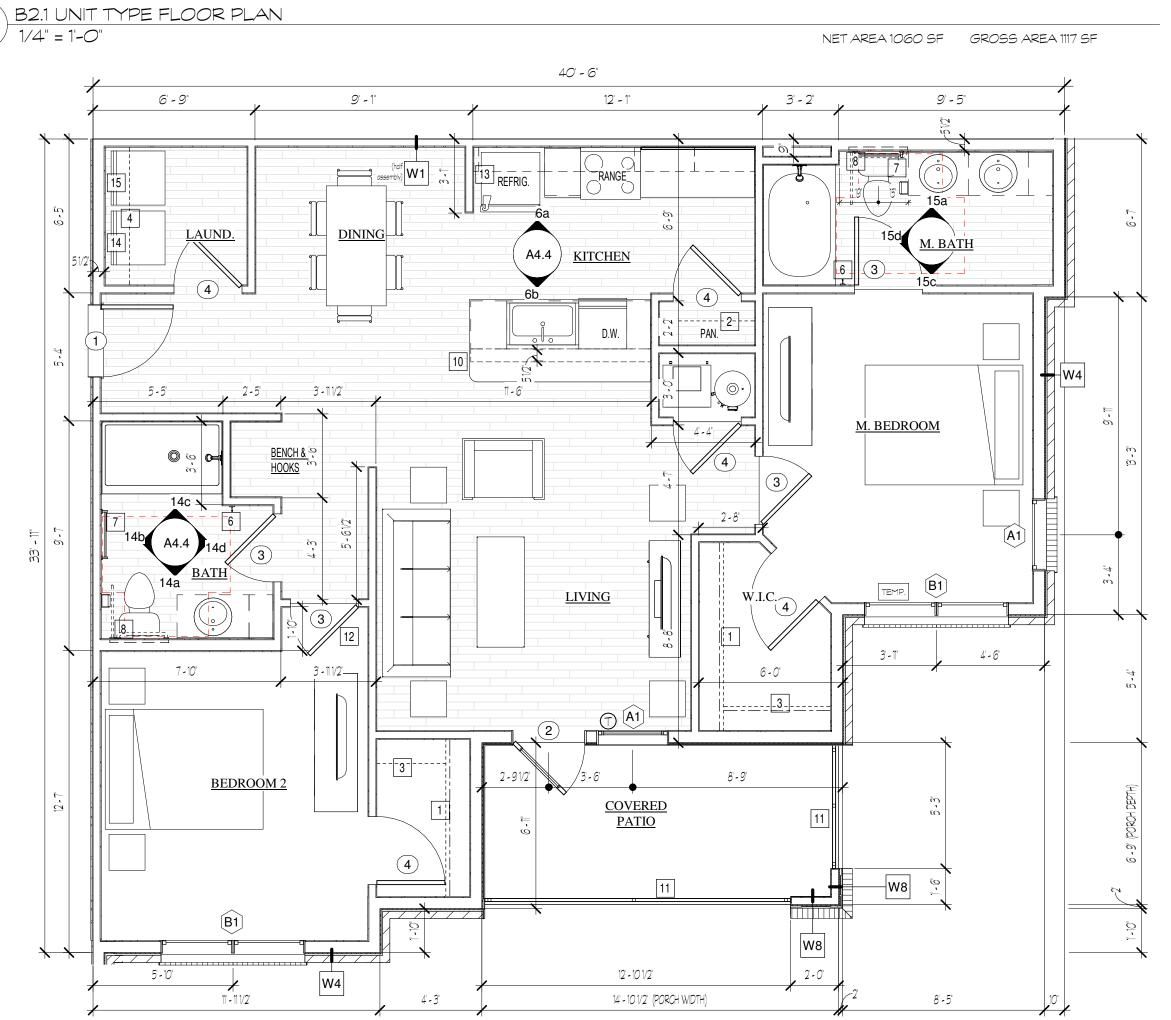
A4.






3 A3.1 UNIT FLOOR PLAN
1/4" = 1'-0"



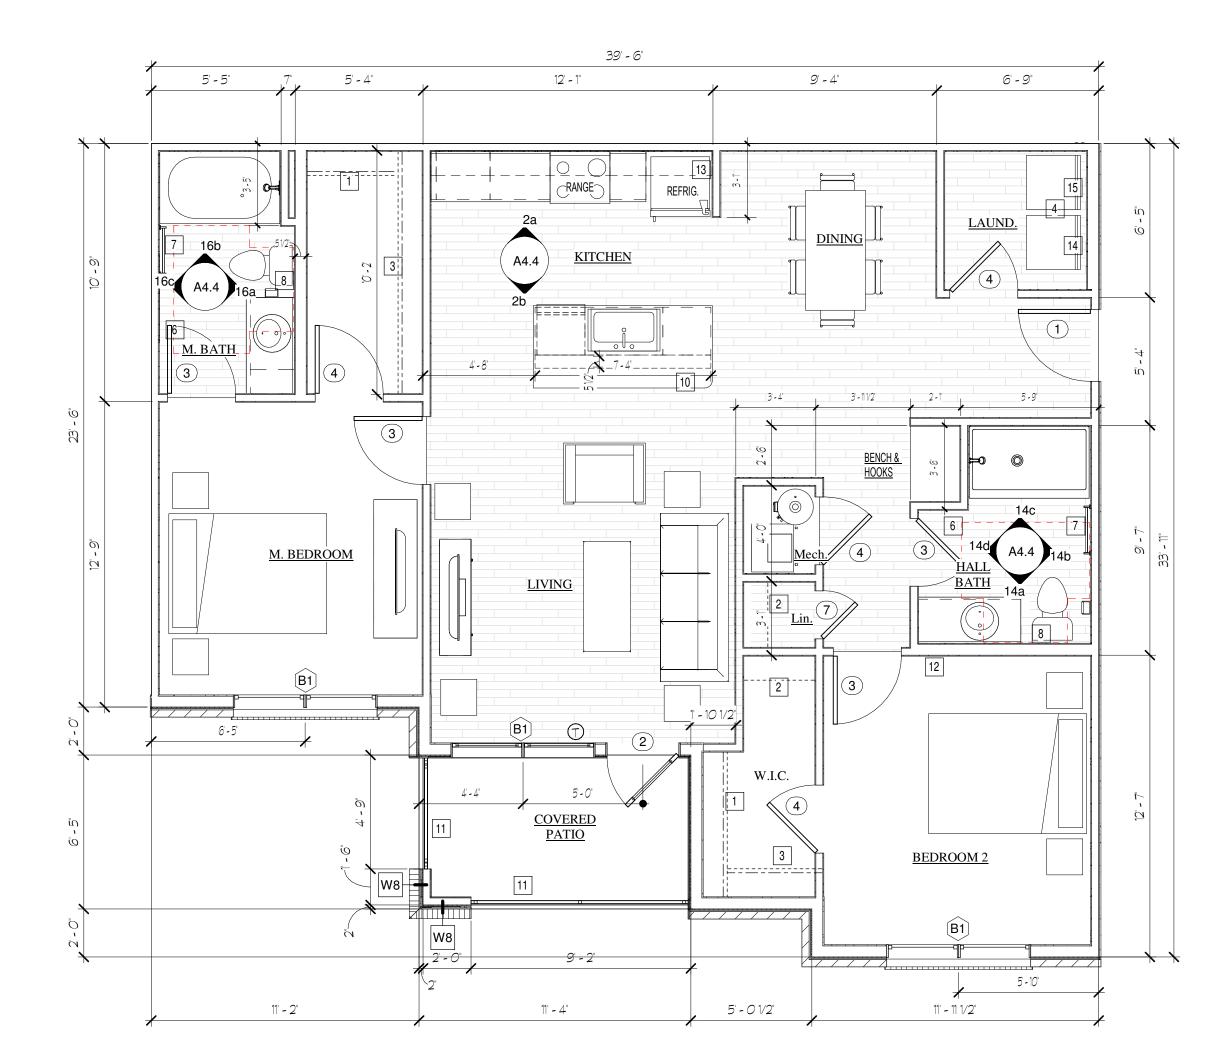

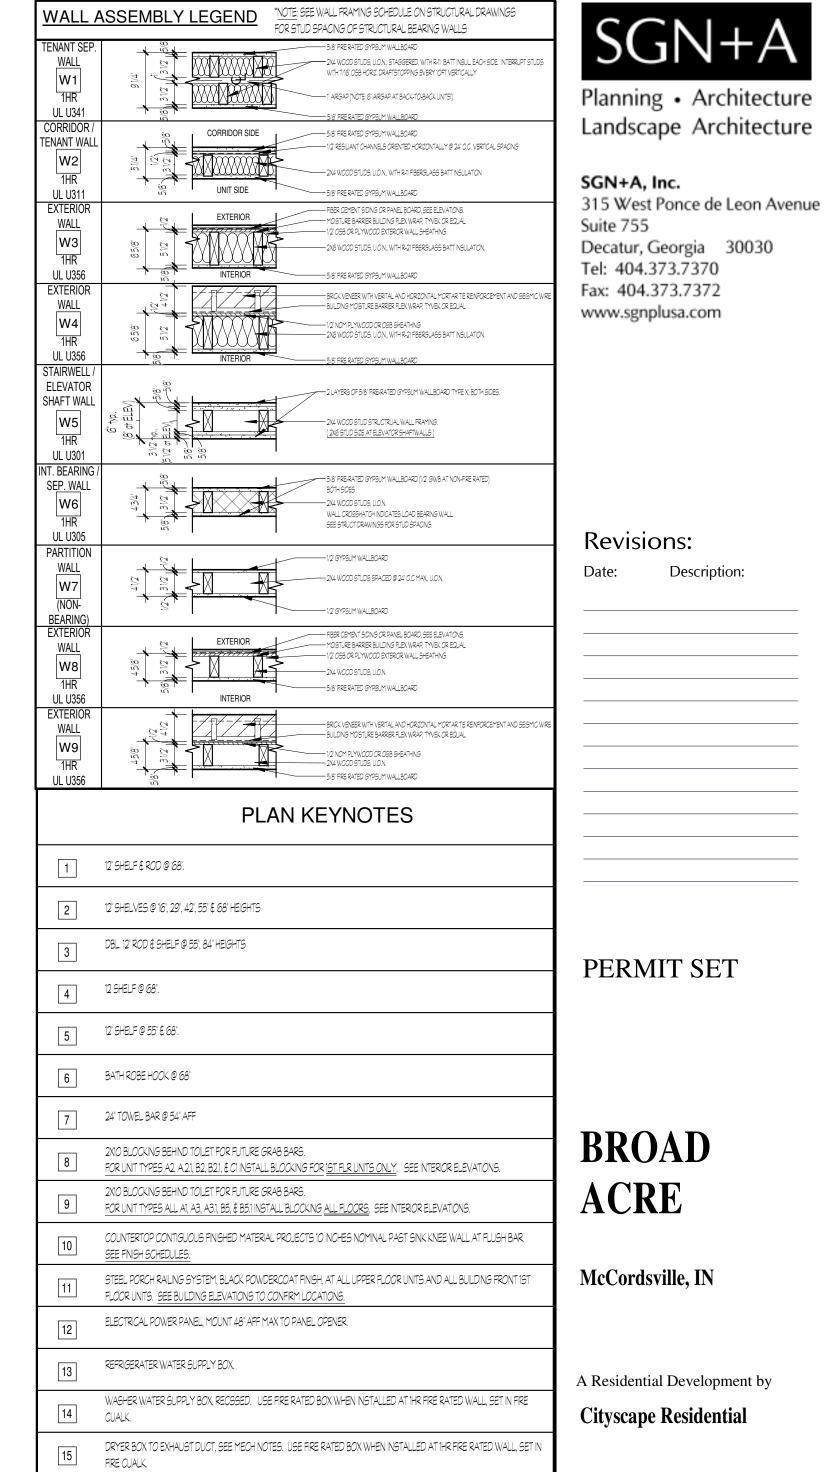

16 PAINTED WOOD 12" SHELVES @ 16", 29", 42", 55" & 68" HEIGHTS

BROAD ACRE

Description:

McCordsville, IN

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Sheet Title: UNIT FLOOR PLANS


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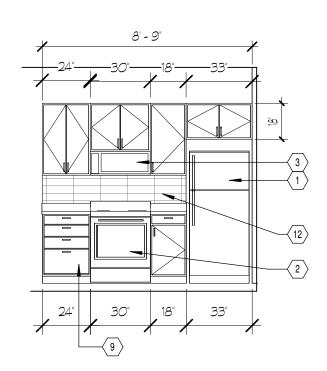
B2 UNIT FLOOR PLAN
1/4" = 1'-0"

NET AREA 803 SF GROSS AREA 852 SF


NET AREA 1029 SF GROSS AREA 1090 SF




6 A2.1 UNIT FLOOR PLAN @ BLDGS. 10 & 11 1/4" = 1'-0"

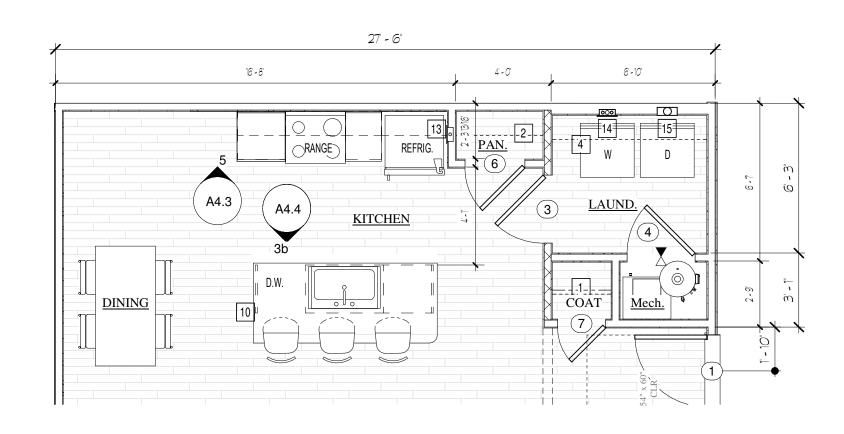


5 A2.1 KITCHEN @ BLDGS. 10 & 11 1/4" = 1'-0"

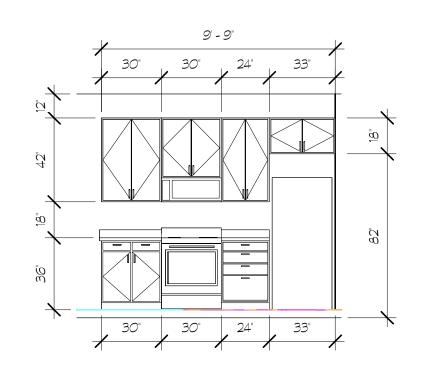


4 B5.1 KITCHEN @ BLDGS. 10 & 11 1/4" = 1'-0"

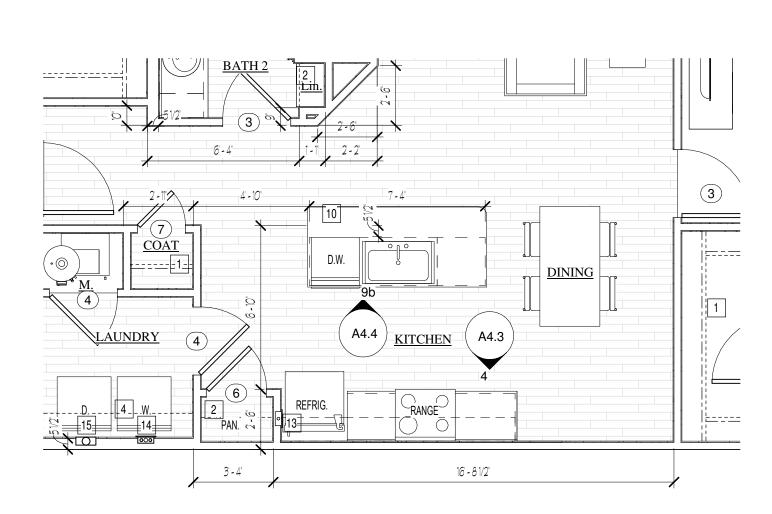



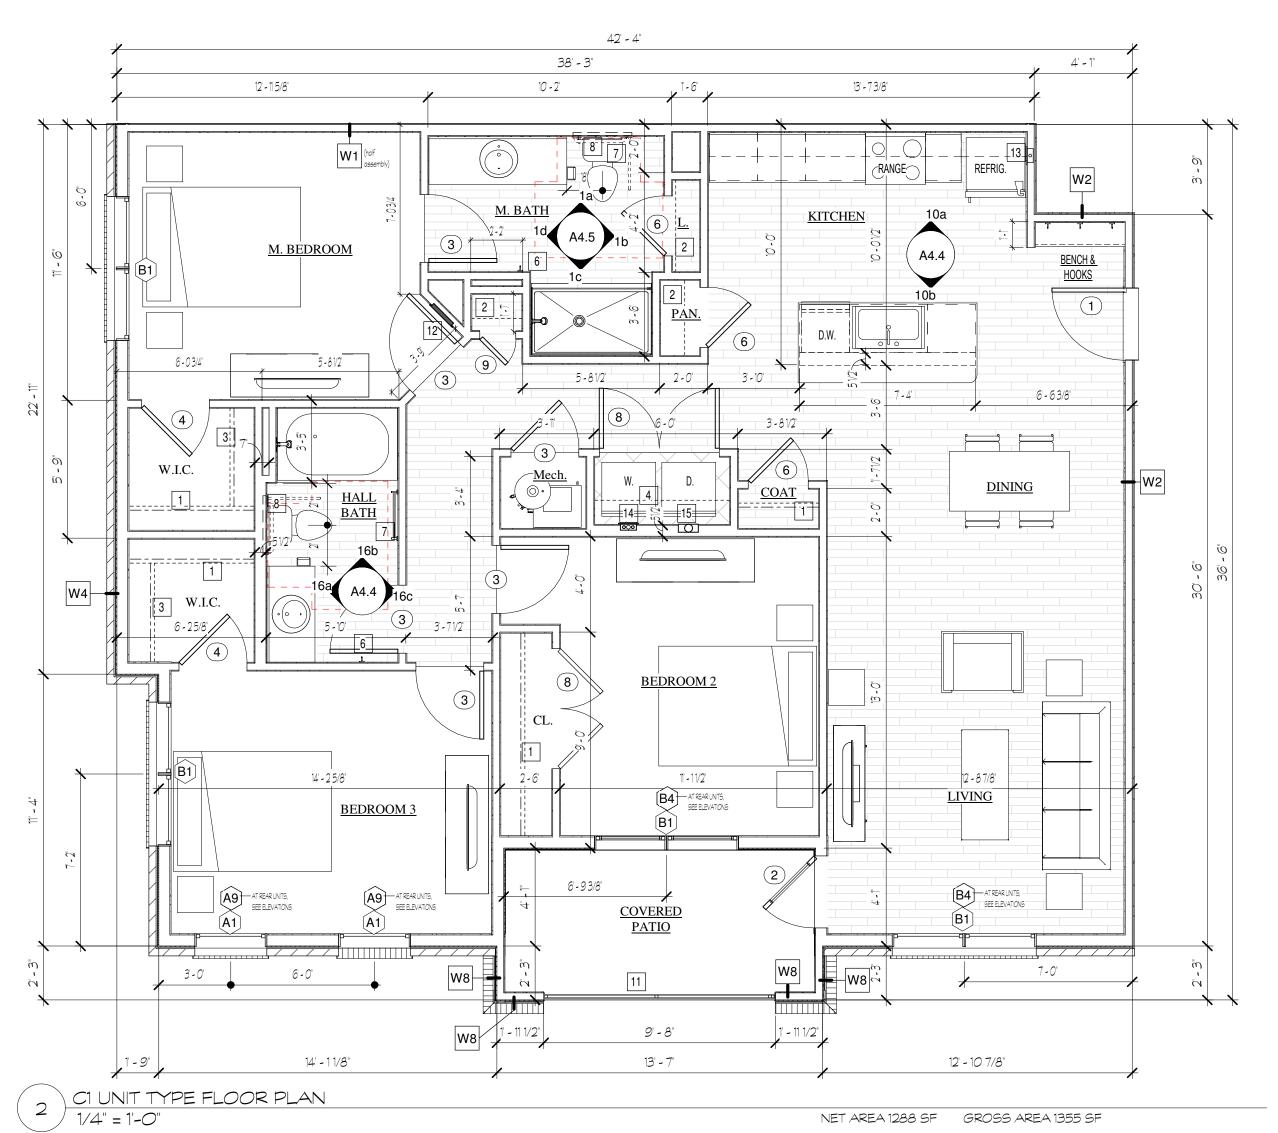

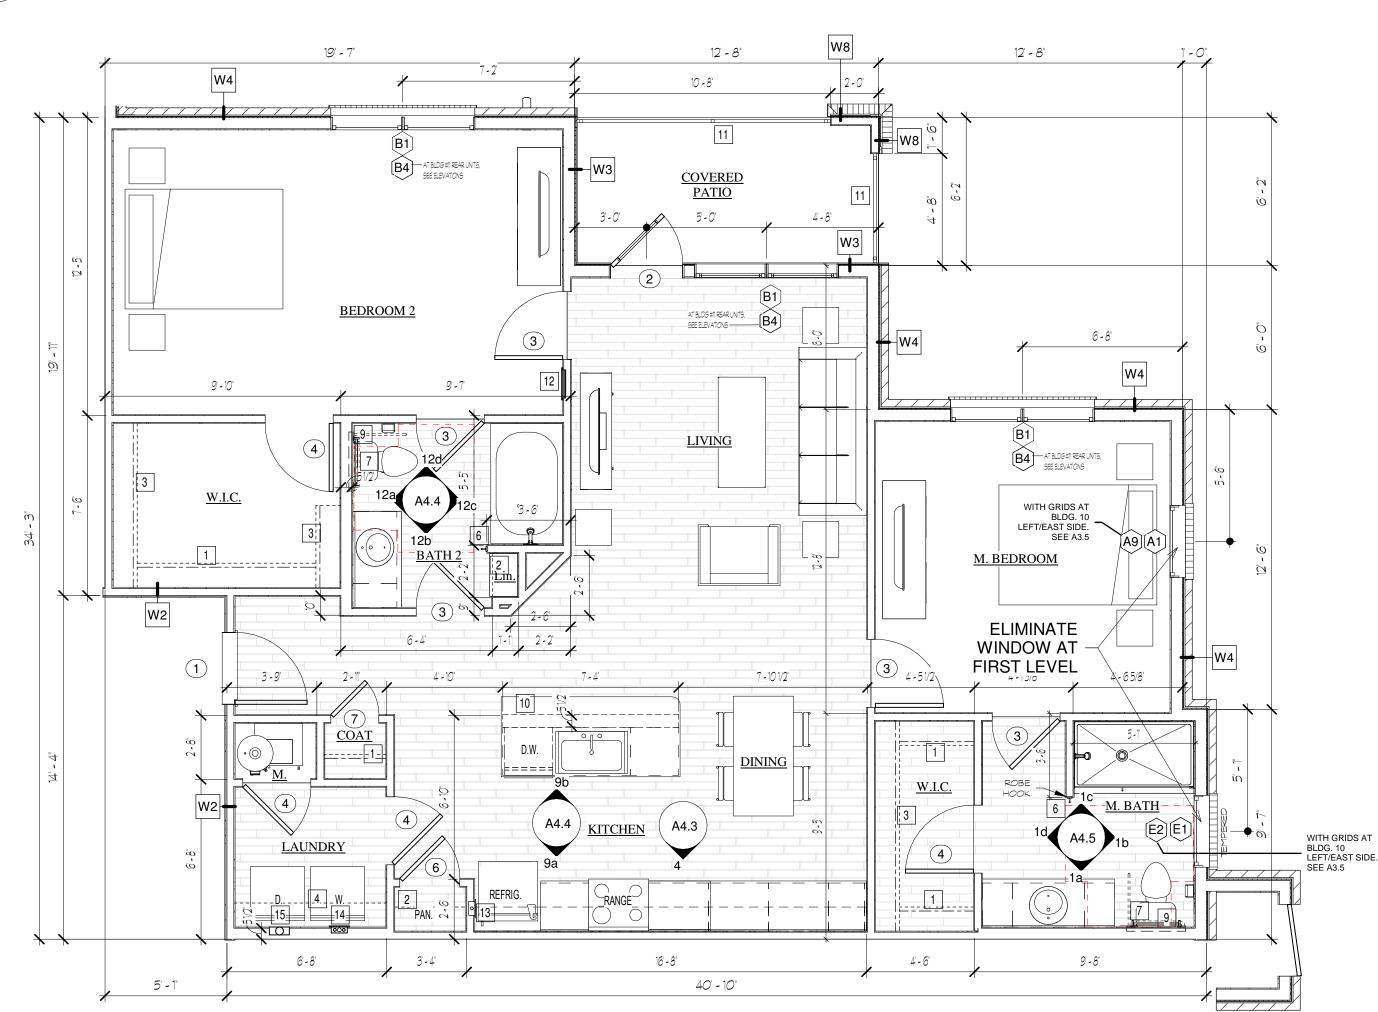

NET AREA 1171 SF GROSS AREA 1244 SF

1 B5.1 UNIT TYPE FLOOR PLAN
1/4" = 1'-0"

UL U356	1/2 NOM PLYWOOD OR OSB SHEATHING 2/16 WOOD STUDS, U.O.N., WITH R.21 PBERGLAGS BATT INSULATION
STAIRWELL / ELEVATOR	INTERIOR 5/6' FRE RATED GYPSUM WALLBOARD 2 LAYERS OF 5/6' FRE-RATED GYPSUM WALLBOARD TYPE X, BOTH SIDES.
SHAFT WALL W5 1HR UL U301	2/4 WOOD STUD STRUCTRUAL WALL FRAMING. (2/6 STUD SZE AT ELEVATOR SHAFTWALLS)
INT. BEARING SEP. WALL W6 1HR	5/8' FRE-RATED GYPSUM WALLBOARD (1/2' GWB AT NON-FRE RATED) BOTH SIDES 2V4 WOOD STUDS, U.O.N. WALL CROSSHATCH NOICATES LOAD BEARNG WALL SEE STRUCT DRAWINGS FOR STUD SPACING.
PARTITION WALL W7 (NON-	1/2 GYPSUM WALLBOARD 2/4 WOOD STUDS SPACED @ 2/4 O.C MAX, U.O.N. 1/2 GYPSUM WALLBOARD
BEARING) EXTERIOR WALL W8 1HR	EXTERIOR FBER CEYENT 50 NG CR PANEL BOARD, SEE ELEVATIONS. MOSTURE BARRER BUILDING FLEX WRAP, TYVEK CR EQUAL 1/2 058 OR PLYWOOD ENTEROR WALL SHEATHING 2/4 WOOD 5TUDS, LION. 5/6* FRE RATED GYPSUM WALLBOARD
UL U356 EXTERIOR WALL W9 1HR	INTERIOR BROK VENEER WITH VERTAL AND HORZONTAL MORTAR TE REINFORCEMEN BUILDING MOSTLIKE BARRER FLEN WRAP, TYVEK OR EQUAL 1/2 NOM 9, YWOOD OR 055 SHEATHING 2/4 WOOD 5TILDS, U.O.N.
UL U356	PLAN KEYNOTES
1	12' SHELF & ROD @ 68'.
2	12' SHELVES @ 16', 29', 42', 55' \$ 68' HEIGHTS
3	DBL 12' ROD & SHELF @ 55', 84' HEIGHTS
4	12 SHELF @ 68°.
5	12' SHELF @ 55' \$ 68'.
6	BATH ROBE HOOK @ 68"
7	24" TOWEL BAR @ 54" AFF
8	2X10 BLOCKING BEHIND TOILET FOR FUTURE GRAB BARS. FOR UNIT TYPES A2, A21, B2, B21, & CLINSTALL BLOCKING FOR 1ST FLR UNITS ONLY. SEE INTERIOR ELEVATIONS.
9	2X10 BLOCKING BEHIND TOILET FOR FUTURE GRAB BARS. FOR UNIT TYPES ALL A1, A3, A3.1, B5, & B5.1 INSTALL BLOCKING <u>ALL FLOORS</u> . SEE INTERIOR ELEVATIONS.
10	COUNTERTOP CONTIGUOUS FINISHED MATERIAL PROJECTS 10 INCHES NOMINAL PAGT SINK KNEE WALL AT FLUSH SEE FINISH SCHEDULES.
11	STEEL PORCH RAILING SYSTEM, BLACK POWDERCOAT FINISH, AT ALL UPPER FLOOR UNITS AND ALL BUILDING FRI FLOOR UNITS. SEE BUILDING ELEVATIONS TO CONFIRM LOCATIONS.
	ELECTRICAL POWER PANEL, MOUNT 48' AFF MAX TO PANEL OPENER.
12	DEEDIGEDATED WATER CLIDRIY 20V
13	REFRIGERATER WATER SUPPLY BOX. WASHER WATER SUPPLY BOX, RECSSED. USE FIRE RATED BOX WHEN INSTALLED AT 1HR FIRE RATED WALL, SET
13	
13	WASHER WATER SUPPLY BOX, RECSSED. USE FIRE RATED BOX WHEN INSTALLED AT 1HR FIRE RATED WALL, SET CUALK.

SGN+A
Planning • Architecture Landscape Architecture
SGN+A, Inc. 315 West Ponce de Leon Avenue

5/8' FIRE RATED GYPSUM WALLBOARD TENANT WALL
W2
1HR - 1/2' RESILIANT CHANNELS ORIENTED HORIZONTALLY @ 24' O.C. VERTICAL SPACING — FIBER CEMENT SIDING OR PANEL BOARD, SEE ELEVATIONS. — MOSTURE BARRER BULDING FLEX WRAP, TYVEK OR EQUAL — 1/2" OSB OR PLYWOOD EXTEROR WALL SHEATHING Suite 755 Decatur, Georgia 30030 - 2X6 WOOD STUDS, U.O.N., WITH R-21 FIBERGLAGS BATT INSULATION. Tel: 404.373.7370 Fax: 404.373.7372 BROCK VENEER WITH VERTAL AND HORZONTAL MORTAR TIE REINFORCEMENT AND SEIS BULDING MOSTURE BARRIER FLEX WRAP, TYVEK OR EQUAL www.sgnplusa.com Revisions: Date: Description: PERMIT SET **BROAD ACRE** SH BAR. McCordsville, IN A Residential Development by Cityscape Residential

WALL ASSEMBLY LEGEND "NOTE: SEE WALL FRAMING SCHEDULE ON STRUCTURAL DRAWINGS

FOR STUD SPACING OF STRUCTURAL BEARING WALLS

WITH 7/16' OSB HORIZ. DRAFTSTOPPING EVERY 10FT VERTICALLY

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Sheet Title: UNIT FLOOR PLANS

Date: 7 MARCH 2024

Sheet Number:

A4.3