KENNSINGTON GARDENS MCCORDSVILLE, IN 46055



SITE LOCATION MAP McCordsville Gateway Crossing 🎎 Volumod 240 miles



DEVELOPER:

THE RIDGE GROUP

TYLER BOWERS 3225 S. HOYT AVENUE MUNCIE, IN 47302

ARCHITECT:



BILLY@R3BARCHITECTURE.COM

STRUCTURAL ENGINEER:

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MECH., PLUMBING & ELEC. ENGINEER:

CONTACT: DAVID EVERHART

CIVIL ENGINEER:

STANTEC

5778 WEST 74TH STREET INDIANAPOLIS, IN 46278-1754

LANDSCAPE

STANTEC

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CONSTRUCTION:

THE RIDGE GROUP

BRITTANY OLMSTEAD 3225 S. HOYT AVENUE **MUNCIE**, IN 47302 BOLMSTEAD@RIDGECORPORATION.COM

INTERIOR DESIGNER:

KELSEY PARKISON, NCIDQ


2325 N. DELAWARE ST INDIANAPOLIS, IN 46205 CONTACT: KELSEY PARKISON PHONE: 219-851-0192 KELSEYPARKISON@GMAIL.COM

PROJECT TEAM

3225 S. HOYT AVENUE MUNCIE, IN 47302 765-282-3778



574-850-2270

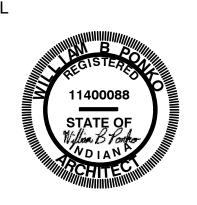

PROJECT TITLE

REVISIONS MARK DESCRIPTION

DRAWN BY: BP CHECKED BY: BP

COVER

FIELD MEASURE FOR EXACT LAYOUT AND

SUBMIT SHOP DRAWINGS OF ALL GATES

FOR APPROVAL PRIOR TO CONSTRUCTION

FENCES AND GATES TO MEET ALL HEALTH,

FOR ALL GATES FOR APPROVAL AND TO

ALL STEEL COMPONENTS TO BE POWDER

REFER TO DOOR SPECIFICATION FOR GATE

1/2" = 1'-0"

COORDINATE ACCESS LOCKS W/ OWNER'S

CONTRACTOR TO PROVIDE SHOP DRAWINGS

SAFETY, AND ACCESSIBILITY CODES.

REPRESENTATIVE.

@ 1'-0" O.C.

1-1/2" X 1-1/2" SQ. STL

POS† @ 10'-0" O.C.

1-1/2" X 1-1/2"


SQ. \$TL. TUBE

- 1" X 1" SQ. PICKETS


@ 1'-0" O.C.

BOLT POSTS TO TOP OF POOL SLAB.

	Pool	Equipmer	nt List
QTY.	MFG.	CAT NO.	DESCRIPTION
2	Aquastar	WAV9WRxxx	9" square wave grate and frame
3+	Pentair	Admiral S-20	Auto Skimmer
3+	Pentair	506162	Bermuda Equilizer cover
1	СМР	25504	Auto Water Leveler
10	Hayward	SP10225	1.5" Wall inlet
10	Hayward	SP1056	1.5" hydro static relief valve
2 min	Hayward	LFGUY1000	UCL Niches
2 min	Hayward	LPCUN11100	ColorLogic LED Pool
1	Hayward	LTBUY11300	Transformer
	SR Smith	Custom	SEALED STEEL hand rail
	SR SMITH	Custom	SEALED STEEL ladder
	SR SMITH	Custom	SEALED STEEL escutcheons
2	Pentair	808-22	8-20" telescope pole
1	Pentair	902	Algae brush
1	Pentair	119	Skimmer/Leaf Rake
1	Maytronics	Dolphin wave 80	Robotic pool cleaner
1	Pentair	153	Safety pool hook
2	Penatir	143	Metal pool hangers, ADA compliant hanging.
1	Jim Buoy	gw-24	24" ring buoy, Wall hook to be included.
1	custom	25 person	First AID pool kit
1	Aqua Creek	aqc-fadmrl	Admiral pool lift 400lbs
1	aqua creek	aqc f04cajp	Anchor set for ada lift

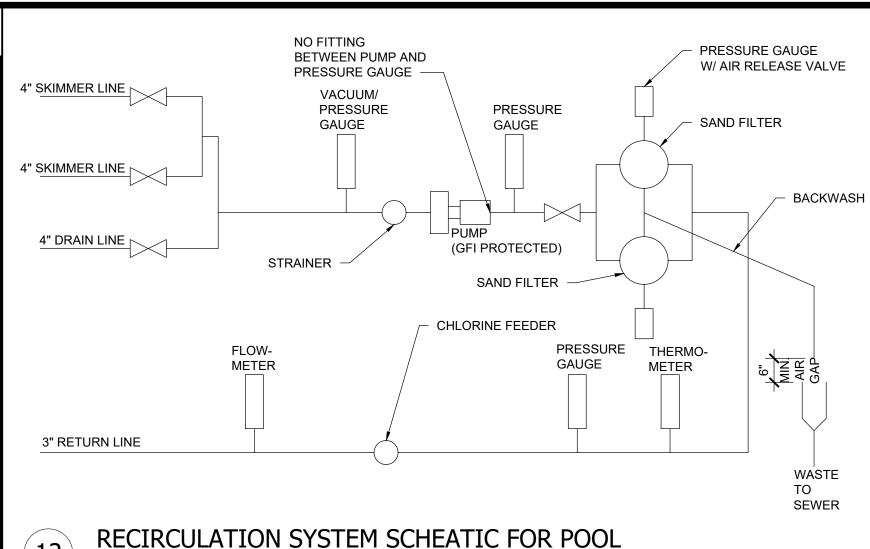

Scale: 1/2" = 1' - 0"

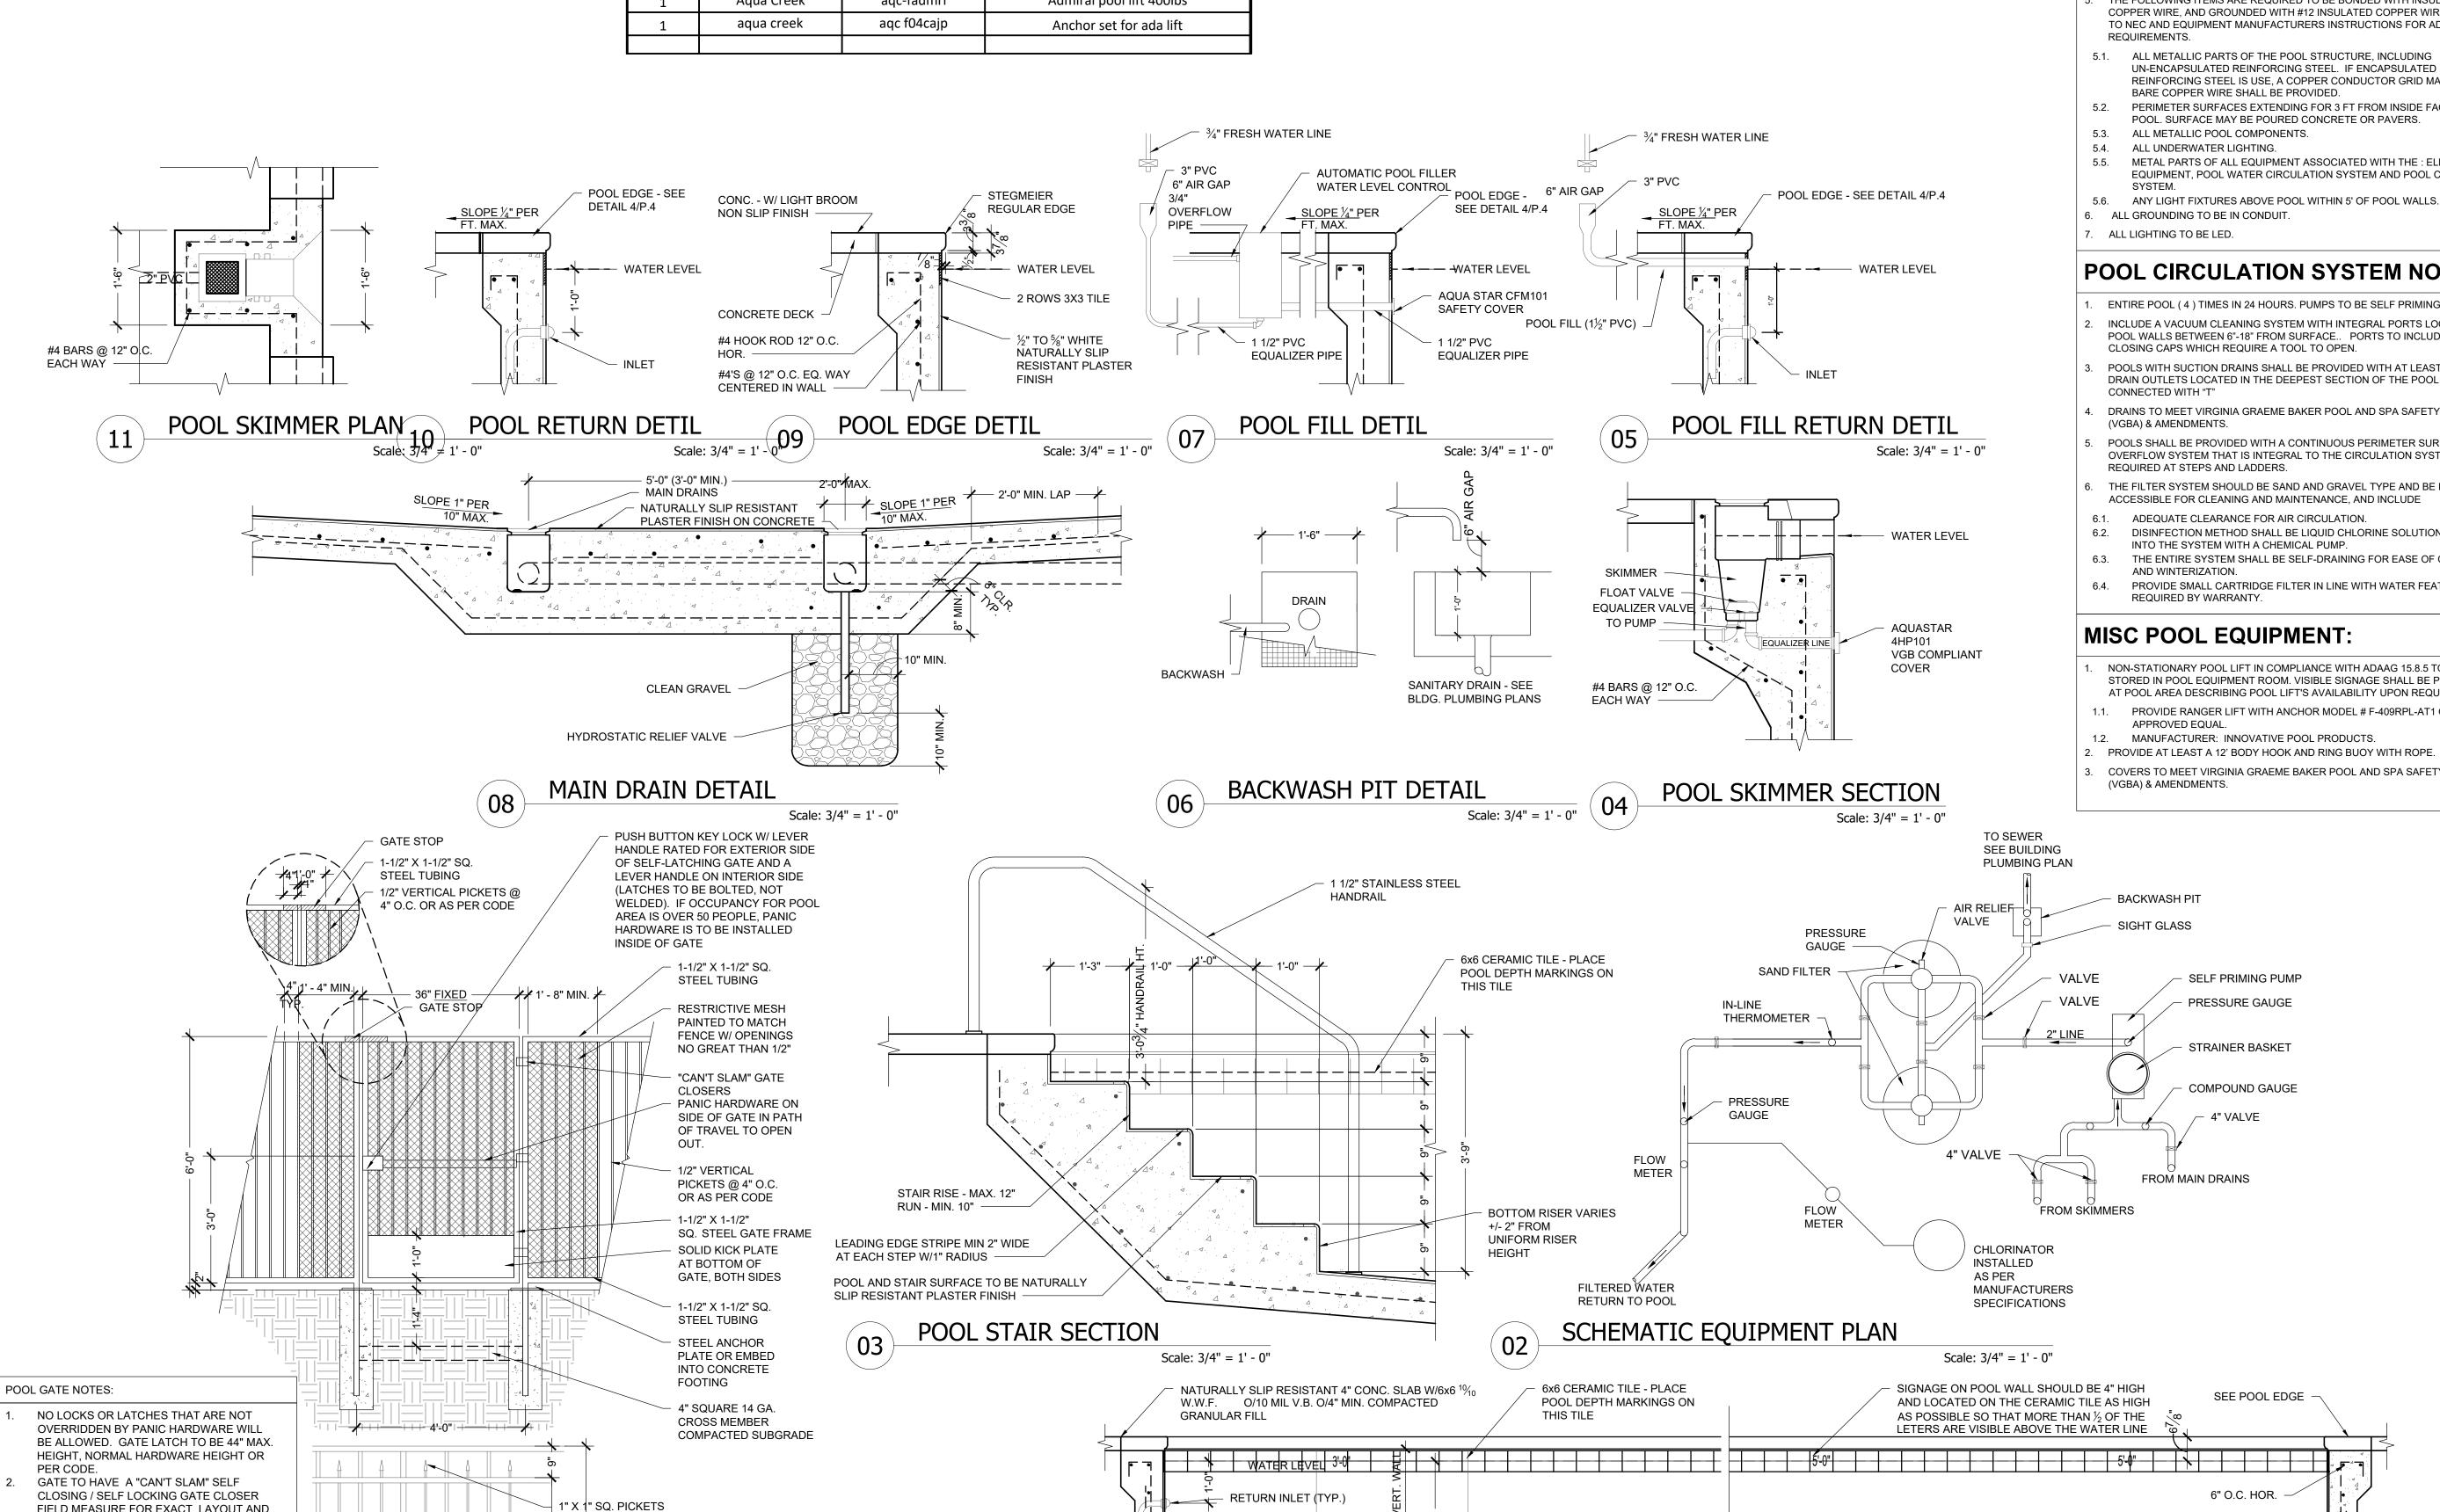

 $^{-}$ $^{1}\!\!\!/_{\!2}$ " TO $^{5}\!\!\!/_{\!8}$ " WHITE NA $^{+}$ URALLY SLIP $^{-}\!\!\!\!/_{\!2}$

SLOPE: 1" PER 10" MAX.

RESISTANT PLASTER FINISH

POOL PLUMBING NOTES:

- THE FOLLOWING ARE MINIMUM PERFORMANCE REQUIREMENTS:
- SUCH THAT EITHER LOCATION CAN HANDLE 100% OF THE FLOW. PIPE LAYOUT SHOWN IS REPRESENTATIVE OF THE DESIRED PIPE ROUTING, WITH ALLOWANCES FOR MINOR REALIGNMENTS AS REQUIRED BY FIED CONDITIONS. PIPE SHALL BE INSTALLED WITH THE LEAST NUMBER OF
- PIPING SHALL BE INSTALLED WITHOUT AIR ENTRAPPING HIGH POINTS FOR REVSER SLOPES.
- PIPE TRENCHES SHALL BE EXCAVATED TO THE FULL WIDTH AND DEPTH REQUIRED FOR PROPER INSTALLATION AND IN ACCRODANCE TO THE
- REQUIREMENTS OF THE PIPE MANUFACTURER AND APPLICABLE CODES. PARALLEL PIPING RUNS SHALL BE INSTALLED IN A COMMON TRENCH.
- PIPE MATERIAL SHALL BE NSF PW SHEDULE 40 PIPE. ALL PIPING IN EQUIPMENT ROOM SHALL BE LABELED WITH DIRECTIONAL
- LABEL ALL HOSE BIBS FOR VALVES THAT ALLOW ACCESS TO WATER
- 10. ALL PIPING SHALL BE PROPERLY SUPPORTED WHEN EXPOSED OR ENCASED IN CONCRETE FOR SUPPORT 11. USE TYPE 3 PEIPE FOR EXHAUST GAS FROM POOL HEATERS, WHERE USED.

POOL ELECTRICAL NOTES:

"NON-POTABLE".

- THE FOLLOWING ARE MINIMUM PERFORMANCE REQUIREMENTS:
- UNDERWATER LIGHTING SHALL BE AT LEAST 0.5 WATTS OR 8.35 LUMENS / SQ. FT. OF POOL SURFACE.
- COMPLETE INSTALLATION SHALL COMPLY WITH ARTICLE 680 OF THE NEC AND
- ALL ELECTRICAL EQUIPMENT IN POOL AREA SHALL BE BONDED TOGETHER WITH #8 COPPER WIRE OR LARGER PER NEC 680.26. THE FOLLOWING ITEMS ARE REQUIRED TO BE BONDED WITH INSULATED #8
- COPPER WIRE. AND GROUNDED WITH #12 INSULATED COPPER WIRE. REFER TO NEC AND EQUIPMENT MANUFACTURERS INSTRUCTIONS FOR ADDITIONAL
- UN-ENCAPSULATED REINFORCING STEEL. IF ENCAPSULATED REINFORCING STEEL IS USE, A COPPER CONDUCTOR GRID MADE OF #8 BARE COPPER WIRE SHALL BE PROVIDED. PERIMETER SURFACES EXTENDING FOR 3 FT FROM INSIDE FACE OF THE
- POOL. SURFACE MAY BE POURED CONCRETE OR PAVERS. ALL METALLIC POOL COMPONENTS. ALL UNDERWATER LIGHTING.
- METAL PARTS OF ALL EQUIPMENT ASSOCIATED WITH THE: ELECTRICAL EQUIPMENT, POOL WATER CIRCULATION SYSTEM AND POOL COVER
- 5.6. ANY LIGHT FIXTURES ABOVE POOL WITHIN 5' OF POOL WALLS. 6. ALL GROUNDING TO BE IN CONDUIT.

POOL CIRCULATION SYSTEM NOTES:

- ENTIRE POOL (4) TIMES IN 24 HOURS. PUMPS TO BE SELF PRIMING. INCLUDE A VACUUM CLEANING SYSTEM WITH INTEGRAL PORTS LOCATED IN POOL WALLS BETWEEN 6"-18" FROM SURFACE... PORTS TO INCLUDE SELF
- POOLS WITH SUCTION DRAINS SHALL BE PROVIDED WITH AT LEAST 2 MAIN DRAIN OUTLETS LOCATED IN THE DEEPEST SECTION OF THE POOL AND
- DRAINS TO MEET VIRGINIA GRAEME BAKER POOL AND SPA SAFETY ACT
- POOLS SHALL BE PROVIDED WITH A CONTINUOUS PERIMETER SURFACE
- OVERFLOW SYSTEM THAT IS INTEGRAL TO THE CIRCULATION SYSTEM. NOT REQUIRED AT STEPS AND LADDERS. THE FILTER SYSTEM SHOULD BE SAND AND GRAVEL TYPE AND BE EASILY
- ACCESSIBLE FOR CLEANING AND MAINTENANCE, AND INCLUDE
- 6.1. ADEQUATE CLEARANCE FOR AIR CIRCULATION. DISINFECTION METHOD SHALL BE LIQUID CHLORINE SOLUTION INJECTED INTO THE SYSTEM WITH A CHEMICAL PUMP.
- THE ENTIRE SYSTEM SHALL BE SELF-DRAINING FOR EASE OF CLEANING PROVIDE SMALL CARTRIDGE FILTER IN LINE WITH WATER FEATURES IF REQUIRED BY WARRANTY.

MISC POOL EQUIPMENT:

HOOK ROD

#4'S 12" O.C. EA. WAY

SLOPE:

4 4 4 4 7

£6----

Scale: 1/2" = 1' - 0"

POOL SECTION

#4'S 12" O.C. EA. WAY 🦯

1" PER 10" MAX.

12" O.C. VERT.

- NON-STATIONARY POOL LIFT IN COMPLIANCE WITH ADAAG 15.8.5 TO BE STORED IN POOL EQUIPMENT ROOM. VISIBLE SIGNAGE SHALL BE PROVIDED AT POOL AREA DESCRIBING POOL LIFT'S AVAILABILITY UPON REQUEST. PROVIDE RANGER LIFT WITH ANCHOR MODEL # F-409RPL-AT1 OR
- MANUFACTURER: INNOVATIVE POOL PRODUCTS. PROVIDE AT LEAST A 12' BODY HOOK AND RING BUOY WITH ROPE. COVERS TO MEET VIRGINIA GRAEME BAKER POOL AND SPA SAFETY ACT (VGBA) & AMENDMENTS.

GENERAL POOL SCOPE:

- A. THE FOLLOWING NOTES, EQUIPMENT LISTS, AND DETAILS ARE FOR GENERAL SCOPE AND DESIGN INTENT. THE SWIMMING POOL CONTRACTOR SHALL DESIGN THE ENTIRE POOL SYSTEM TO COMPLY WITH THE LATEST EDITION OF LOCAL POOL RULES, AND THE REQUIREMENTS OF THE STATE BOARD OF
- HEALTH, AND THE DESIGN CONCEPT AS SHOWN ON THE DRAWINGS AND AS STATE BELOW CONTRACTOR TO PROVIDE SUBMITTALS AND SHOW DRAWINGS FOR OWNER
- REVIEW. THE DESIGN TEAM IS NOT RESPONSIBLE FOR DESIGN OR COORDINATION OF THE POOL, POOL DECK, EQUIPMENT AND SYSTEMS.
- SWIMMING POOLS SHALL BE CONSTRUCTED BY A CONTRACTOR LICENSED IN THE STATE. FURNISH ALL MATERIAL, LABOR, EQUIPMENT, AND SERVICES TO COMPLETE

INSTALLATION OF THE SWIMMING POOL AND SURROUNDING AREA AS SHOWN

ON THE DRAWINGS. DRAWINGS AND SPECIFICATION FOR CONSTRUCTION OF THE POOL AND SYSTEM SHALL BE PREPARED UNDER THE SUPERVISION OF A PROFESSIONAL ENGINEER OR ARCHITECT REGISTERED IN THE STATE AT WHICH THE PROJECTED IS TO BE LOCATED. THESE DRAWINGS AND SPECIFICATION SHAL

BE SPECIFIC IN NATURE AND SHALL INCLUDE CONSTRUCTION DETAILS

MATERIAL PERFORMANCE. INSTALLATION OF THE POOL AND SYSTEMS SHALL BE COMPLETE INCLUDING, BUT NOT LIMITED TO:

THE SPECIFICATIONS SHALL INCLUDE STANDARDS OF WORKMANSHIP AND

SHOWING THE IDENTIFICATION, LOCATION, AND THICKNESS OF ALL MATERIALS

- F.A. CONCRETE POOL DECK
- F.B. ALL WATER DISTRIBUTION FROM DECK WASH DOWN AND POOL FILLING.
- F.C. ALL LADDERS, HANDRAILS, AND POOL ACCESS POINTS
- F.D. FILTER AND FEED SYSTEM
- F.E. UNDERWATER AND POOL DECK LIGHTING F.F. ALL SAFETY AND LIFEGUARD EQUIPMENT
- F.G. ALL WARNING SIGNS AND INFORMATION POSTINGS F.H. ALL WATER TESTING EQUIPMENT
- F.I. VACUUM SYSTEM AND EQUIPMENT FOR CLEANING POOL
- F.J. CONNECTION TO SANITARY AND WATER FACILITIES F.K. POOL COVER FOR POOL
- G. CONTRACTOR TO SECURE ALL PERMITS REQUIRED FOR THEIR SCOPE . AS PART OF THE BID SUBMISSION, SUB-CONTRACTOR SHALL CONIRM
- FILTER ROOM DOOR SIZES ARE SIZED APPROPRIATELY TO FIT POOL EQUIPMENT INTO ROOM. CONTRACTOR TO ASSUME THE ROOM WILL B COMPLETE PRIOR TO THEIR SCOPE STARTING ON SITE.
- POOL SUB-CONTRACTOR SHALL ASSIST GENERAL CONTRACTOR TO ENSURE THAT OTHER TRADES PROVIDE HEALTH DEPARTMENT REQUIRED EQUIPMENT SUCH AS:
- I.A. FILL WATER BACKFLOW PREVENTER
- I.B. DRINKING FOUNTAIN.
- I.C. HOSE BIBS.
- I.D. MECHANICAL VENTILATION AT THE CHEMICAL STORAGE ROOM
- I.E. FLOOR DRAIN SIZED FOR 2" PVC DISCHARGE. I.F. TELEPHONE CONNECTION AND EXTERIOR RATED BOX LOCATED IN
- THE POOL ENCLOSURE. I.G. HOLDING TANKS.
- CONTRACTOR SHALL COLOR CODE PIPING: SUPPLY, RETURN, DISCHARGE, CHEMICAL.
- SUBMITTAL REQUIREMENTS: K.A. PRODUCT DATA FOR ALL EQUIPMENT
- K.B. PIPING DIAGRAM.
- K.C. ELECTRICAL WIRING DIAGRAM.

POOL DESIGN CRITERIA:

POOL SHALL BE CONSTRUCTED OF AN IMPERVIOUS WATER TIGHT, POURED CONCRETE THROUGHOUT OR GUNITE CONSTRUCTION WITH MARBLEIZED

- THE SWIMMING POOL SHALL BE DESIGNED AND CONSTRUCTED TO WITHSTAND ALL ANTICIPATED LOADING FOR BOTH FULL AND EMPTY CONDITIONS. A HYDROSTATIC RELIEF VALVE AND/OR A SUITABLE JNDERDRAIN SYSTEM SHALL BE PROVIDED. THE DESIGNING ARCHITECT OR ENGINEER SHALL CERTIFY THE STRUCTURAL STABILITY AND THE SAFETY OF
- THE POOL IN BOTH FULL AND EMPTY CONDITIONS. CORNERS FORMED BY INTERSECTION OF WALLS OR FLOOR SHALL BE COVE
- VERTICAL WALLS SHALL NOT EXCEED 11 DEGREES FROM PLUMB.
- HAVE A DEPTH GREATER THAN 24" FROM WATER SURFACE. IN AREAS OF THE POOL WITH DEPTH LESS THAN 5', THE BOTTOM SLOPE SHAL

IF USED, UNDERWATER BENCHES SHALL NOT EXCEED 18" FROM WALL OR

- BE UNIFORM AT LESS THAN 1:10. IN AREAS OF THE POOL WITH DEPTH GREATER THAN 5', THE BOTTOM SLOPE
- SHALL NOT EXCEED 1:3. DO NOT INCLUDE DIVING EQUIPMENT
- MINIMUM DEPTH SHALL BE 3' 0".
- 10. MAXIMUM DEPTH OF SHALLOW END SHALL BE 6'-0".
- 11. (2) ROWS OF TILE AT THE WATER LINE AND CONCRETE COPING. 12. FINISH COLOR SHALL BE WHITE OR LIGHT COLOR TO BE APPROVED BY
- 13. BOTTOM SURFACES TO BE SLIP RESISTANT IN AREAS WHERE THERE IS LESS THAN 36" OF WATER.
- 14. POOL SHALL INCLUDE AN UNOBSTRUCTED DECK AREA 10' WIDE AROUND POOLS < 1,600 SQ. FT., AND 15' WIDE AROUND POOLS > 1,600 SQ. FT, MINIMUN
- 15. ALL DECK AREAS SHALL INCLUDE SLIP-RESISTANT IMPERVIOUS SURFACE
- PROVIDE HOSE BIBS AROUND POOL AREA TO REACH ALL PORTIONS OF THE POOL AND DECK WITH A 100' HOSE.
- PROVIDE DECK AND POOL MARKINGS / SIGNAGE, ACCESS POINTS, LADDERS AND STEPS AS REQUIRED PER CODE. BACKFILL MATERIAL SHALL BE SATISFACTORY SOIL FREE FROM CLAY, ROCK OR GRAVEL LARGER THAN 2" IN ANY DIMENSIONS, DEBRIS, WASTE, FROZEN
- MATERIALS, OR OTHER DELETERIOUS MATTER. FILL SHOULD BE PLACED IN LIFTS AND COMPACTED TO AT LEAST 95% MAXIMUM STANDARD PROCTOR DENSITY NEAR THE OPTIMUM MOISTURE CONTENT.
- ALL FILL MATERIAL FOR SUPPORT OF FLOOR SLABS SHALL BE COMPACTED 1 98% OF MAXIMUM STANDARD PROCTOR DENSITY WITHIN 2% OF OPTIMUM
- 0. POOL DECKING SHALL SLOPE 1/4" PER FT. TO DECK DRAINS OR ADJACENT
- 1. ALL SEATS, STEPS, AND PROTRUDING FIXTURES SHALL HAVE 2" DARK

CONTRASTING TILE SAFETY STRIP.

X PLAN KEY NOTES

- WATER FEATURE. POOL FURNITURE BY MANAGEMENT 3. 1 1/2" DIA. STAINLESS STEEL HANDRAIL
- 4. ADA POOL LIFT. 6'-0" HIGH STEEL FENCE WITH SQ. PICKETS AT 4" O.C.-TYP.13/G131
- LIGHT POSTS, SEE SITE LIGHTING PLANS.
- 2X2 LEADING EDGE TILE TO BE NATURALLY SLIP RESISTANT & CONTRASTING COLOR TO POOL. MAINTAIN 5' CLEAR DECK AROUND POOL. DO NOT ENCROACH WITH

3'-0" X 6'-0" SELF CLOSING SELF LATCHING, LOCKABLE GATE WITH

- PANIC DEVICE AND EXIT SIGN. GATE ENTRANCE SHALL BE ON AN ACCESSIBLE ROUTE. 10. STRUCTURAL REINFORCING REBAR (TYPICAL).
- 11. 1" RADIUS AT CORNERS, TYP. 12. S.S. SLADDER 13. SIGNAGE ON POOL DECK AND POOL WALLS.
- 14. LINE OF RADIUS BETWEEN POOL WALL AND FLOOR. 15. UNDERWATER LIGHT.
- 16. #8 COPPER BOND WIRE TO PUMP. 17. WEATHER PROOF EMERGENCY 911 PHONE MOUNTED ON FENCE NEXT
- 18. CARD READER W/ 3/4" CONDUIT TO MECHANICAL ROOM CARD READER TO BE SET TO ALLOW SWIMMING ONLY FOR DESIGNATED TIMES NIGHT SWIMMING TO BE PROHIBITED.
- 19. 4" GATE POSTS IN CONCRETE, DO NOT ANCHOR TO SLAB. 20. BOND TO POOL REINFORCING. 21. #8 COPPER BOND WIRE

COORDINATION W/ OTHER TRADES


PROVIDE A TELEPHONE WITH CAPABILITY TO DIRECT DIAL 911 EASILY ACCESSIBLE AND CLEARLY MARKED WITHIN THE POOL AREA.

- EQUIPMENT ROOM SHALL BE LOCKED WHEN NOT IN USE BY POOL OPERATOR. SLOPE FLOORS, OF POOL EQUIPMENT ROOM, 1/4" / FT TO DRAIN. SWIMMING POOLS SHALL BE COMPLETE ENCLOSED BY A FENCE NOT LESS
- THAN 4' TALL OR WALLS OF A BUILDING, IBC 3109.3. FENCE AROUND POOL IS BY LANDSCAPE SUB-CONTRACTOR. LIGHTING AROUND POOL AREA, NOT CONNECTED TO THE POOL, SHALL BE BY THE ELECTRICAL SUB-CONTRACTOR.

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ROJECT TITLE


CITY ARC COMMENTS REVISIONS MARK DESCRIPTION

SSUED FOR:

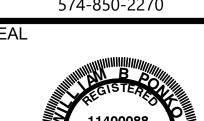PERMIT SET- STATE CDR

DRAWN BY: BP CHECKED BY: BP


SHEET TITLE POOL SCOPE **BASIS OF DESIGN**

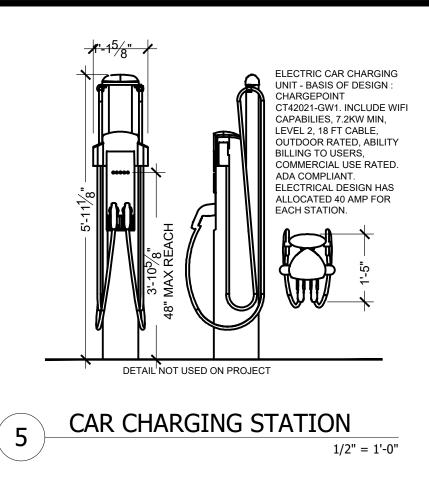


CONCRETE PAD SHALL BE DESIGNED TO WITHSTAND

1 DUMPSTER ENCLOSURE


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SHEET NUMBER

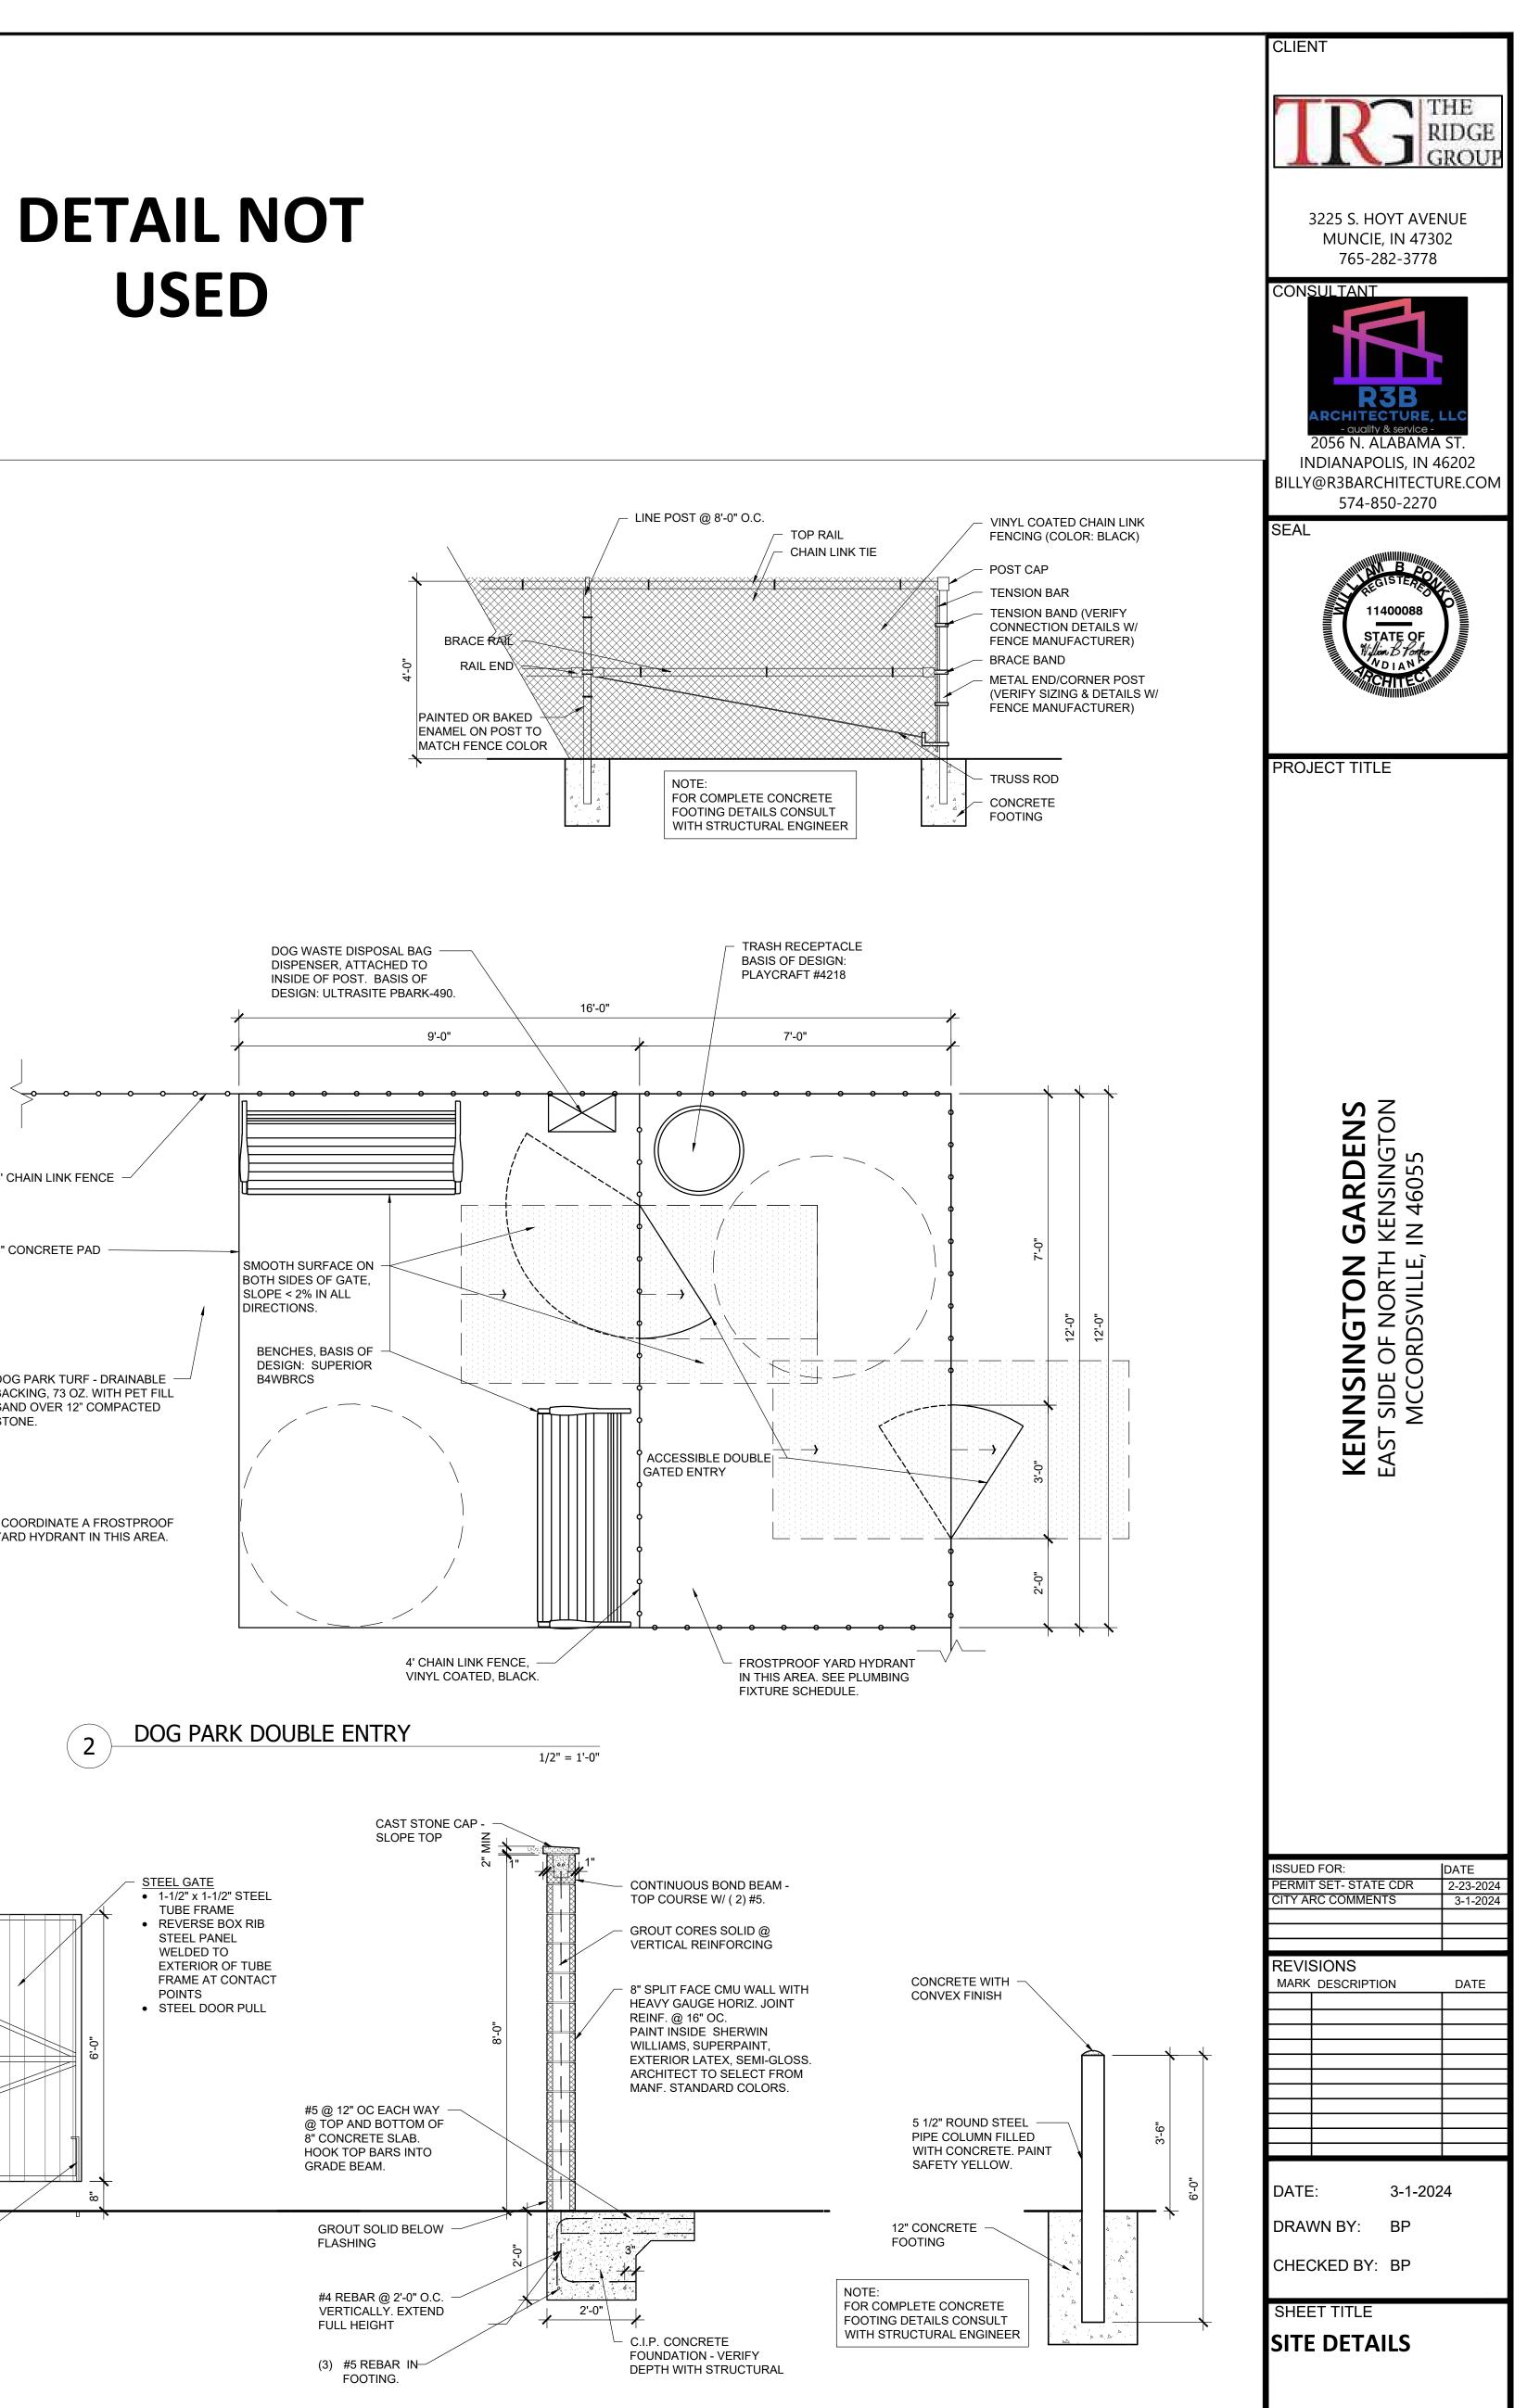
1/2" = 1'-0"

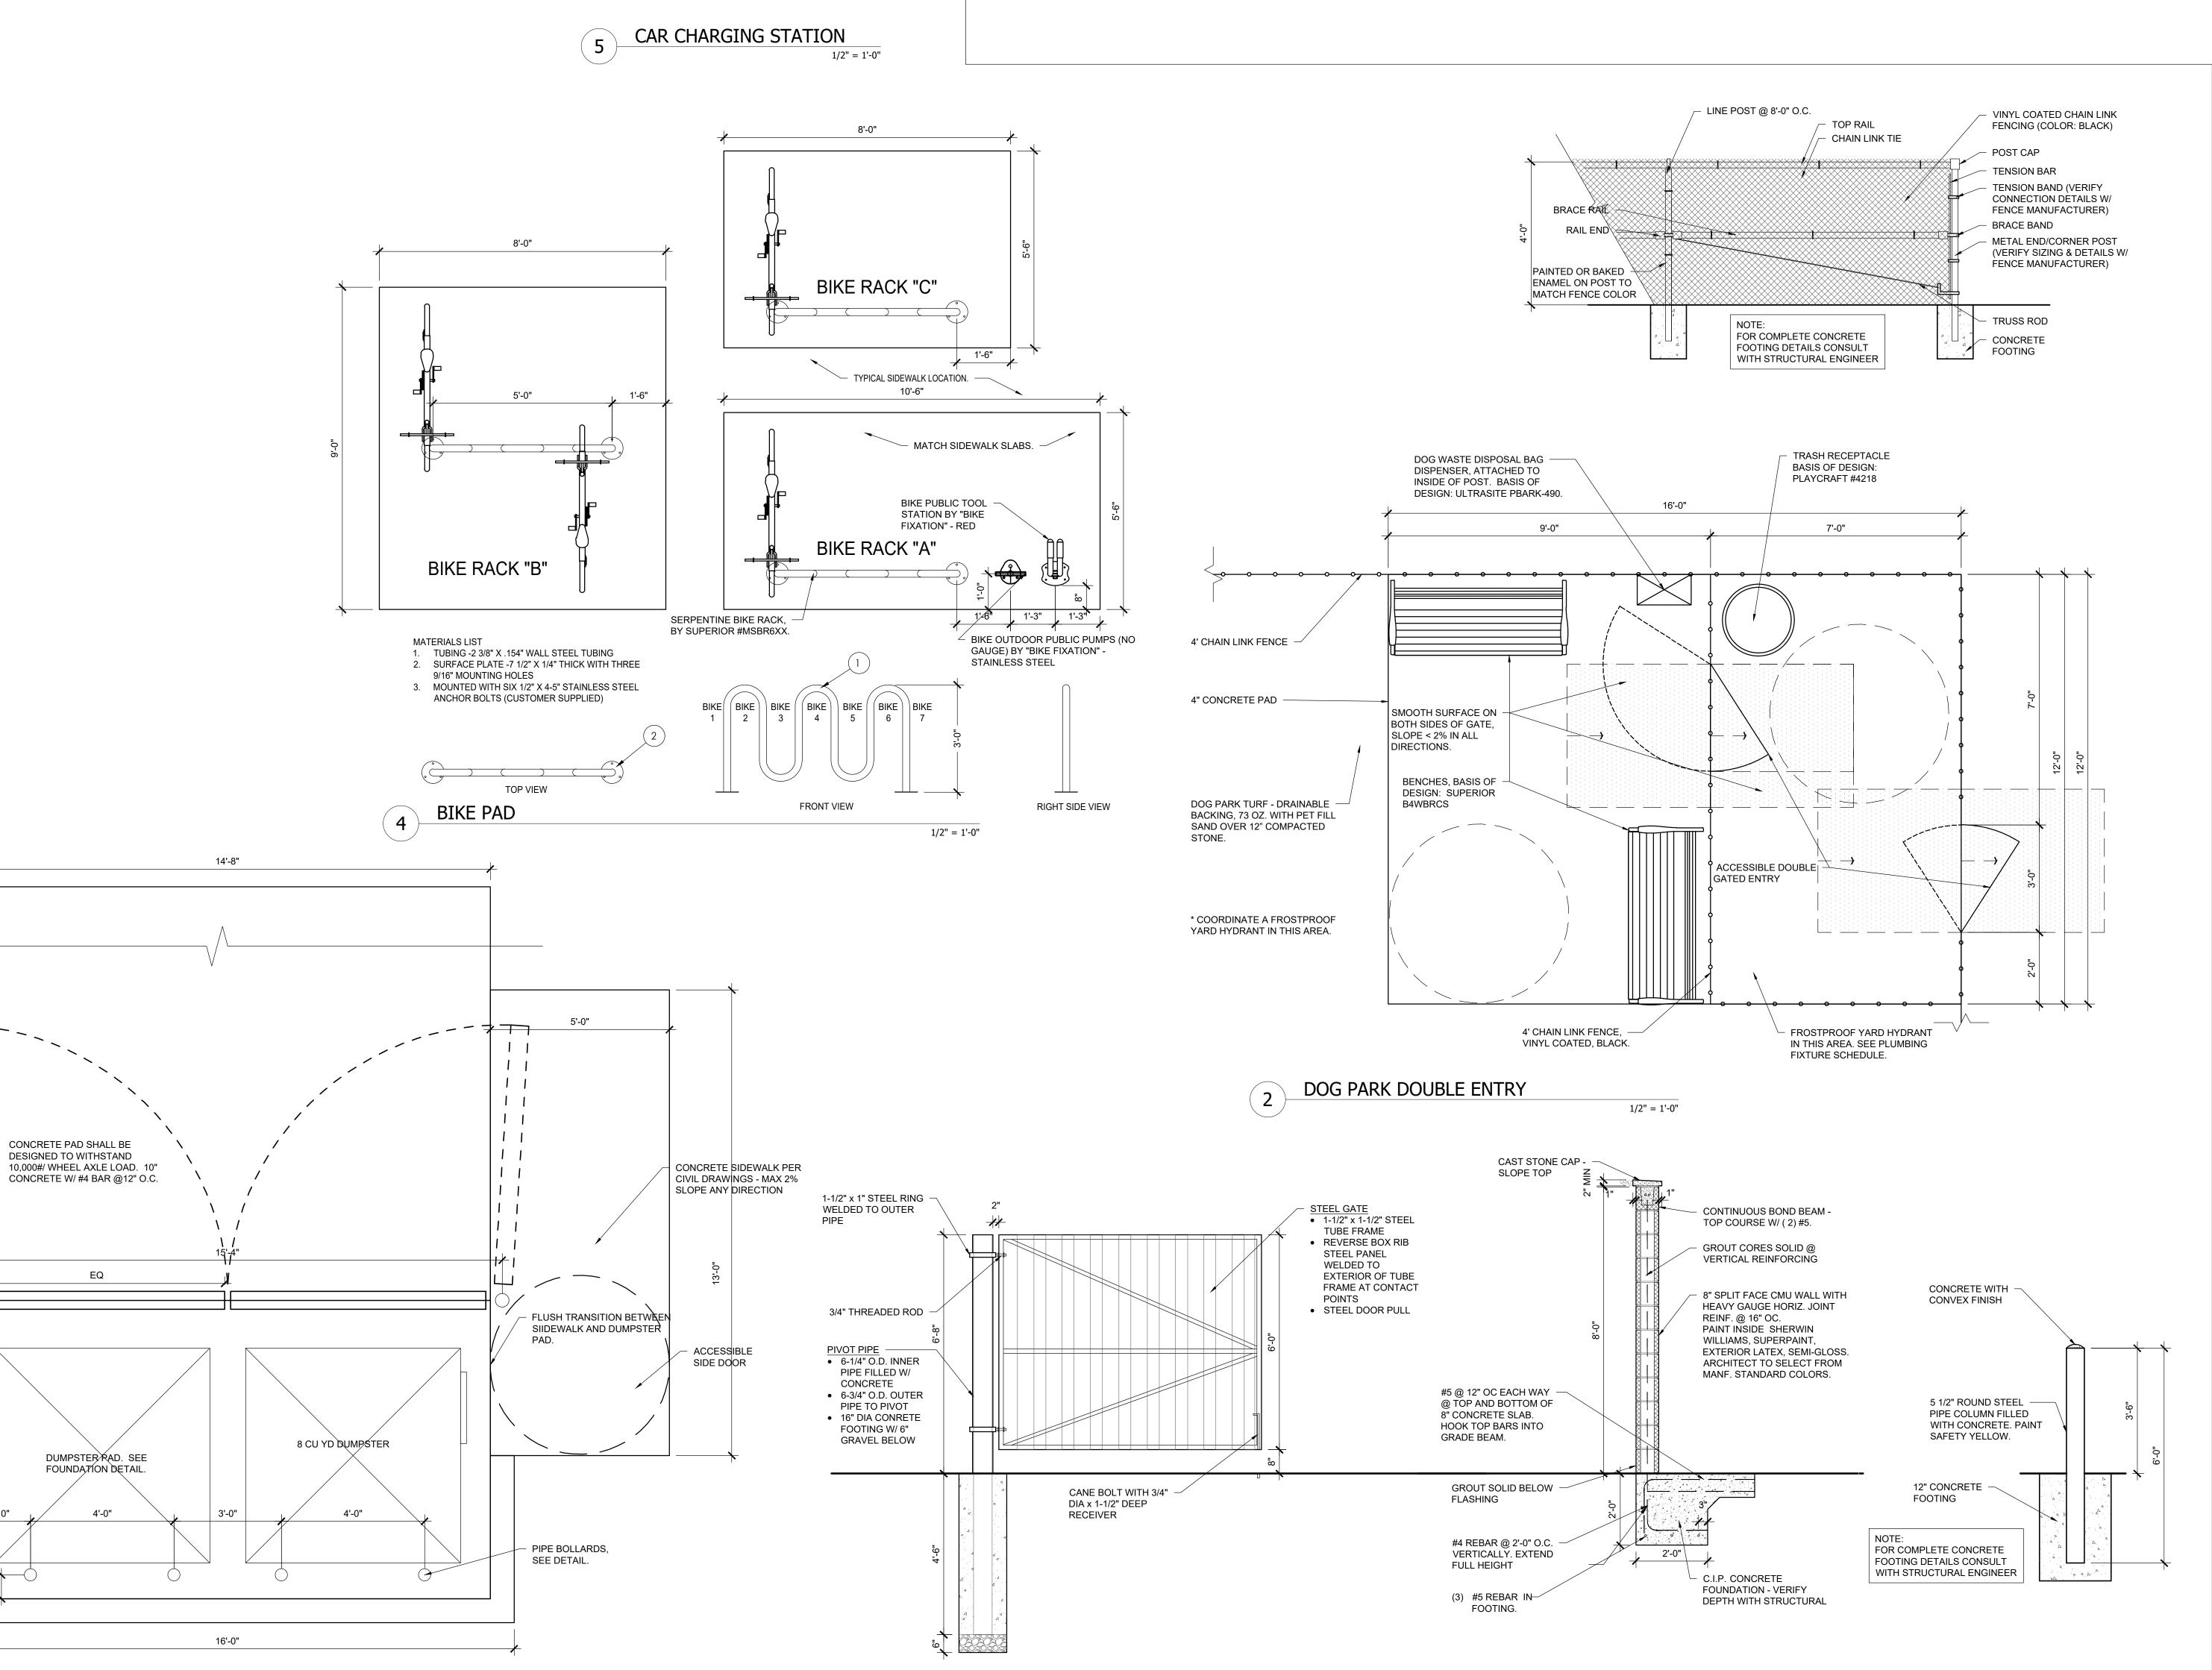

FLOOR PLAN BUILDING TYPE-A - LEVEL 2

Scale: 1/8" = 1' - 0"

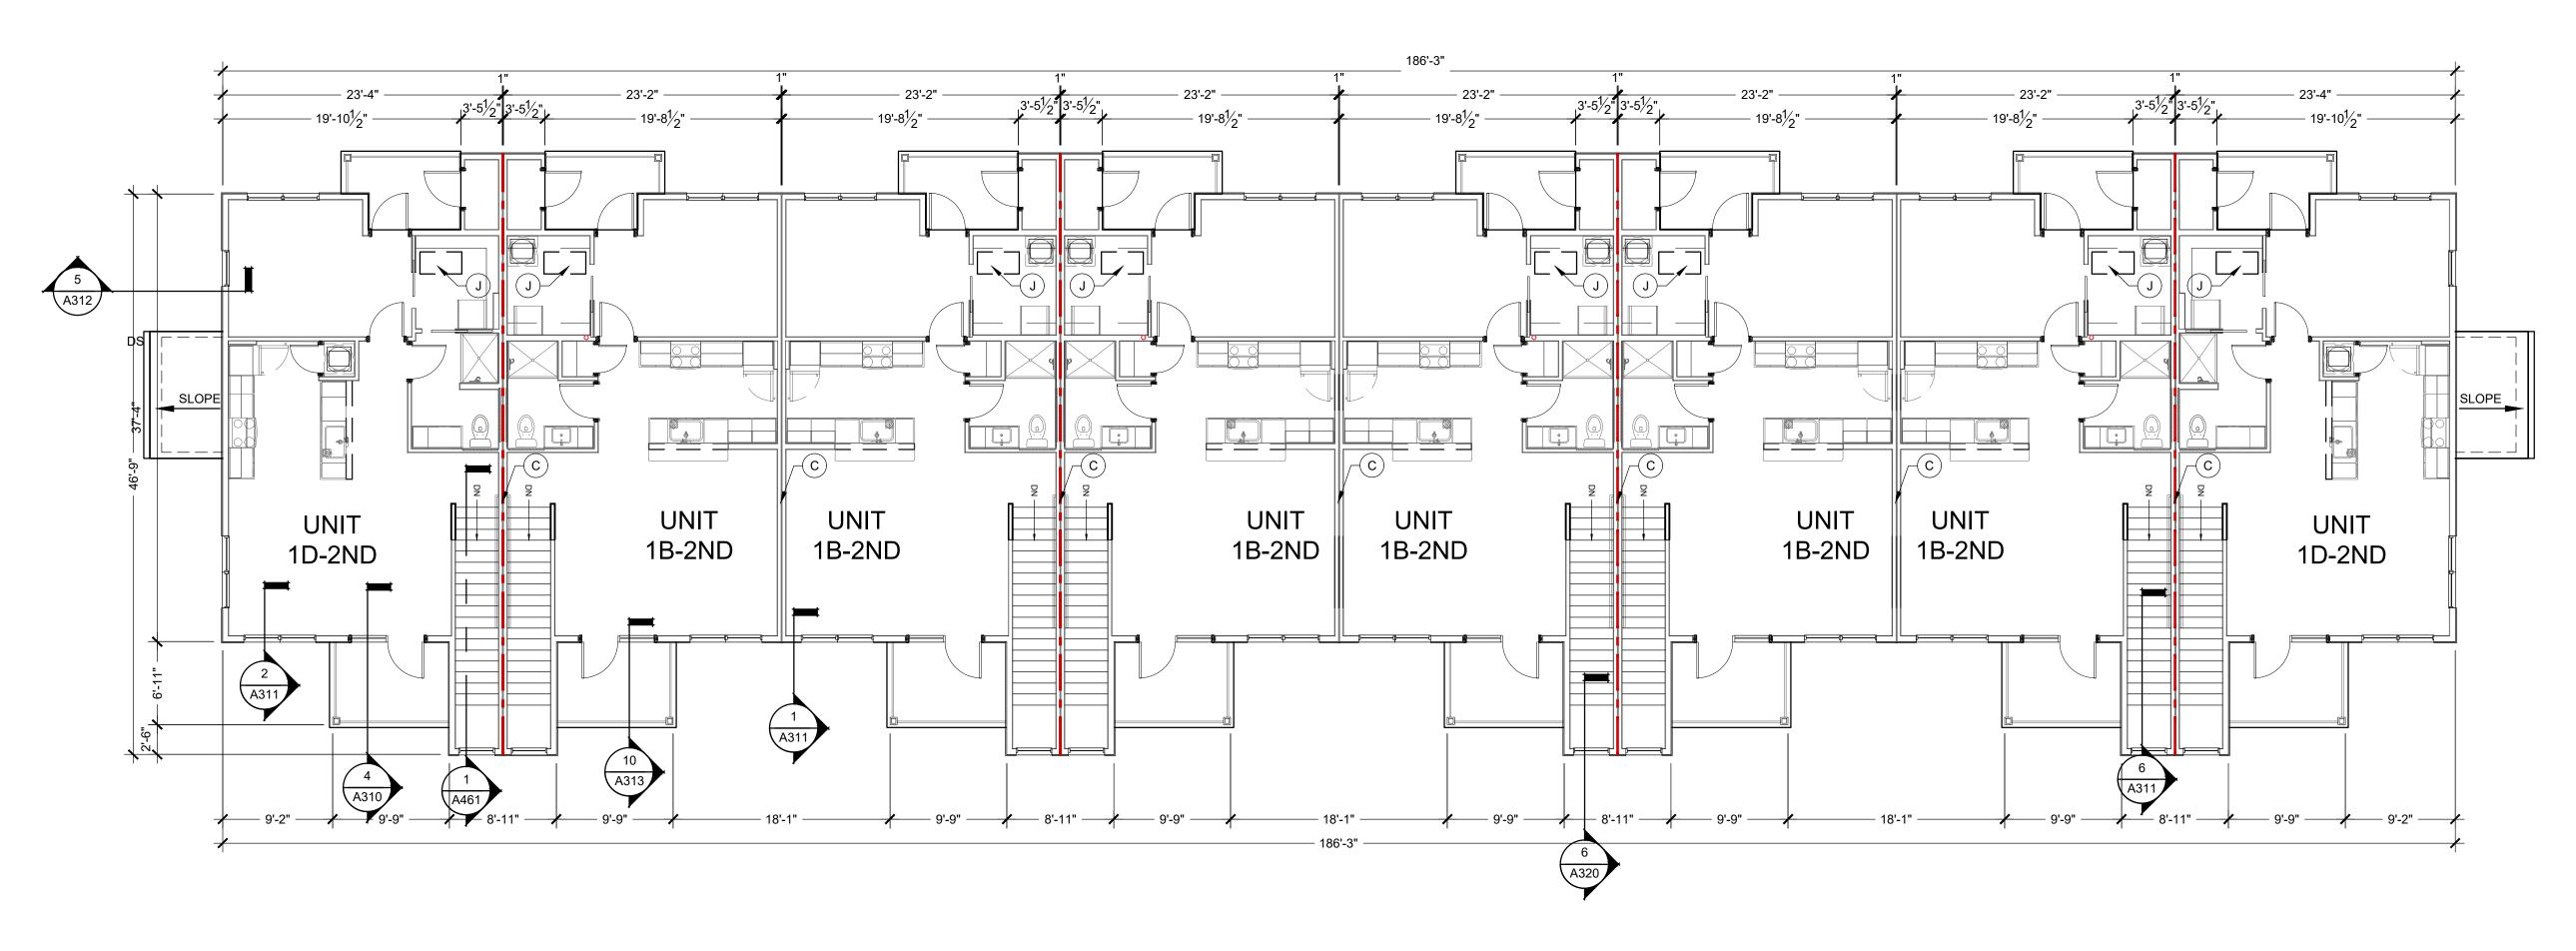Scale: 1/8" = 1' - 0"

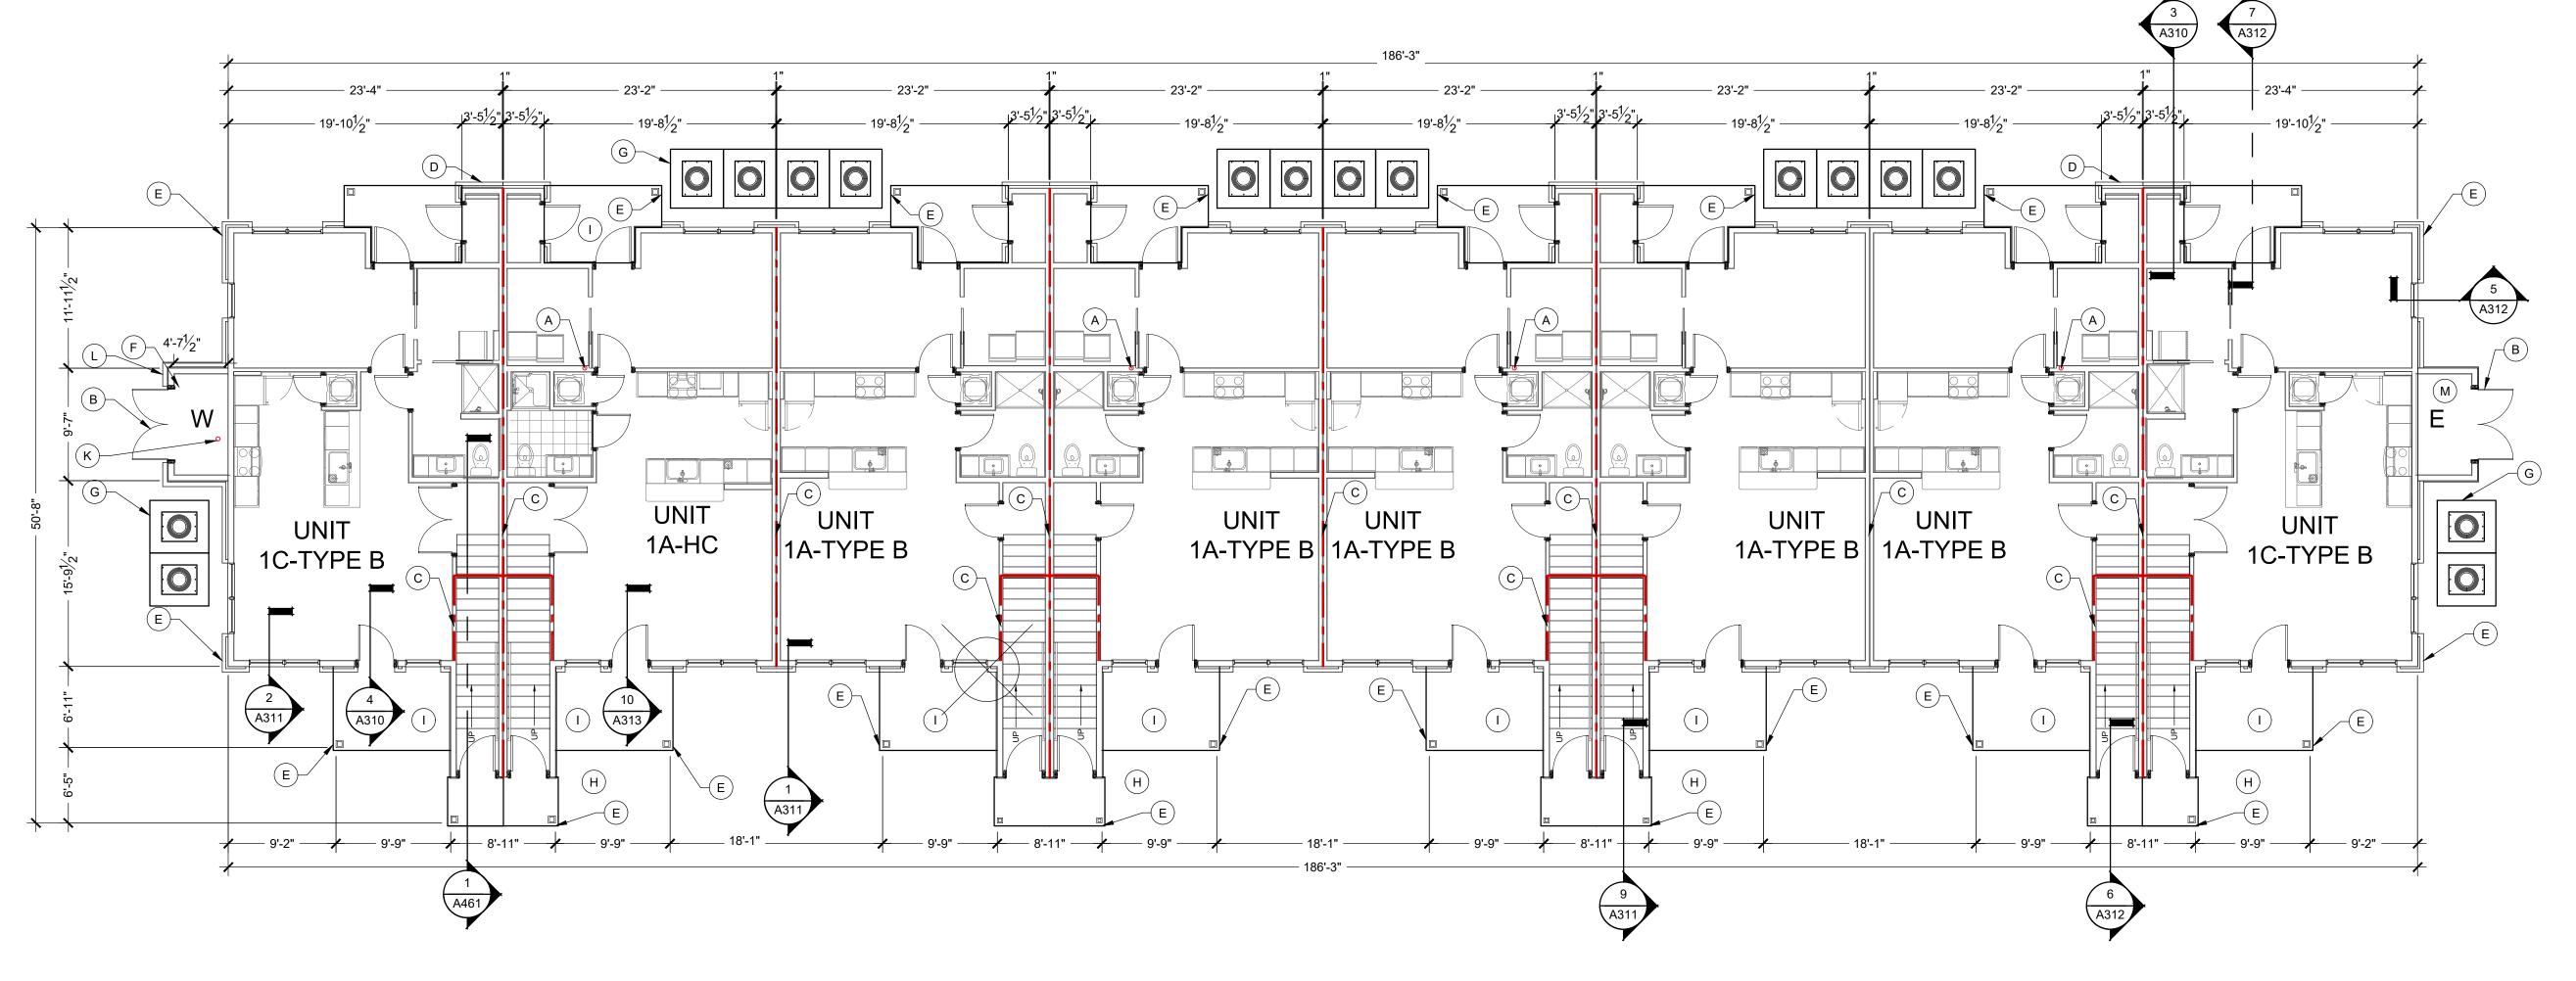

FLOOR PLAN BUILDING TYPE-A - LEVEL 1

GENERAL FLOOR PLAN NOTES

1. FLOOR TRUSSES ARE TO BE POSITIONED SO THEY DO NOT INTERFERE WITH PLUMBING AND HVAC, ADJUST SPACING AS NECESSARY. REFER TO SPECIFICATIONS AND STRUCTURAL PLANS FOR ADDITIONAL

2. DETAILED FLOOR AND ROOF TRUSS FRAMING DIAGRAMS ARE TO BE FURNISHED BY A STRUCTURAL ENGINEER LICENSED IN THE STATE. 3. ROUGH OPENINGS IN EXTERIOR WALLS SHALL BE UPSIZE APPROXIMATELY 1/2" TO ACCOMMODATE SHRINKAGE AT GROUND FLOOR

OF WOOD BUILDINGS 3-4 STORIES AND GREATER FOR 5 STORIES... 4. ALL DIMENSIONS ARE TO FACE OF STUDS.

5. ALL CONTRACTORS ARE REQUIRED TO COORDINATE THEIR WORK WITH ALL DISCIPLINES TO AVOID CONFLICTS, SEE MECHANICAL, ELECTRICAL AND PLUMBING DRAWINGS FOR ADDITIONAL INFORMATION REGARDING SIZE AND QUANTITY OF OPENINGS, SLAB REQUIREMENTS AND LINTELS. INCLUDE FIRE PROTECTION NOT SHOWN ON PLANS.

6. SEAL AROUND ALL PENETRATIONS TO INSURE TIGHT BUILDING ENVELOPE. SEE A390 AND A391 FOR ADDITIONAL INFORMATION. 7. PROVIDE FIRE SEALANT AROUND ALL PENETRATIONS THROUGH RATED

8. ALL WALLS ARE PAINTED UNLESS NOTED OTHERWISE.

9. COORDINATE BUILDING STEP LOCATIONS WITH FLOOR ELEVATIONS SHOWN ON ARCHITECTURAL AND CIVIL SITE PLANS. 10.PATIO SLOPES SHALL BE 1/4" PER FOOT MAX. AWAY FROM UNIT AND

11.PROVIDE CONTROL JOINTS IN GYPSUM BOARD ASSEMBLIES AS RECOMMENDED BY MANUFACTURER. PROVIDE CJ IN CEILINGS SO NO DIMENSION EXCEEDS 50 FT. IN EITHER DIRECTION WHERE THERE IS PERIMETER RELIEF OR 30 FT. IN EITHER DIRECTION WITHOUT PERIMETER RELIEF. DO NOT SEPARATE SUSPENSION SYSTEM. CAULK SEAL JOINT AND PAINT TO MATCH.

12.REFER TO G100 SERIES DRAWINGS FOR ADDITIONAL INFORMATION ON ACCESSIBILITY. SHEETS ARE INCLUDED FOR REFERENCE ONLY. CONTRACT SHOULD NOT MAKE ADJUSTMENTS TO THE PLANS WITHOUT APPROVAL FROM ARCHITECT.

13.REFER TO ELECTRICAL DRAWINGS AND E307 AND E308 FOR ADDITIONAL INFORMATION AND CLARIFICATION OF DESIGN-BUILD SCOPE FOR ACCESS CONTROLS, SECURITY CAMERAS, DOOR OPERATORS, AND DATA/TV. ICONS AND SYMBOLS SHOWN ON FLOOR PLANS FOR COORDINATION ACROSS DESIGN DISCIPLINES.

14.REFER TO WALL SECTIONS A300 SERIES FOR UL ASSEMBLIES FOR

HORIZONTAL ASSEMBLIES AND EXTERIOR WALL INFORMATION. 15.PROVIDE DEFLECTION CLIPS AT ALL NON-BEARING WALLS WHERE THE WALLS DO NOT STACK VERTICALLY THROUGH THE BUILDING. SEE 6/A540. TYPICAL WHERE UNITS ARE ABOVE AMENITY AREAS. SEE STRUCTURAL SET S310 FOR DETAIL.

16. HANDRAILS AT BALCONIES ON FLOORS 2 AND UP. NOT SHOWN ON FLOOR PLANS. 17. REFER TO A040 FOR MOUNTING DETAILS FOR ACCESS CONTROLS,

DOOR OPENERS, CALL BOXES, AND PEDESTALS AT ENTRY DOORS. 18.REFER TO A510 FOR ADDITIONAL SPRINKLER DETAILS WHERE INSULATION MAY BE REQUIRED BELOW TOP OF ROOF DECK. TO BE COORDINATED WITH FINAL SPRINKLER INSTALLER.

19. REFER TO A531 FOR ADDITIONAL PLAN DETAILS FOR "FIRE WALLS".

20.ALL CORRIDOR WALLS ARE TO BE WALL TYPE 1C1 WITH RC-DELUXE RESILIENT CHANNEL ON THE CORRIDOR SIDE, UNLESS NOTED DIFFERENTLY. SEE STRUCTURAL FOR SHEARWALL LOCATIONS. CORRIDORS ARE NOT USED FOR SHEARWALLS THIS PROJECT. 21.END LIST

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CLIENT

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MUNCIE, IN 47302

765-282-3778

2056 N. ALABAMA ST

INDIANAPOLIS, IN 46202

ROJECT TITLE

GARDENS H KENSINGTON IN 46055

KENNSINGTON (EAST SIDE OF NORTH MACCORDSVILLE, II

FLOOR PLAN KEYED NOTES:

A. RADON VENT. REFER TO G110 FOR ADDITIONAL INFORMATION. B. DOUBLE 36" DOORS, INSULATED, SEE DOOR SCHEDULE #B01. C. 1 HOUR DEMISING WALL.

D. METER CENTER, SEE ELECTRICAL DRAWINGS. PROVIDE DOUBLE WAL CLOSET. COORDINATE DOUBLE WALLS AS NEEDED FOR ELECTRICAL GEAR AND METERS.

E. DOWNSPOUT, SEE ROOF PLANS FOR MORE INFORMATION. CONNECT T CIVIL STORM SYSTEM. PAINT EXPOSED STORM EXTENSIONS TO MATCH DOWNSPOUTS.

F. SPRINKLER CLOSET, ONLY OCCURS ON ONE END OF BUILDING. SEE SITE PLAN FOR LOCATION. G. MECHANICAL EQUIPMENT PAD, COORDINATE WITH SUPPLIER OF HVAC EQUIPMENT THE SIZE AND LOCATION.

H. DRAINAGE TILE TO BE INSTALLED UNDER CONNECTING WALKWAY AT DOWNSPOUT, SEE SITE PLAN AND CIVIL DRAWINGS FOR LOCATION OF

SEE SLAB EDGE PLANS. TO BE FLUSH WITH INTERIOR SLAB AND SLOPE

AWAY FROM BUILDING. NO STEP ALLOWS FROM SIDEWALK TO THE DOOR OF THE UNIT FOR FHA REQUIREMENTS. J. ATTIC ACCESS AT ALL TOP FLOOR UNITS.SEE DETAIL 6/A521.

K. FLOOR DRAIN, SEE PLUMBING FOR COORDINATION OF BUILDING ORIENTATION ON SITE. .. DASHED LINE SHOWS BRICK, WHICH VARIES FROM OTHER BUILDINGS.

ADDITIONAL BRICK REQUIRED AT MEP CLOSET IN LIEU OF LAP SIDING, SEE SLAB EDGE PLANS, AND ELEVATIONS AT TYPE B: BUILDING #2, TYPE A: BUILDING # 5 & 9.

M. ELECTRICAL CLOSET, ONLY OCCURS ON ONE END OF BUILDING. SEE SITE PLAN FOR LOCATION. CLUBHOUSE ONLY:

N. MAINTAIN 18" KNEE CLEARANCE UNDER COUNTERTOP. O. SEE INTERIORS FOR ADDITIONAL INFORMATION, FINISHES, ETC...

P. FIRE EXTINGUISHER CABINET, FULLY RECESSED. Q. FIRE EXTINGUISHER, BRACKET MOUNTED. R. DRINKING FOUNTAIN, HI-LOW CONFIGURATION WITH BOTTLE FILLER.

S. GLASS GARAGE DOOR. T. PROVIDE SOUND INSULATION AROUND ALL OFFICES, CLOSING ROOM,

LEASING, RESTROOMS, FITNESS CENTER AND COMMUNITY ROOM.

ITY ARC COMMENTS

REVISIONS

MARK DESCRIPTION

CHECKED BY: BP

OVERALL FLOOR

SHEET TITLE

PLANS

LEVEL 1-2

SHEET NUMBER

(NOT ALL RATING LINE TYPES ARE **NECESSARILY USED IN THIS PROJECT)** LOAD BEARING WALL OVERLAY REFER TO STRUCTURAL DRAWINGS FOR LOCATIONS.



1 HR RATED "FIRE PARTITION". WALL EXTENDS FROM RATED ASSEMBLY TO RATED ASSEMBLY. 1 HR RATED "FIRE BARRIER". WALL EXTENDS THROUGH INTERSECTING ASSEMBLIES. 2 HR RATED "FIRE BARRIER". WALL

EXTENDS THROUGH INTERSECTING ASSEMBLIES. 2 HR RATED "FIRE WALL" CONTINUOUS WITHOUT INTERRUPTION.

DRAWN BY: BP

SEE STRUCTURAL FOR ALL SHEAR WALL LOCATIONS.

 SEE WALL ASSEMBLY ON G030 AND G040 SERIES SHEETS FOR SPECIFIC ASSEMBLY REQUIREMENTS. RATED WALLS INSIDE UNITS ARE FIRE RATED DUE TO

SEE E307 AND E308 FOR ADDITIONAL INFORMATION.

CONSTRUCTION TYPE OF BUILDING AND FIRE RATING REQUIRED FOR CERTAIN ELEMENTS IN ACCORDANCE WITH TABLE 601.

LOW VOLTAGE LEGEND ACCESS CONTROLS

SECURITY CAMERA. SEE E020 AND E021 FOR ADDITIONAL INFORMATION.

DO

СВ

AUTOMATIC DOOR OPENER INTERCOM CALL BOX

KOOF \	/ENTILATION	ON REQUI	REMENTS					
1CCORDS ILLE		,		UPDATED		2/5/2024		
OX VENT I	BASIS OF DESIGN	FREE VENTILAT	ION AREA.			X=	144	
OFFIT VEN INEAR FT.	IT BASIS OF DESI	GN "HARDIESOF	FIT, FREE VENTILA	TION AREA/		X=	5	
	BOX VENTS =	80%	SOFFIT VENTS =	40%				
xception # > 80% of	1 - The net free	area shall be red	ALL BE > 1/X OF TH luced to 1/300 pro the upper portion	vided that 50% <		X=	300	
	ATTIC AREA (SQ. FT.)	TOTAL FREE AREA (TVA) (SQ. INCHES)	BOX VENT AREA (SQ. INCHES) (NFVA / 2)	# OF BOX VENTS REQUIRED, MINIMUM.	Box Vents Provided	SOFFIT VENT REQUIRED (SQ. INCHES) (NFVA / 2)	SOFFIT LENGTH REQUIRED, MINIMUM.	Soffit Length Provided
ZONE	(30.11.)	(50. 11101125)	, ,	IVIIIVIIVIOIVI.		(**************************************		
ZONE	2047	983	786	5.5	8.0	393	78.6	106
		,	, , ,		8.0 10.0	, , ,	78.6 98.0	106 136
А	2047	983	786	5.5		393		

UPDATED		12/22/2023			
Rainfall Inte	ensity:	3.10	inches / hr	/ sf	
Reference I	ocation:	Indianapolis			
	=	0.2583	cub ft / hr /	' sf	
	=	1.9323	gph / sqft		
	=	0.0322	gpm / sqft		
Actual Roo	f Area	1000			
ROOF PITCH	H FACTOR:	1.00			
Calculated	Roof Area	1000			
Roof Area F	low Rate	32.21 gpm to gutte		er.	
Notes					
Roof Pitch I	actors.	Gutter Sizing	1/4" / foot	Downspor	ut Sizing
12:12+	1.3	4" dia.	39	2 1/2" x 3"	92
9:12 - 11:12	1.2	5" dia.	74	3 1/2" x 4"	192
6:12 - 8:12	1.1	6" dia.	110	4" x 5"	360
4:12 - 5:12	1.05	3" x 5"	157	5 x 6"	563
Flat - 3:12	1.0	4 1/2" x 6"	348		
-		IBC 1106.6		IBC 1106.3	

SLOPE

Scale: 1/8" = 1' - 0"

					ENEDAL NOTES DOOF DLAN
ULATIONS				G	ENERAL NOTES - ROOF PLAN
				1.	DETAILED FLOOR AND ROOF TRUSS FRAMING DIAGRAMS ARE TO BE FURNISHED BY A STRUCTURAL ENGINEER LICENSED IN THE STATE
	inches / hr /	' sf			WHERE THE PROJECT IS TO BE LOCATED.
				2.	THE TRUSS MANUFACTURER SHALL PROVIDE ENGINEERED PERMANENT ROOF TRUSS BRACING AS REQUIRED BY THE CODE.
	cub ft / hr /	sf		3.	LOCATE HIGH-POINT OF GUTTER AT MID-SPAN IN BETWEEN DOWNSPOUTS UNLESS INDICATED OTHERWISE ON THE ROOF PLAN.
	gph / sqft			4.	DOWNSPOUTS TO BE PROVIDED WITH EXTENSIONS TO ENSURE ALL WATER DISCHARGES NO LESS THAN 6' FROM BUILDING FOUNDATION
	gpm / sqft				OR DIRECTLY INTO STORM SYSTEM
				5.	THE ENTIRE BUILDING ENVELOPE INCLUDING ROOF, WALLS, & FLOORS TO BE DRIED IN PRIOR TO THE STORAGE AND INSTALLATION OF INTERIOR FINISH MATERIALS. IN ADDITION, THE OWNER'S REPRESENTATIVE IS RESPONSIBLE FOR VERIFYING THAT THERE HAS
					BEEN NO EVIDENCE OF WATER PENETRATING THE BUILDING
	gpm to gutte	er.			ENVELOPE OR WATER LEAK FROM MECHANICAL AND/OR FIRE SPRINKLER SYSTEMS PRIOR TO ENCLOSING THE WALL, CEILING OR ROOF CAVITIES.
				6.	ARROWS ON THE ROOF PLAN INDICATE WATER DRAINAGE DIRECTION.
				7.	FRAMING SUB-CONTRACTOR, PANEL MANUFACTURER, ROOFING
5	1/4" / foot	Downspou	t Sizing		SUPPLIERS, ROOF TRUSS MANUFACTURERS AND INSTALLERS SHALL REVIEW ALL ROOFING DETAILS AND ADVISE ARCHITECT ON ANY
	39	2 1/2" x 3"	92		RECOMMENDED CHANGES. UNLESS NOTED OTHERWISE, ROOFING SUPPLIERS, MANUFACTURERS AND INSTALLERS WILL BE ASSUMED TO HAVE REVIEWED AND APPROVED THE DETAILS SHOWN.
		2 1/2" v		8.	PRIME ALL METAL TO BE IN CONTACT WITH ROOFING MATERIALS.

					1	TELL TELEPHONE
rea	1000					BEEN NO EVIDENCE OF WATER PENETRATING THE BUILDING
te	32.21	gpm to gutte	r.		1	ENVELOPE OR WATER LEAK FROM MECHANICAL AND/OR FIRE SPRINKLER SYSTEMS PRIOR TO ENCLOSING THE WALL, CEILING OR
te	32.21	Sh to Secto				ROOF CAVITIES.
					6.	ARROWS ON THE ROOF PLAN INDICATE WATER DRAINAGE DIRECTION.
					7.	FRAMING SUB-CONTRACTOR, PANEL MANUFACTURER, ROOFING
					4	SUPPLIERS, ROOF TRUSS MANUFACTURERS AND INSTALLERS SHALL
	Gutter Sizing 1/4" / foot		Downspout Sizing			REVIEW ALL ROOFING DETAILS AND ADVISE ARCHITECT ON ANY
			2 1/2" x		1	RECOMMENDED CHANGES. UNLESS NOTED OTHERWISE, ROOFING
	المالية	20	,	00		SUPPLIERS, MANUFACTURERS AND INSTALLERS WILL BE ASSUMED TO
	4" dia.	39	3"	92		HAVE REVIEWED AND APPROVED THE DETAILS SHOWN.
			3 1/2" x		8.	PRIME ALL METAL TO BE IN CONTACT WITH ROOFING MATERIALS.
	5" dia.	74	4"	192	9.	"DS" INDICATES DOWN SPOUT. "RV" INDICATES RADON VENT.
	o uia.	74	4	192	10.	PROVIDE FLASHING PER DETAILS AT ALL CONDUIT AND HVAC LINES
						PENETRATING THE ROOF.
	6" dia.	110	4" x 5"	360	11.	CONTRACTOR AND ALL SUB-TRADES SHALL BE AWARE AND EXERCISE
	au =u		- 611		1	THE NECESSARY CARE TO PREVENT DAMAGE TO OR PUNCTURE OF
	3" x 5"	157	5 x 6"	563		THE ROOF. THIS SHALL INCLUDE ALL SHARP MATERIALS, TOOLS,
	/ . !! !!				1	MATERIAL SCRAPS OR MATERIALS HAVING A DELETERIOUS AFFECT

- HALL BE AWARE AND EXERCISE AMAGE TO OR PUNCTURE OF HARP MATERIALS, TOOLS, MATERIAL SCRAPS OR MATERIALS HAVING A DELETERIOUS AFFECT ON THE ROOFING MATERIAL.
- 12. PROVIDE SOFFIT DRAFTSTOPPING AT 20' MAX. INTERVALS. 10. SEPARATE DISSIMILAR METALS AS THEY OCCUR PER MANUFACTURER'S RECOMMENDATIONS. REVIEW MATERIALS AND METHODS WITH ARCHITECT.
- 16. THE ROOF ASSEMBLY IS CONSIDERED A COMPLETE ROOF ASSEMBLY ARCHITECTS DRAWINGS DO NOT INCLUDE ALL ACCESSORIES, FLASHING, TRANSITIONS, AND INSTALLATION DETAILS AS REQUIRED BY MANUFACTURER. OMISSIONS OF ANY ACCESSORY FROM THE ROOF PLAN SHALL NOT RELIEVE THE G.C. OR SUB-CONTRACTOR FROM PROVIDING A COMPLETE SYSTEM. 17. PROVIDE "ICE & WATER SHIELD" AROUND ALL PENETRATIONS.
- VALLEYS, AND ALONG EAVES. EXTEND 24" FROM FACE OF EXT. WALL 18. PROVIDE A 24X36 MIN. OPENING TO ALL ROOF CAVITIES TO CONNECT TO THE MAIN VOLUME OF SPACE FOR VENTING AND ACCESS. RIDGE VENTS MAY BE USED AT GABLES ONLY.


OOR AND ROOF TRUSS FRAMING DIAGRAMS ARE TO BE

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INDIANAPOLIS, IN 46202 BILLY@R3BARCHITECTURE.COM

574-850-2270



PROJECT TITLE

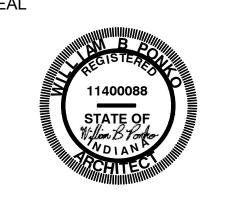I **GARDENS** H KENSINGTON , IN 46055

(NOT ALL RATING LINE TYPES ARE NECESSARILY USED IN THIS PROJECT) 2 HR RATED "FIRE WALL" CONTINUOUS WITHOUT INTERRUPTION. 1 HR RATED "FIRE BARRIER". WALL EXTENDS FROM RATED ASSEMBLY TO DRAFT STOPPING - ALIGN WITH DEMISING WALLS. LIMIT CAVITY TO

3000 SQ. FT OR (2) UNITS (WHAT EVER IS LESS). ALIGN WITH 1 SIDE OF THE CORRIDOR. IBC 718.3.1 -DRAFTSTOPPING, WHERE SHOWN, IS INTENDED TO STOP THE PASSAGE OF AIR. ALIGN WITH FIRE RATED WALLS PERMIT SET- STATE CDR ("FIRE BARRIERS") BELOW. CITY ARC COMMENTS

REVISIONS

MARK DESCRIPTION

ROOF PLAN KEYED NOTES

- 1.1. OFFSET PIPE IN ROOF CAVITY TO AVOID FIRE TREATED DECKING. ASPHALTIC ROOF SHINGLES ON SYNTHETIC UNDERLAYMENT, 30 YEAR WARRANTY, ENERGY STAR, ANTI-FUNGAL RATED. BASIS OF DESIGN -OWENS CORNING, OAKRIDGE. TYPICAL SLOPE: 6:12.
- 3. DOWNSPOUTS TO BE 3" WIDE X 3" DEEP. 4. DRAFTSTOPPING IN CEILING-ROOF CAVITY BELOW. ACCEPTABLE
- DRAFTSTOPPING MATERIALS INCLUDE: 4.1. $\frac{1}{2}$ " GYPSUM BOARD
- 4.2. $\frac{3}{8}$ " WOOD STRUCTURAL PANELS 4.3. $\frac{3}{8}$ " PARTICLE BOARD
- 4.4. 1" NOMINAL LUMBER
- 5. TYPICAL GUTTER. REFER TO ELEVATIONS FOR DOWNSPOUT LOCATIONS. GUTTERS TO BE 6" WIDE X 6" DEEP. SLOPE TO BE 1/16" PER 1'-0". SEE 12/A520.
- 6. ROOF VENT, 144 SQ. INCHES FREE AREA, MIN. TYPICAL. SEE VENTILATION CHART. 7. LINE OF WALLS BELOW.
- 8. ATTIC ACCESS HATCH IN CEILING AT TOP FLOOR. SIZE 20"X40" MINIMUM, COORDINATE EXACT LOCATIONS WITH FRAMING BELOW. 9. SOFFIT VENTS, 5 SQ. INCHES / FOOT MIN..
- 10. DOOR THROUGH DRAFTSTOPPING COMPARTMENTS. SEE SHEET 11. EXTEND DRAFT STOPPING TO EDGE OF OVERHANG IN THE ROOF


ROOF PLANS ATTIC SPACE. ALIGN WITH UNIT DEMISING WALL BELOW.

DRAWN BY: BP

CHECKED BY: BP

SHEET TITLE

SHEET NUMBER

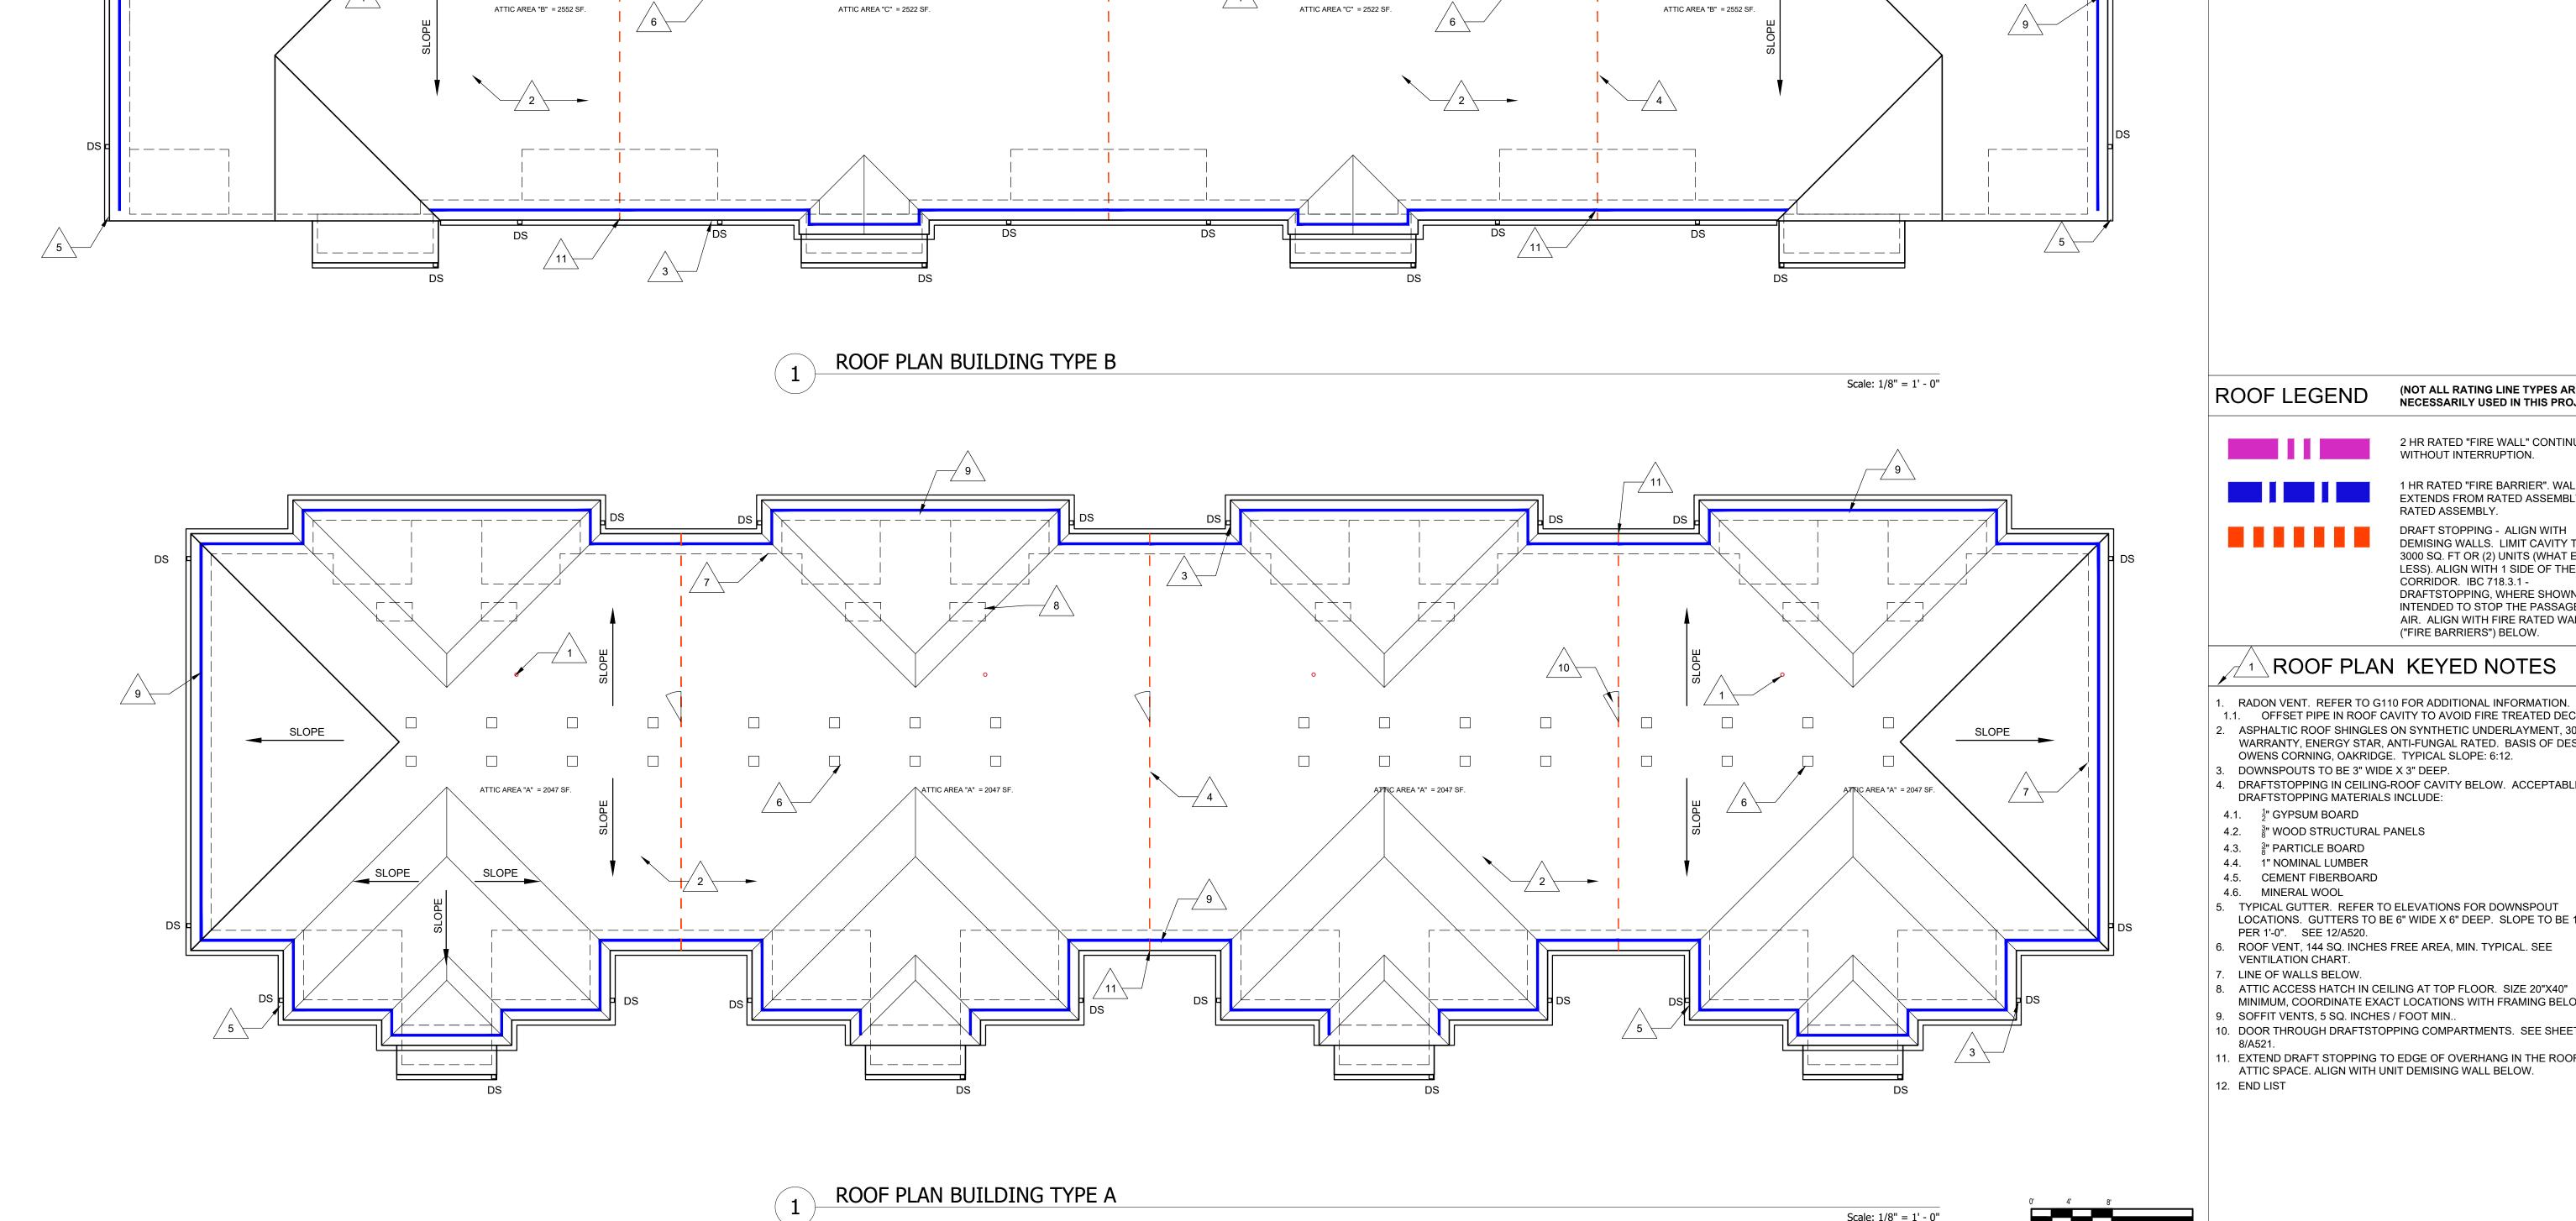

9

SLOPE













PROJECT TITLE

KENNSINGTON GARDENS
EAST SIDE OF NORTH KENSINGTON
MCCORDSVILLE, IN 46055

ISSUE) EOD:	IDATE
_		
	T SET- STATE CDR	2-23-2024
CITY AI	RC COMMENTS	3-1-2024
REVIS	SIONS	
MARK	DESCRIPTION	DATE

DATE: 3-1-2024

DRAWN BY: BP

CHECKED BY: BP

SHEET TITLE
RENDERINGS
TYPE A

SHEET NUMBER

A201










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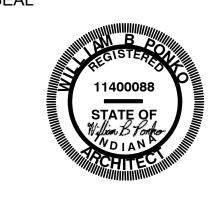
PROJECT TITLE

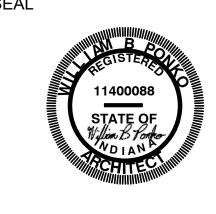ISSUEE	FOR:	DATE
PERMI	T SET- STATE CDR	2-23-2024
CITY AI	RC COMMENTS	3-1-2024
REVI	SIONS	
	SIONS DESCRIPTION	DATE
	_	DATE

DRAWN BY: BP CHECKED BY: BP

SHEET TITLE
RENDERINGS
TYPE B





PROJECT TITLE

CHECKED BY: BP

SHEET TITLE RENDERINGS CLUBHOUSE












GENERAL ELEVATION NOTES




INDIANAPOLIS, IN 46202





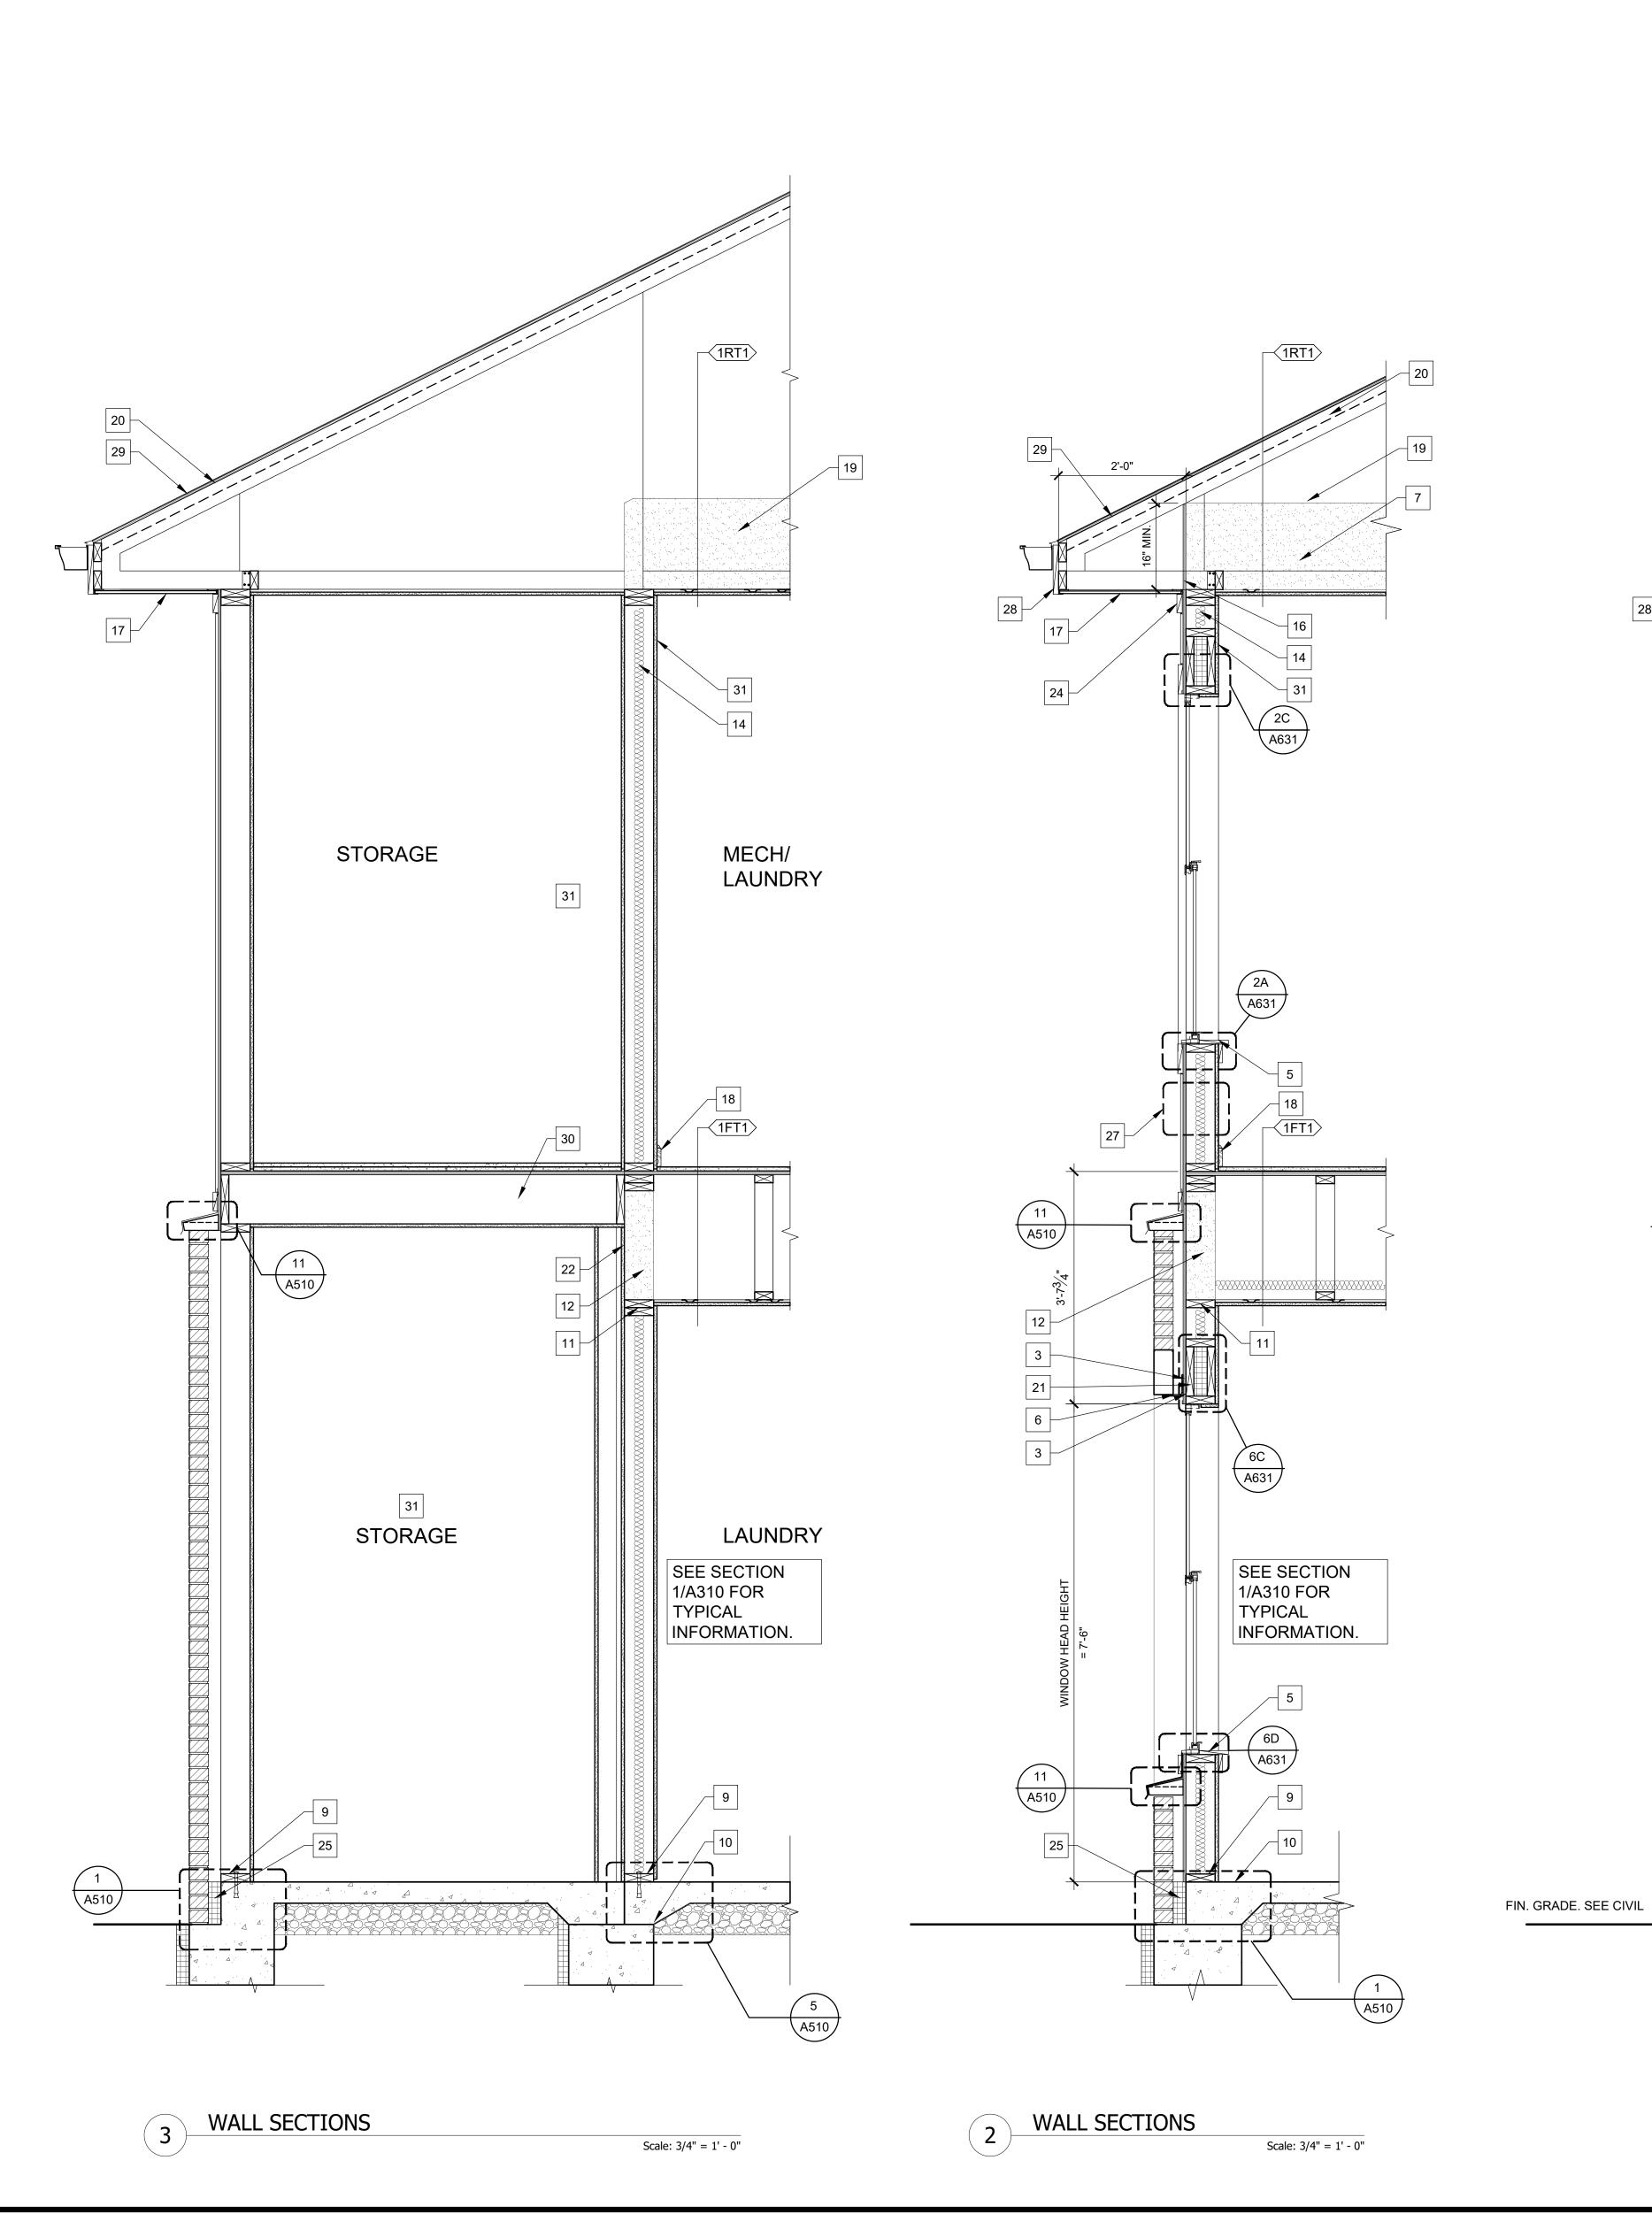

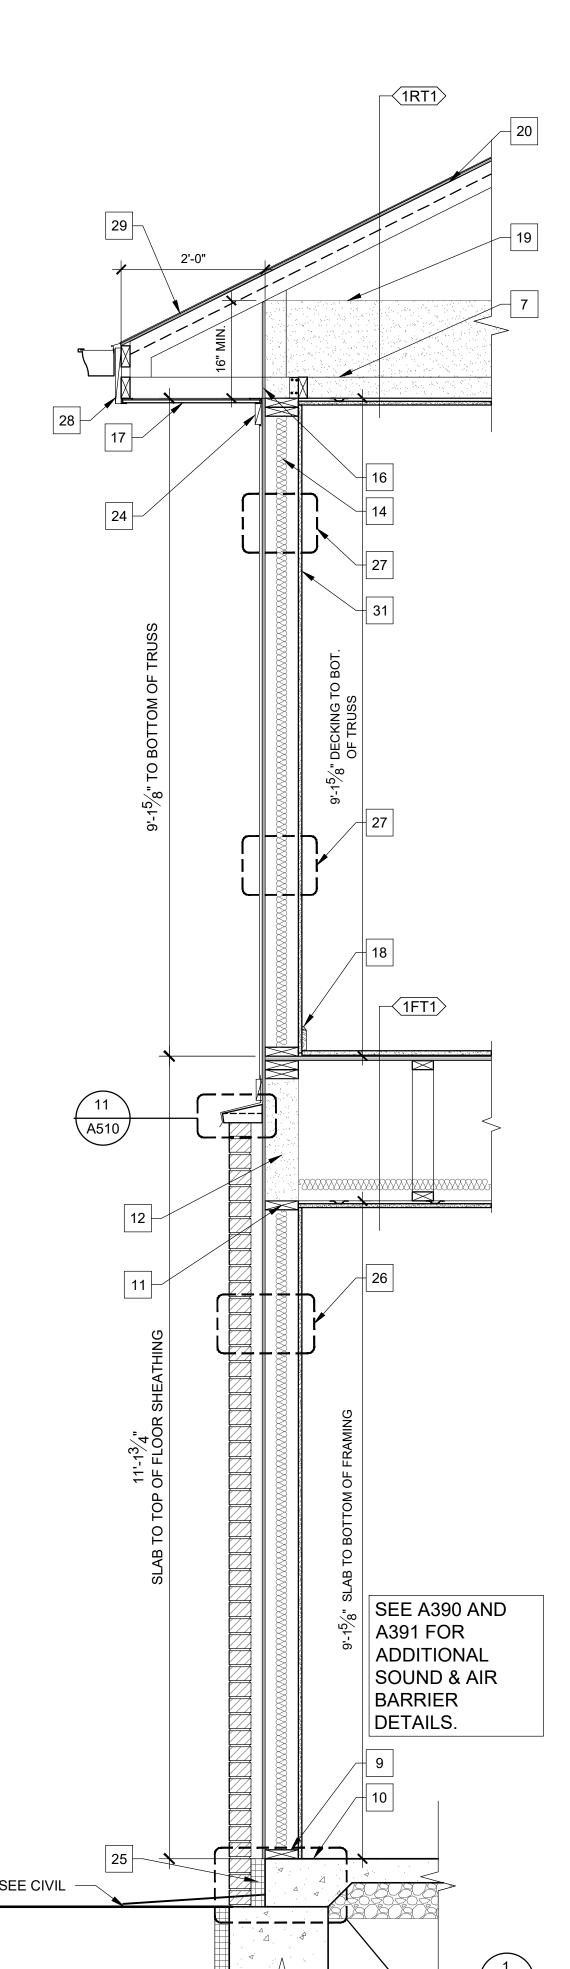

GENERAL SECTION NOTES

NOTES SHOWN AS TYPICAL APPLY TO ALL SIMILAR DETAILS, BUT MAY NOT BE SHOWN AT ALL LOCATIONS.

ANY AND ALL PENETRATIONS SHALL RECEIVE CAULKING TO SEAL AN' TYPE OF ENERGY/ AIR LOSS. SEE AIR SEALING DETAILS.

SECTIONS INDICATED AS TYPICAL MAY NOT BE INDICATED ON EVERY PLAN SHEET. IT IS THE CONTRACTORS RESPONSIBILITY TO USE TYPICAL SECTIONS WHERE REQUIRED.

WEATHER RESISTANT BARRIER, (WRB) REQUIRED AT ALL EXTERIOR WALLS TO FORM AN AIR TIGHT ENVELOPE AROUND EACH UNIT. OVERLAP AND TAPE ALL SEAMS IN ACCORDANCE WITH MANUF.

USE WATER RESISTANT GYP. BOARD ON ALL "WET" WALLS (ADJACENT TO AND BEHIND ALL SINKS, SHOWERS, AND LAUNDRY EQUIPMENT) AND INTERIOR OF EXTERIOR STORAGE CLOSETS. USE MOISTURE RESISTANT GYP. BOARD IN ALL BATHROOMS, KITCHENS, MECHANICAL, AND LAUNDRY ROOMS.

FIRE BLOCKING IS REQUIRED PER CODE AS FOLLOWS WALL CAVITIES - PROVIDE MINERAL WOOL OR CONTINUOUS 2X FRAMING TO LIMIT ANY CAVITY TO LESS THAN 10' ANY DIRECTION WALL-TO-CEILING - PROVIDE .018" METAL COIL SET BELOW WOOD FLOOR TRUSSES TO LIMIT AIR PASSAGE. PACK FULL DEPTH OF

DOUBLE HEADER WITH MINERAL WOOL. FLOOR-TO-WALLS - AT 1 HOUR PARTITION MAINTAIN CONTINUOUS 3/4" PLYWOOD ACROSS JOINT. AT 2 HOUR PARTITION PROVIDE MINERAL WOOL OR CONTINUOUS 2X FRAMING.

FLOOR TO CEILING ASSEMBLY - PROVIDE CONTINUOUS 7/16" (MIN. SHEATHING ACROSS TRUSSES. ALIGN ALL WINDOW HEAD HEIGHTS WITH HEAD HEIGHT OF THE

EXTERIOR DOORS. SEE ELEVATIONS . ALL TRIM TO BE 5/4" WHEN ABUTTING TO SIDING. 3/4" MAY BE USED FOR WRAPPING CONDITIONS.

MANUFACTURERS RECOMMENDATION) ABOVE ROOF, FLOOR, GRADE, OR OTHER HORIZONTAL SURFACE. 1. PROVIDE "VENT" STYLE WEEPS AT TOP AND BOTTOM OF BRICK WALI

10. STOP ALL TRIM AND EXTERIOR SIDING 1" MIN (OR PER

TO FULLY VENT CAVITY. 2. SEE A390 & A391 AIR SEALING DETAILS FOR ADDITIONAL WALL REQUIREMENTS.

3. IBC 718.3.1 - DRAFTSTOPPING, WHERE SHOWN, IS INTENDED TO STOP THE PASSAGE OF AIR. ACCEPTABLE DRAFTSTOPPING MATERIALS

INCLUDE: 13.1. $\frac{1}{2}$ " GYPSUM BOARD

13.2. $\frac{3}{8}$ WOOD STRUCTURAL PANELS

13.3. $\frac{3}{8}$ " PARTICLE BOARD 13.4. 1" NOMINAL LUMBER

13.5. CEMENT FIBERBOARD 13.6. MINERAL WOOL

14. ALL STEEL COLUMNS AND BEAMS TO RECEIVE INTUMESCENT PAINT EQUIVALENT TO 1 HOUR RATING, UNLESS SPECIFICALLY NOTED OTHERWISE.

15. SEE A500 AND A600 SERIES FOR INSTALLATION NOTES AND SEQUENC INSTRUCTIONS FOR FLASHING AND WEATHER BARRIER. REFER TO THE SPECIFICATIONS AND MANUFACTURER'S INSTRUCTIONS FOR ADDITIONAL INFORMATION. 16. STC RATINGS AND TESTING INFORMATION LISTED FOR HORIZONTAL

16.1. MAXXON - FIRE AND SOUND MANUAL, VERSION 6.21, "EVALUATION REPORT R8477".

SECTION KEYNOTES

ASSEMBLIES PROVIDED BY:

SET ENDURA ADAPTIVE ADA COMPLIANT DOOR THRESHOLD IN BED O SEALANT ON METAL SILL FLASHING THAT EXTENDS OVER TOP OF BREEZEWAY JOISTS. TRANSITION FROM DECKING TO DOOR THRESHOLD < 1/4". TYPICAL.

GUARDRAILS, TYPICAL. SEE ELEVATIONS. SEE DETAIL 21/A316 FOR DECORATIVE INFILL PANELS.

WEATHER BARRIER AT ALL WINDOWS AND DOORS TO BE INSTALLED PER MANUFACTURERS DIRECTIONS, SEE A600 SERIES. TYPICAL.

6X6 COMPOSITE COLUMN, REAL POST, BY WOODTONE. PAINTED WOOD SILL AND APRON FRONT. TYPICAL. STEEL LINTEL, SEE STRUCTURAL. PAINT TO MATCH BRICK.

PRE-ENGINEERED ROOF TRUSSES. PROFILE TRUSS. MAINTAIN BEARING ON EXTERIOR LOAD BEARING WALLS, PER STRUCTURAL TRUSS MANUFACTURER IS RESPONSIBLE FOR FINAL TRUSS CONFIGURATION PER SLOPES IDENTIFIED ON ELEVATIONS. INCLUDE

ENERGY HEAL AS SHOWN. SEE A454 BALCONY FRAMING DETAILS FOR ADDITIONAL INFORMATION. FINISH FACE OF STRUCTURE WITH TRIM. MATCH

SET SILL PLATES IN DOUBLE ROW OF CONTINUOUS BITUMOUS

10. REFER TO STRUCTURAL FOR FOUNDATION INFORMATION AND ANCHOR REQUIREMENTS.

11. ALIGN BLOCKING AT CEILING PLANE. 12. R-21 2# CLOSED CELL SPRAY FOAM.

13. EXTERIOR WALL SHOWN BALLOON FRAMED, FRAMER CAN USE LADDER TRUSSES THAT ARE FULL WALL WIDTH. KRAFT FACED BATT INSULATION ACCEPTABLE AS AN ALTERNATE.

WHERE TRUSSES ARE PARALLEL TO EXTERIOR WALL OR EXTERIOR WALL IS FULL HEIGHT "BALLOON FRAMED". 15. PROVIDE BLOCKING, SHEATHING, OR OTHER MATERIAL BETWEEN

TRUSSES TO STOP INSULATION. 16. EXTEND WRB TO TOP OF WALL. 17. PERFORATED SOFFIT. SEE ROOF PLAN VENTING DIAGRAMS FOR MINIMUM AIR FLOW REQUIREMENTS.

18. BASE BOARD TYPICAL. SEE SPECIFICATIONS. 19. BLOW-IN INSULATION. EXTEND OUT TO FACE OF EXT. WALL.

20. MAINTAIN AIR GAP ALONG BOTTOM OF ROOF SHEATHING. INCLUDE

BAFFLES ALONG EVE. 21. INSULATED 2 X HEADERS. SEE STRUCTURAL FOR SIZE AND QUANTITY. TYPICAL ALL LOCATIONS.

22. EXTEND WRB FULL HEIGHT OF WALL PRIOR TO FRAMING BALCONIES. 23. R-10 INSULATION DOWN FACE OF FOUNDATION 24" MINIMUM. 24. 4 x 5/4 FIBER CEMENT TRIM - ALIGN WITH TRIM UNDER MAIN ROOF

SOFFIT 5/4 x 4 TRIM.

25. FILL CAVITY BETWEEN FOUNDATION AND BACK OF MASONRY WITH RIGID INSULATION. 26. TYPICAL MASONRY EXTERIOR WALL:

 2X6" WOOD STUD R-21 BATT INSULATION • ½" OSB SHEATHING

• § GYPSUM BOARD

 AIR AND WATER RESISTANT BARRIER SYSTEM. MASONRY SYSTEM.

27. TYPICAL SIDING EXTERIOR WALL: GYPSUM BOARD

 2X6" WOOD STUD R21 BATT INSULATION

 OSB SHEATHING AIR AND WATER RESISTANT BARRIER SYSTEM. FIBER CEMENT PANEL & SIDING, SEE ELEVATIONS.

28. TRIM, SEE ELEVATIONS FOR SIZING. 29. PROVIDE ICE AND WATER SHIELD FROM EAVE TO A POINT 24" FROM

INSIDE FACE OF WALL CONSTRUCTION - TYP. 30. BALCONY STORAGE ROOM FLOORS: 1-HR RATED FLOOR/ CLG ASSEMBLY BASED PER IBC 722.6.2:

MOISTURE RESISTANT GYPSUM BOARD (STORAGE ROOMS)

 2x10 JOISTS ³" PLYWOOD DECKING X2 LAYERS.

VCT FLOORING.

31. ALL WALLS THIS ROOM MOISTURE RESISTANT GYPSUM BOARD.

RATED ASSEMBLIES NOTES

THE FOLLOWING OUTLINES BASIC RATED WALL ASSEMBLIES FOR USE BY THE CONSTRUCTION TEAM. THIS IS FOR INFORMATION PURPOSES ONLY AND DOES NOT REPLACE WALLS SECTIONS, PLANS, OR NOTES ELSEWHERE IN THE SET. FOR FURTHER QUESTIONS CONTACT THE ARCHITECT.

1. FIRE PARTITIONS - SEE IBC SECTION 708:

1.1. 708.1 - TYPICAL FOR SEPARATING UNITS, AND CORRIDOR WALLS. 1.2. 708.4 - WALLS TYPICALLY EXTEND BETWEEN RATED ASSEMBLIES,

DRAWN BY: BP SUCH AS FLOOR SYSTEM TO CEILING SYSTEM. REFER TO UL ASSEMBLIES ON G040 AND FIRE STOPPING DETAILS ON CHECKED BY: BP

G041 AND G042. PROVIDE FIRE SEALANT AROUND ALL PENETRATIONS THROUGH RATED ASSEMBLIES.

4. FILL ALL VOIDS, OPENINGS, AND GAPS AT PENETRATIONS IN ASSEMBLIES WITH APPROVED FIRE SAFING/FIRESTOP SYSTEMS. SEE WALL SECTIONS G041. OPENINGS TOO LARGE FOR FIRE SAFING/FIRESTOP SHALL BE PATCHED WITH FIRE RATED GWB

HEADERS AND JAMBS AT OPENINGS IN WALLS MUST BE PROTECTED BY THE SAME MEANS OF AND FIRE RATING AS THE WALL. 6. ALL DUCTWORK PENETRATIONS IN RATED WALLS AND CEILINGS

SHALL HAVE FIRE DAMPERS. (COORDINATE WITH MECHANICAL) REFER TO ALL FLOOR PLAN SHEETS FOR TYPICAL VERTICAL FIRE RATED ASSEMBLY TYPES AND LOCATIONS.

8. REFER TO SECTIONS FOR TYPICAL HORIZONTAL FIRE RATED ASSEMBLY TYPES AND LOCATIONS. 9. FIRE RATED WALL ASSEMBLIES MUST BE SEALED TO UNDERSIDE C

FLOOR DECK ABOVE AND SUBFLOOR BELOW. 10. END LIST.

Scale: 3/4" = 1' - 0"

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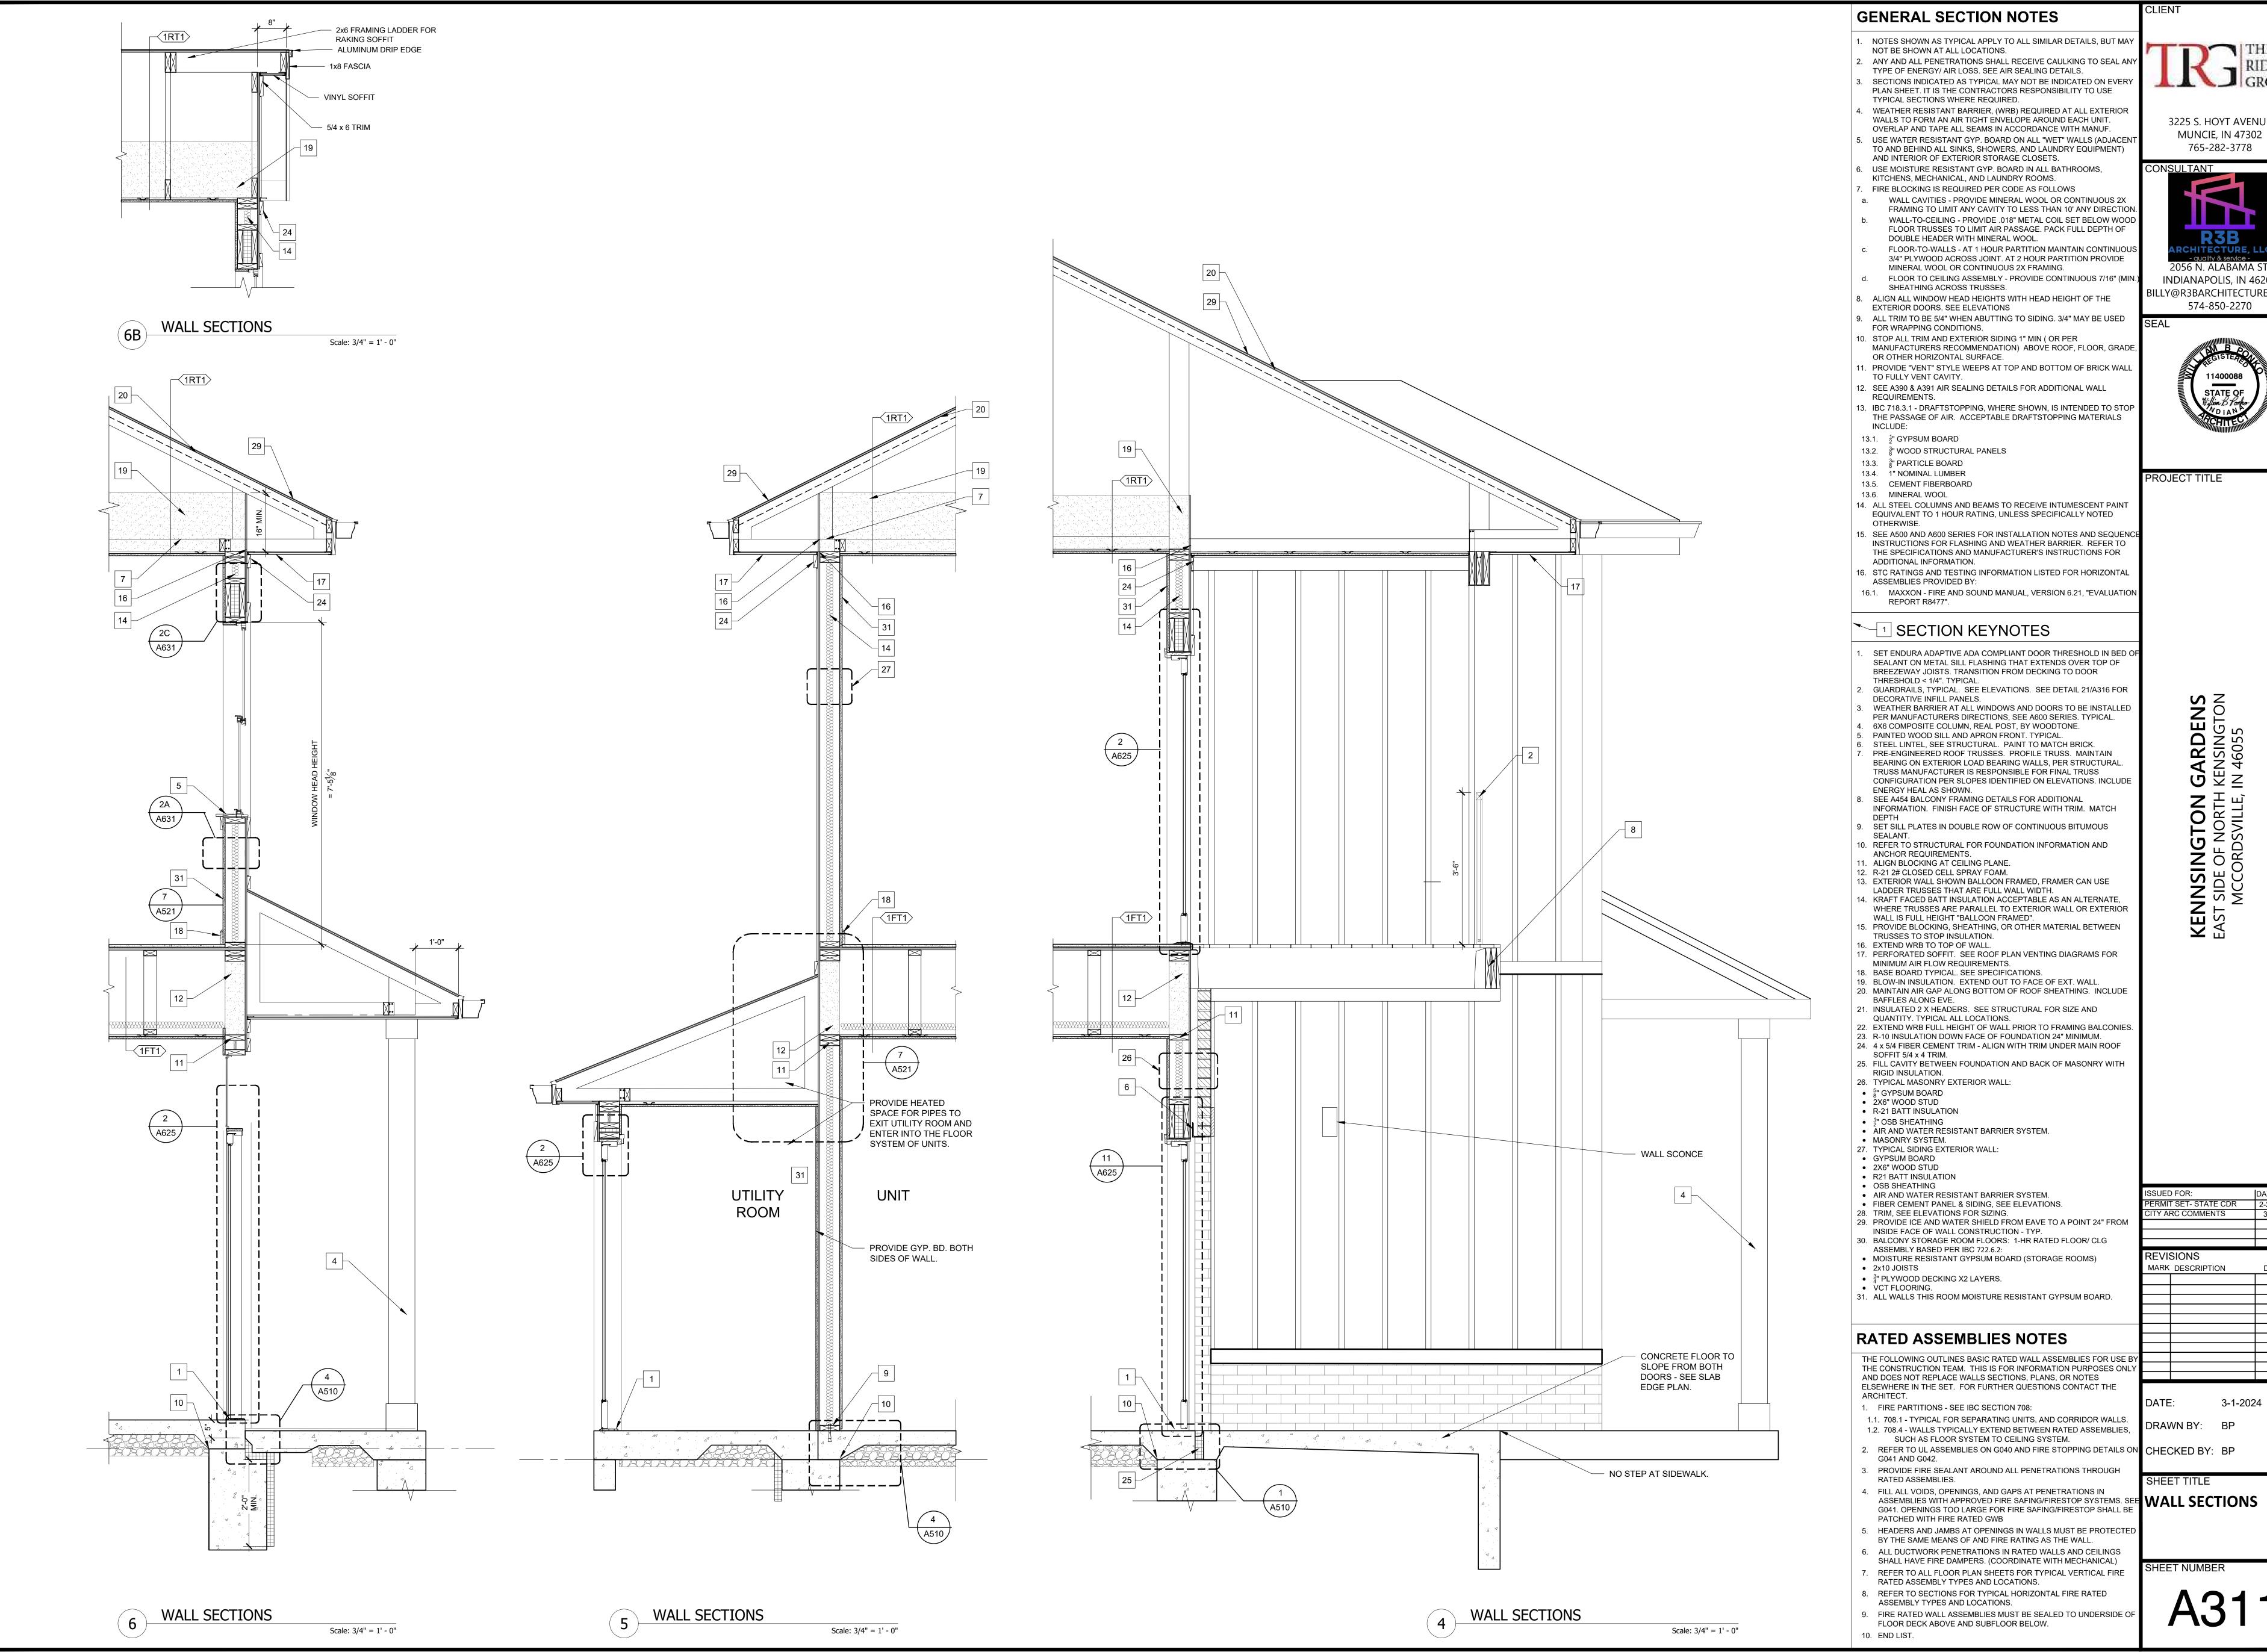
2056 N. ALABAMA ST INDIANAPOLIS, IN 46202 BILLY@R3BARCHITECTURE.COM 574-850-2270



PROJECT TITLE

ISSUED FOR: PERMIT SET- STATE CDR CITY ARC COMMENTS REVISIONS MARK DESCRIPTION


SHEET TITLE



3225 S. HOYT AVENUE



INDIANAPOLIS, IN 46202 BILLY@R3BARCHITECTURE.COM

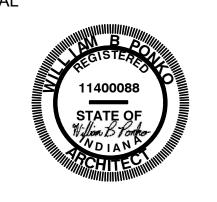

WALL SECTIONS

Scale: 3/4" = 1' - 0"

Scale: 3/4" = 1' - 0"

GENERAL SECTION NOTES

NOTES SHOWN AS TYPICAL APPLY TO ALL SIMILAR DETAILS, BUT MAY NOT BE SHOWN AT ALL LOCATIONS. ANY AND ALL PENETRATIONS SHALL RECEIVE CAULKING TO SEAL ANY

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PLAN SHEET. IT IS THE CONTRACTORS RESPONSIBILITY TO USE TYPICAL SECTIONS WHERE REQUIRED.

WEATHER RESISTANT BARRIER, (WRB) REQUIRED AT ALL EXTERIOR WALLS TO FORM AN AIR TIGHT ENVELOPE AROUND EACH UNIT. OVERLAP AND TAPE ALL SEAMS IN ACCORDANCE WITH MANUF. USE WATER RESISTANT GYP. BOARD ON ALL "WET" WALLS (ADJACENT

TO AND BEHIND ALL SINKS, SHOWERS, AND LAUNDRY EQUIPMENT) AND INTERIOR OF EXTERIOR STORAGE CLOSETS. USE MOISTURE RESISTANT GYP. BOARD IN ALL BATHROOMS, KITCHENS, MECHANICAL, AND LAUNDRY ROOMS.

DOUBLE HEADER WITH MINERAL WOOL.

FIRE BLOCKING IS REQUIRED PER CODE AS FOLLOWS WALL CAVITIES - PROVIDE MINERAL WOOL OR CONTINUOUS 2X FRAMING TO LIMIT ANY CAVITY TO LESS THAN 10' ANY DIRECTION. WALL-TO-CEILING - PROVIDE .018" METAL COIL SET BELOW WOOD FLOOR TRUSSES TO LIMIT AIR PASSAGE. PACK FULL DEPTH OF

FLOOR-TO-WALLS - AT 1 HOUR PARTITION MAINTAIN CONTINUOUS 3/4" PLYWOOD ACROSS JOINT. AT 2 HOUR PARTITION PROVIDE MINERAL WOOL OR CONTINUOUS 2X FRAMING.

 FLOOR TO CEILING ASSEMBLY - PROVIDE CONTINUOUS 7/16" (MIN.) SHEATHING ACROSS TRUSSES. ALIGN ALL WINDOW HEAD HEIGHTS WITH HEAD HEIGHT OF THE

EXTERIOR DOORS. SEE ELEVATIONS ALL TRIM TO BE 5/4" WHEN ABUTTING TO SIDING. 3/4" MAY BE USED FOR WRAPPING CONDITIONS. 10. STOP ALL TRIM AND EXTERIOR SIDING 1" MIN (OR PER

MANUFACTURERS RECOMMENDATION) ABOVE ROOF, FLOOR, GRADE, OR OTHER HORIZONTAL SURFACE. I. PROVIDE "VENT" STYLE WEEPS AT TOP AND BOTTOM OF BRICK WALL TO FULLY VENT CAVITY.

. SEE A390 & A391 AIR SEALING DETAILS FOR ADDITIONAL WALL REQUIREMENTS.

. IBC 718.3.1 - DRAFTSTOPPING, WHERE SHOWN, IS INTENDED TO STOP THE PASSAGE OF AIR. ACCEPTABLE DRAFTSTOPPING MATERIALS INCLUDE:

13.1. $\frac{1}{2}$ " GYPSUM BOARD

13.2. $\frac{3}{8}$ WOOD STRUCTURAL PANELS

13.3. ³/₈" PARTICLE BOARD 13.4. 1" NOMINAL LUMBER

13.5. CEMENT FIBERBOARD 13.6. MINERAL WOOL

14. ALL STEEL COLUMNS AND BEAMS TO RECEIVE INTUMESCENT PAINT EQUIVALENT TO 1 HOUR RATING, UNLESS SPECIFICALLY NOTED OTHERWISE. SEE A500 AND A600 SERIES FOR INSTALLATION NOTES AND SEQUENCE

THE SPECIFICATIONS AND MANUFACTURER'S INSTRUCTIONS FOR ADDITIONAL INFORMATION. 16. STC RATINGS AND TESTING INFORMATION LISTED FOR HORIZONTAL ASSEMBLIES PROVIDED BY:

INSTRUCTIONS FOR FLASHING AND WEATHER BARRIER. REFER TO

16.1. MAXXON - FIRE AND SOUND MANUAL, VERSION 6.21, "EVALUATION REPORT R8477".

SECTION KEYNOTES

SET ENDURA ADAPTIVE ADA COMPLIANT DOOR THRESHOLD IN BED OF SEALANT ON METAL SILL FLASHING THAT EXTENDS OVER TOP OF BREEZEWAY JOISTS. TRANSITION FROM DECKING TO DOOR THRESHOLD < 1/4". TYPICAL.

GUARDRAILS, TYPICAL. SEE ELEVATIONS. SEE DETAIL 21/A316 FOR DECORATIVE INFILL PANELS.

WEATHER BARRIER AT ALL WINDOWS AND DOORS TO BE INSTALLED PER MANUFACTURERS DIRECTIONS, SEE A600 SERIES. TYPICAL. 6X6 COMPOSITE COLUMN, REAL POST, BY WOODTONE.

PAINTED WOOD SILL AND APRON FRONT. TYPICAL. STEEL LINTEL, SEE STRUCTURAL. PAINT TO MATCH BRICK. PRE-ENGINEERED ROOF TRUSSES. PROFILE TRUSS. MAINTAIN BEARING ON EXTERIOR LOAD BEARING WALLS, PER STRUCTURAL. TRUSS MANUFACTURER IS RESPONSIBLE FOR FINAL TRUSS

ENERGY HEAL AS SHOWN. SEE A454 BALCONY FRAMING DETAILS FOR ADDITIONAL INFORMATION. FINISH FACE OF STRUCTURE WITH TRIM. MATCH

SET SILL PLATES IN DOUBLE ROW OF CONTINUOUS BITUMOUS

10. REFER TO STRUCTURAL FOR FOUNDATION INFORMATION AND ANCHOR REQUIREMENTS.

11. ALIGN BLOCKING AT CEILING PLANE.

12. R-21 2# CLOSED CELL SPRAY FOAM. 13. EXTERIOR WALL SHOWN BALLOON FRAMED, FRAMER CAN USE LADDER TRUSSES THAT ARE FULL WALL WIDTH.

CONFIGURATION PER SLOPES IDENTIFIED ON ELEVATIONS. INCLUDE

WHERE TRUSSES ARE PARALLEL TO EXTERIOR WALL OR EXTERIOR WALL IS FULL HEIGHT "BALLOON FRAMED". . PROVIDE BLOCKING, SHEATHING, OR OTHER MATERIAL BETWEEN

14. KRAFT FACED BATT INSULATION ACCEPTABLE AS AN ALTERNATE,

TRUSSES TO STOP INSULATION. 16. EXTEND WRB TO TOP OF WALL. 17. PERFORATED SOFFIT. SEE ROOF PLAN VENTING DIAGRAMS FOR

MINIMUM AIR FLOW REQUIREMENTS. 18. BASE BOARD TYPICAL. SEE SPECIFICATIONS.

19. BLOW-IN INSULATION. EXTEND OUT TO FACE OF EXT. WALL. 20. MAINTAIN AIR GAP ALONG BOTTOM OF ROOF SHEATHING. INCLUDE BAFFLES ALONG EVE.

21. INSULATED 2 X HEADERS. SEE STRUCTURAL FOR SIZE AND QUANTITY. TYPICAL ALL LOCATIONS. 22. EXTEND WRB FULL HEIGHT OF WALL PRIOR TO FRAMING BALCONIES.

23. R-10 INSULATION DOWN FACE OF FOUNDATION 24" MINIMUM. 24. 4 x 5/4 FIBER CEMENT TRIM - ALIGN WITH TRIM UNDER MAIN ROOF SOFFIT 5/4 x 4 TRIM.

25. FILL CAVITY BETWEEN FOUNDATION AND BACK OF MASONRY WITH RIGID INSULATION. 26. TYPICAL MASONRY EXTERIOR WALL:

• §" GYPSUM BOARD 2X6" WOOD STUD R-21 BATT INSULATION

• ½" OSB SHEATHING AIR AND WATER RESISTANT BARRIER SYSTEM. MASONRY SYSTEM.

27. TYPICAL SIDING EXTERIOR WALL: GYPSUM BOARD 2X6" WOOD STUD R21 BATT INSULATION

 OSB SHEATHING AIR AND WATER RESISTANT BARRIER SYSTEM. FIBER CEMENT PANEL & SIDING, SEE ELEVATIONS. 28. TRIM, SEE ELEVATIONS FOR SIZING.

29. PROVIDE ICE AND WATER SHIELD FROM EAVE TO A POINT 24" FROM INSIDE FACE OF WALL CONSTRUCTION - TYP. 30. BALCONY STORAGE ROOM FLOORS: 1-HR RATED FLOOR/ CLG

ASSEMBLY BASED PER IBC 722.6.2: MOISTURE RESISTANT GYPSUM BOARD (STORAGE ROOMS) 2x10 JOISTS

• $\frac{3}{4}$ " PLYWOOD DECKING X2 LAYERS. VCT FLOORING.

31. ALL WALLS THIS ROOM MOISTURE RESISTANT GYPSUM BOARD.

RATED ASSEMBLIES NOTES

THE FOLLOWING OUTLINES BASIC RATED WALL ASSEMBLIES FOR USE BY THE CONSTRUCTION TEAM. THIS IS FOR INFORMATION PURPOSES ONLY AND DOES NOT REPLACE WALLS SECTIONS, PLANS, OR NOTES ELSEWHERE IN THE SET. FOR FURTHER QUESTIONS CONTACT THE ARCHITECT.

1. FIRE PARTITIONS - SEE IBC SECTION 708:

1.1. 708.1 - TYPICAL FOR SEPARATING UNITS, AND CORRIDOR WALLS. 1.2. 708.4 - WALLS TYPICALLY EXTEND BETWEEN RATED ASSEMBLIES, SUCH AS FLOOR SYSTEM TO CEILING SYSTEM. REFER TO UL ASSEMBLIES ON G040 AND FIRE STOPPING DETAILS ON ☐ CHECKED BY: BP G041 AND G042.

PROVIDE FIRE SEALANT AROUND ALL PENETRATIONS THROUGH RATED ASSEMBLIES. 4. FILL ALL VOIDS, OPENINGS, AND GAPS AT PENETRATIONS IN

ASSEMBLIES WITH APPROVED FIRE SAFING/FIRESTOP SYSTEMS. SEE WALL SECTIONS G041. OPENINGS TOO LARGE FOR FIRE SAFING/FIRESTOP SHALL BE PATCHED WITH FIRE RATED GWB HEADERS AND JAMBS AT OPENINGS IN WALLS MUST BE PROTECTED

BY THE SAME MEANS OF AND FIRE RATING AS THE WALL. 6. ALL DUCTWORK PENETRATIONS IN RATED WALLS AND CEILINGS SHALL HAVE FIRE DAMPERS. (COORDINATE WITH MECHANICAL) REFER TO ALL FLOOR PLAN SHEETS FOR TYPICAL VERTICAL FIRE

RATED ASSEMBLY TYPES AND LOCATIONS. 8. REFER TO SECTIONS FOR TYPICAL HORIZONTAL FIRE RATED ASSEMBLY TYPES AND LOCATIONS. 9. FIRE RATED WALL ASSEMBLIES MUST BE SEALED TO UNDERSIDE O


FLOOR DECK ABOVE AND SUBFLOOR BELOW. 10. END LIST.

Scale: 3/4" = 1' - 0"

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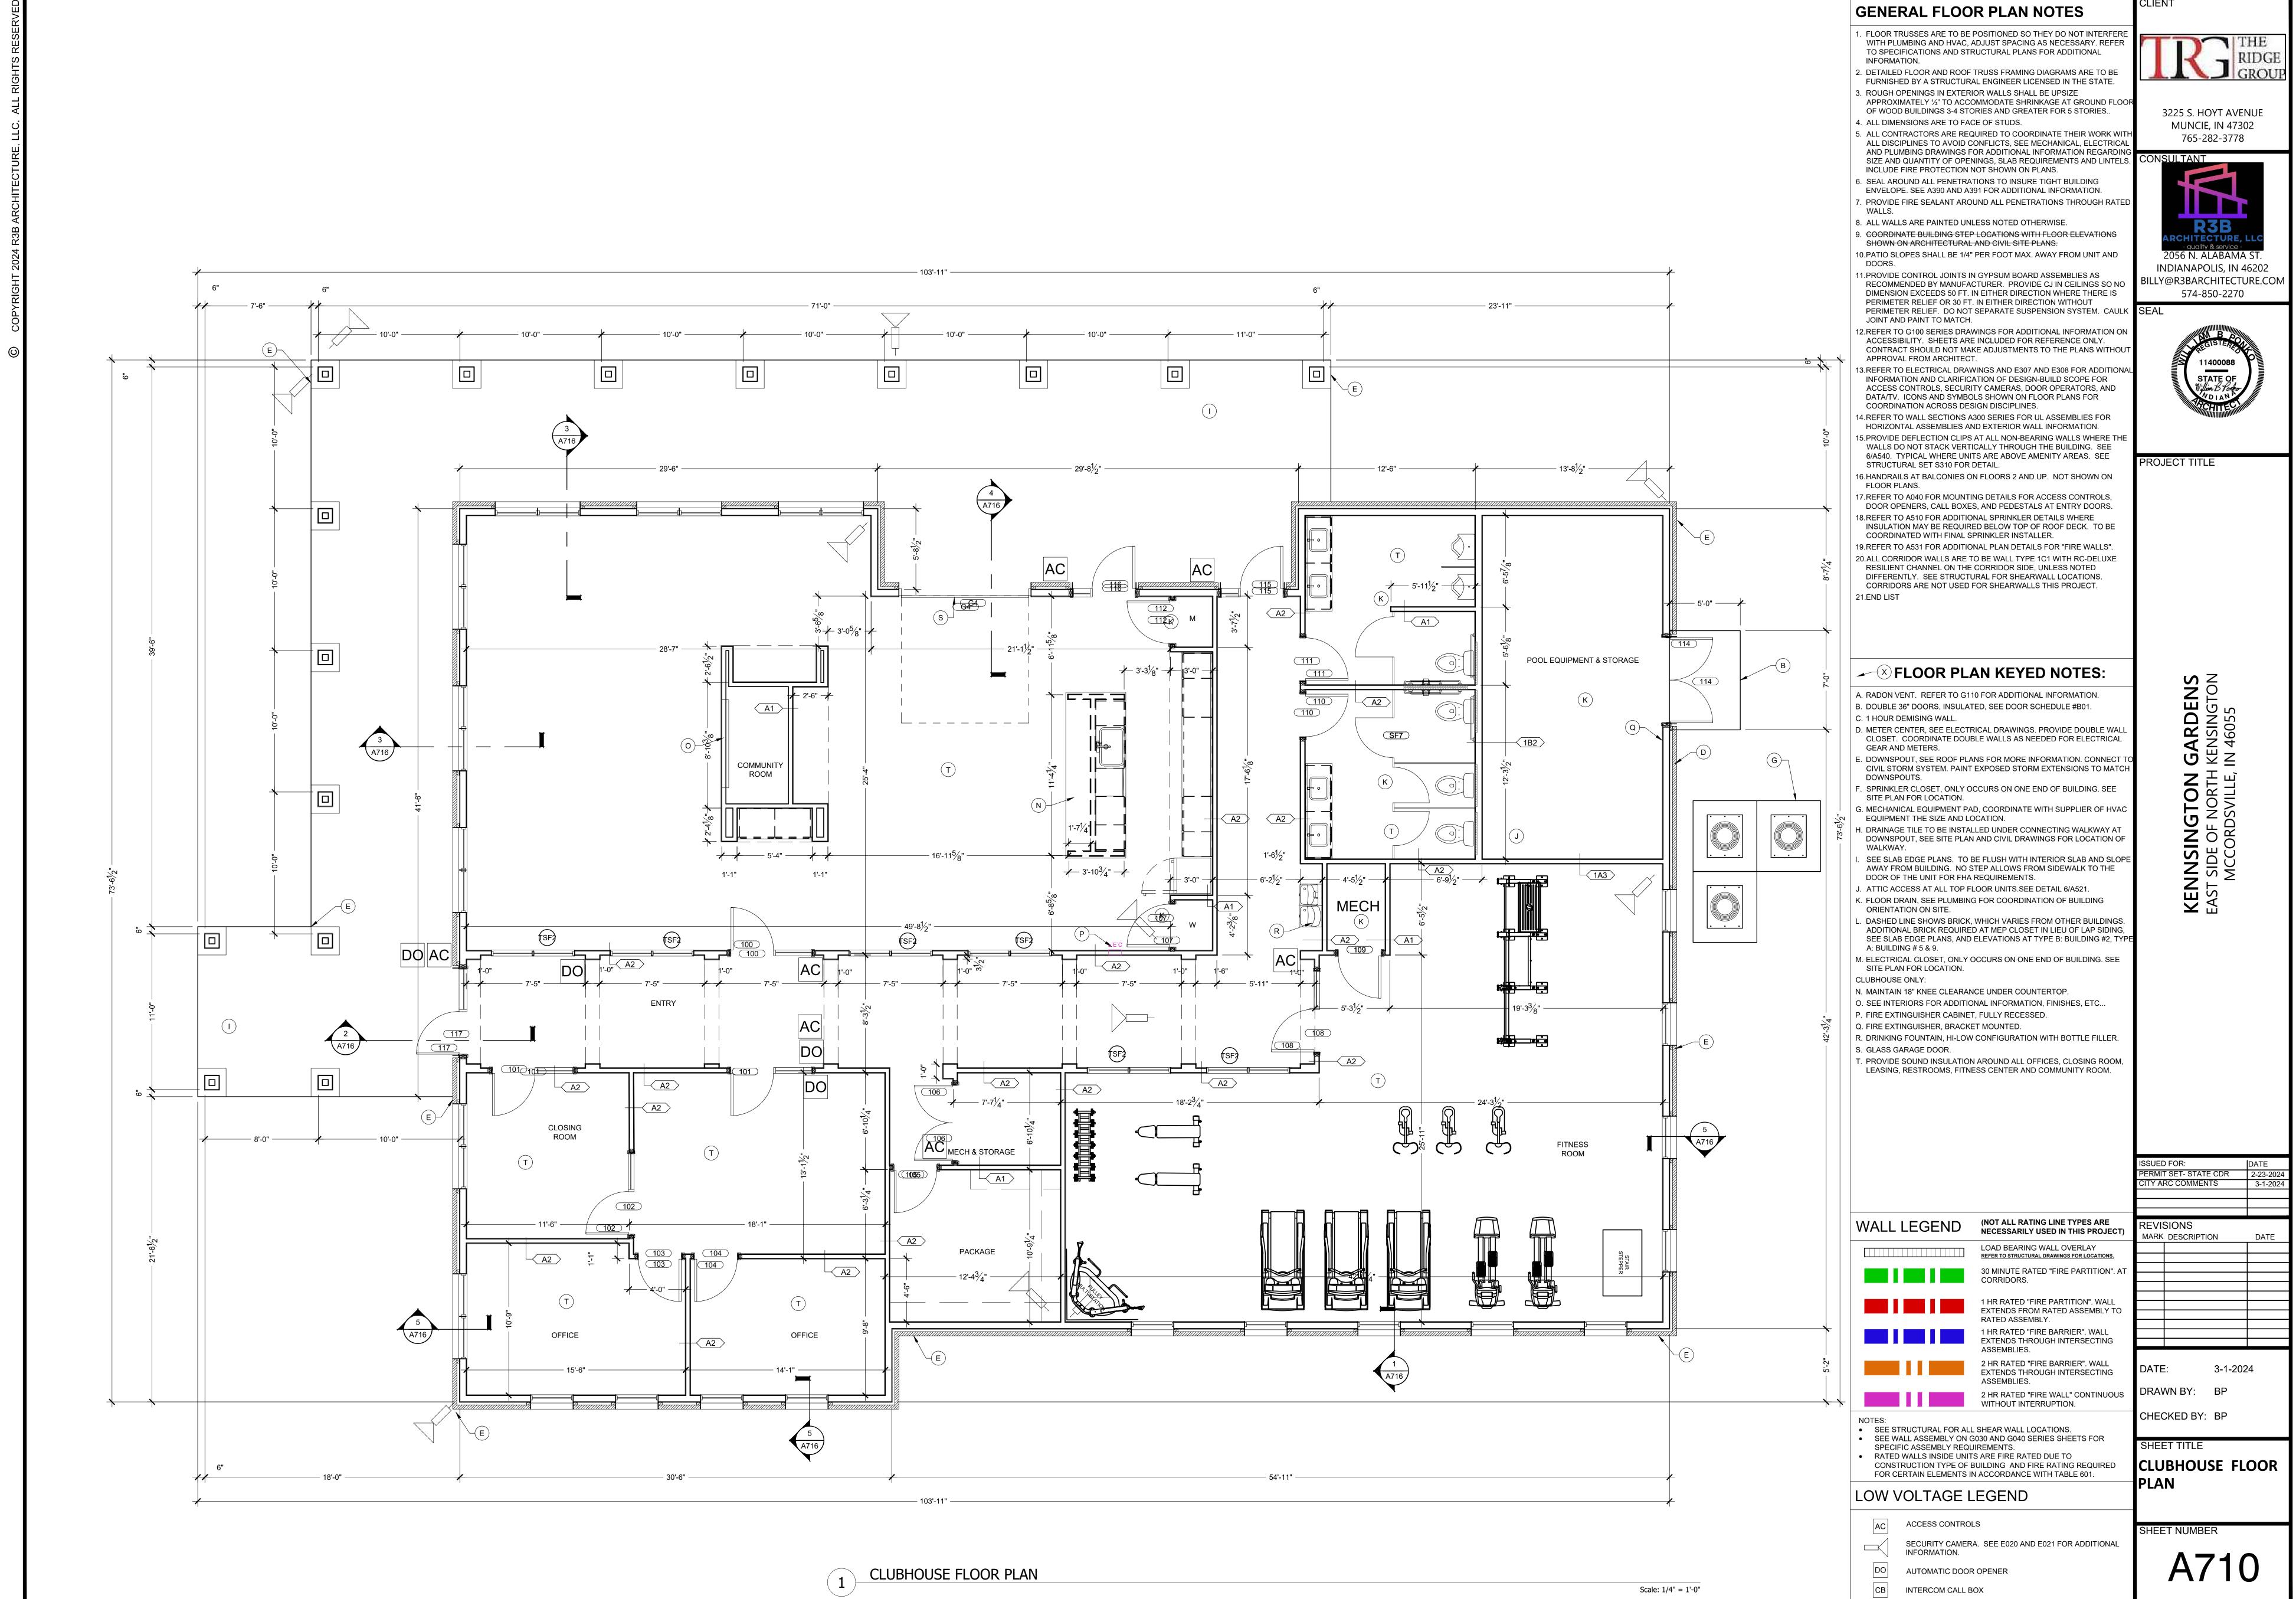


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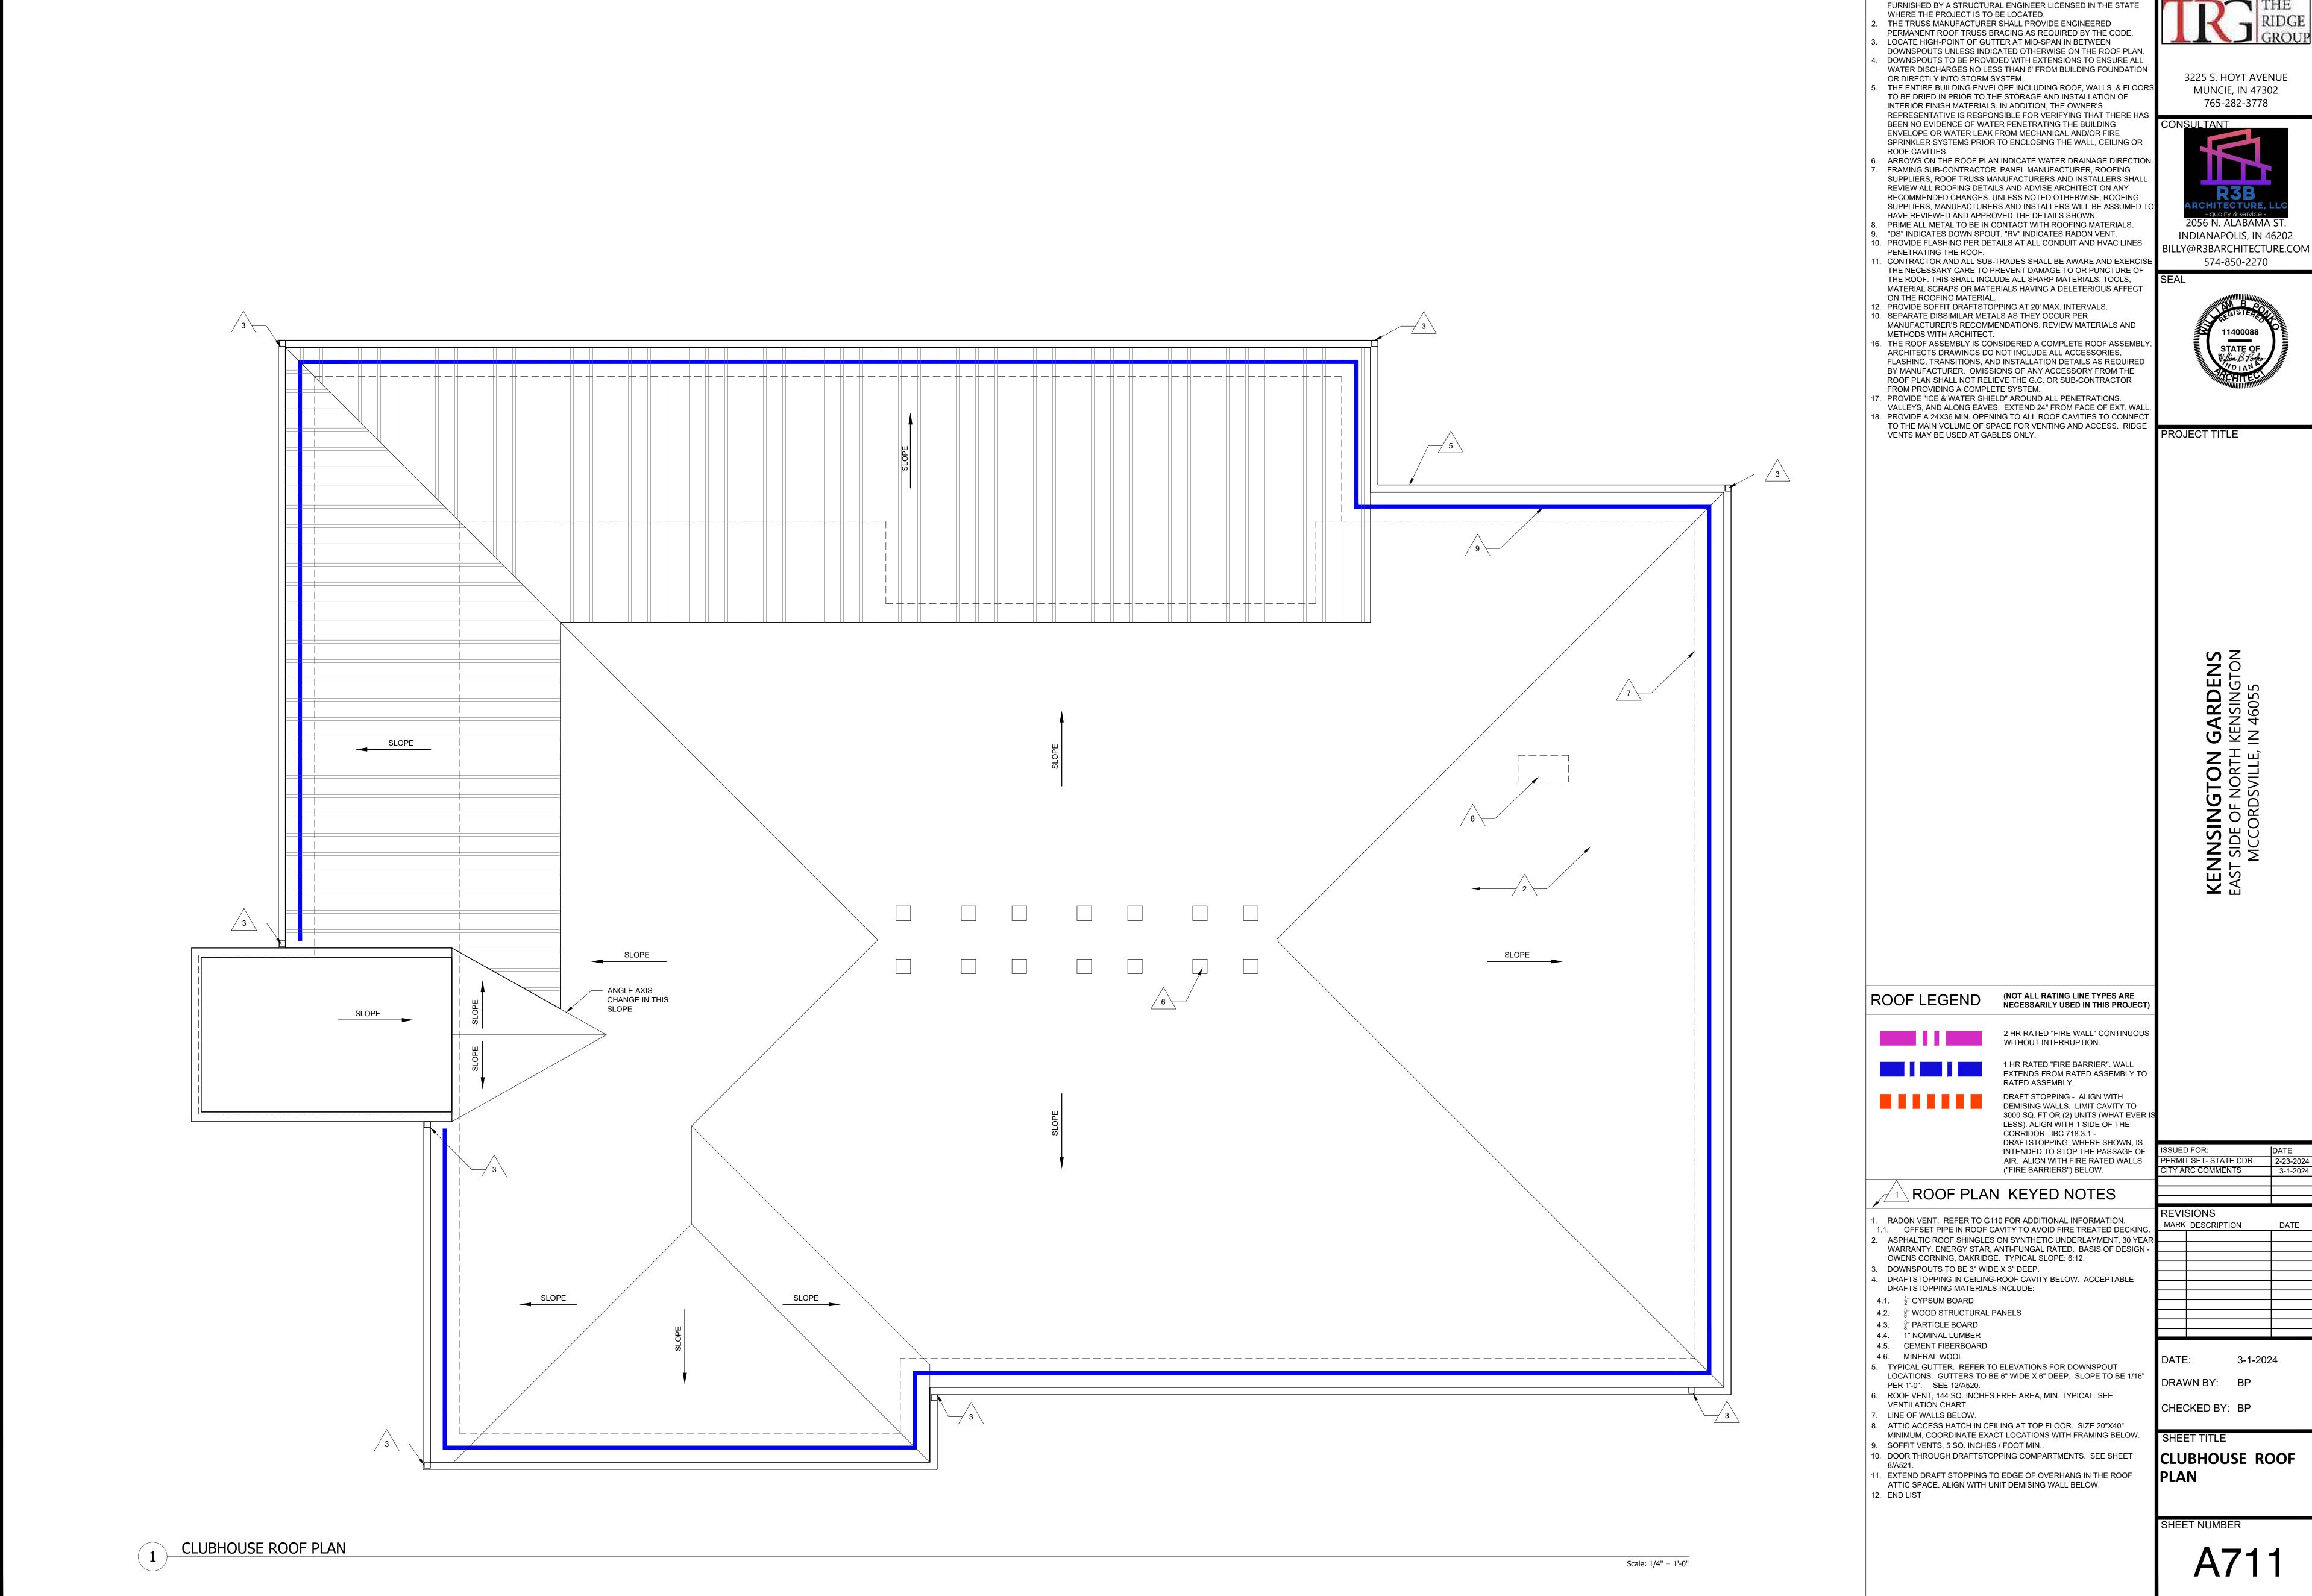
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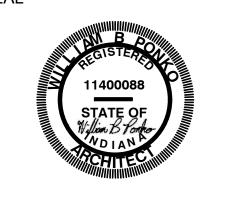



SEE E307 AND E308 FOR ADDITIONAL INFORMATION.

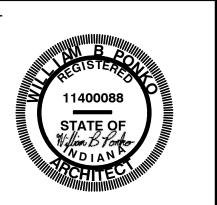


GENERAL NOTES - ROOF PLAN

DETAILED FLOOR AND ROOF TRUSS FRAMING DIAGRAMS ARE TO BE



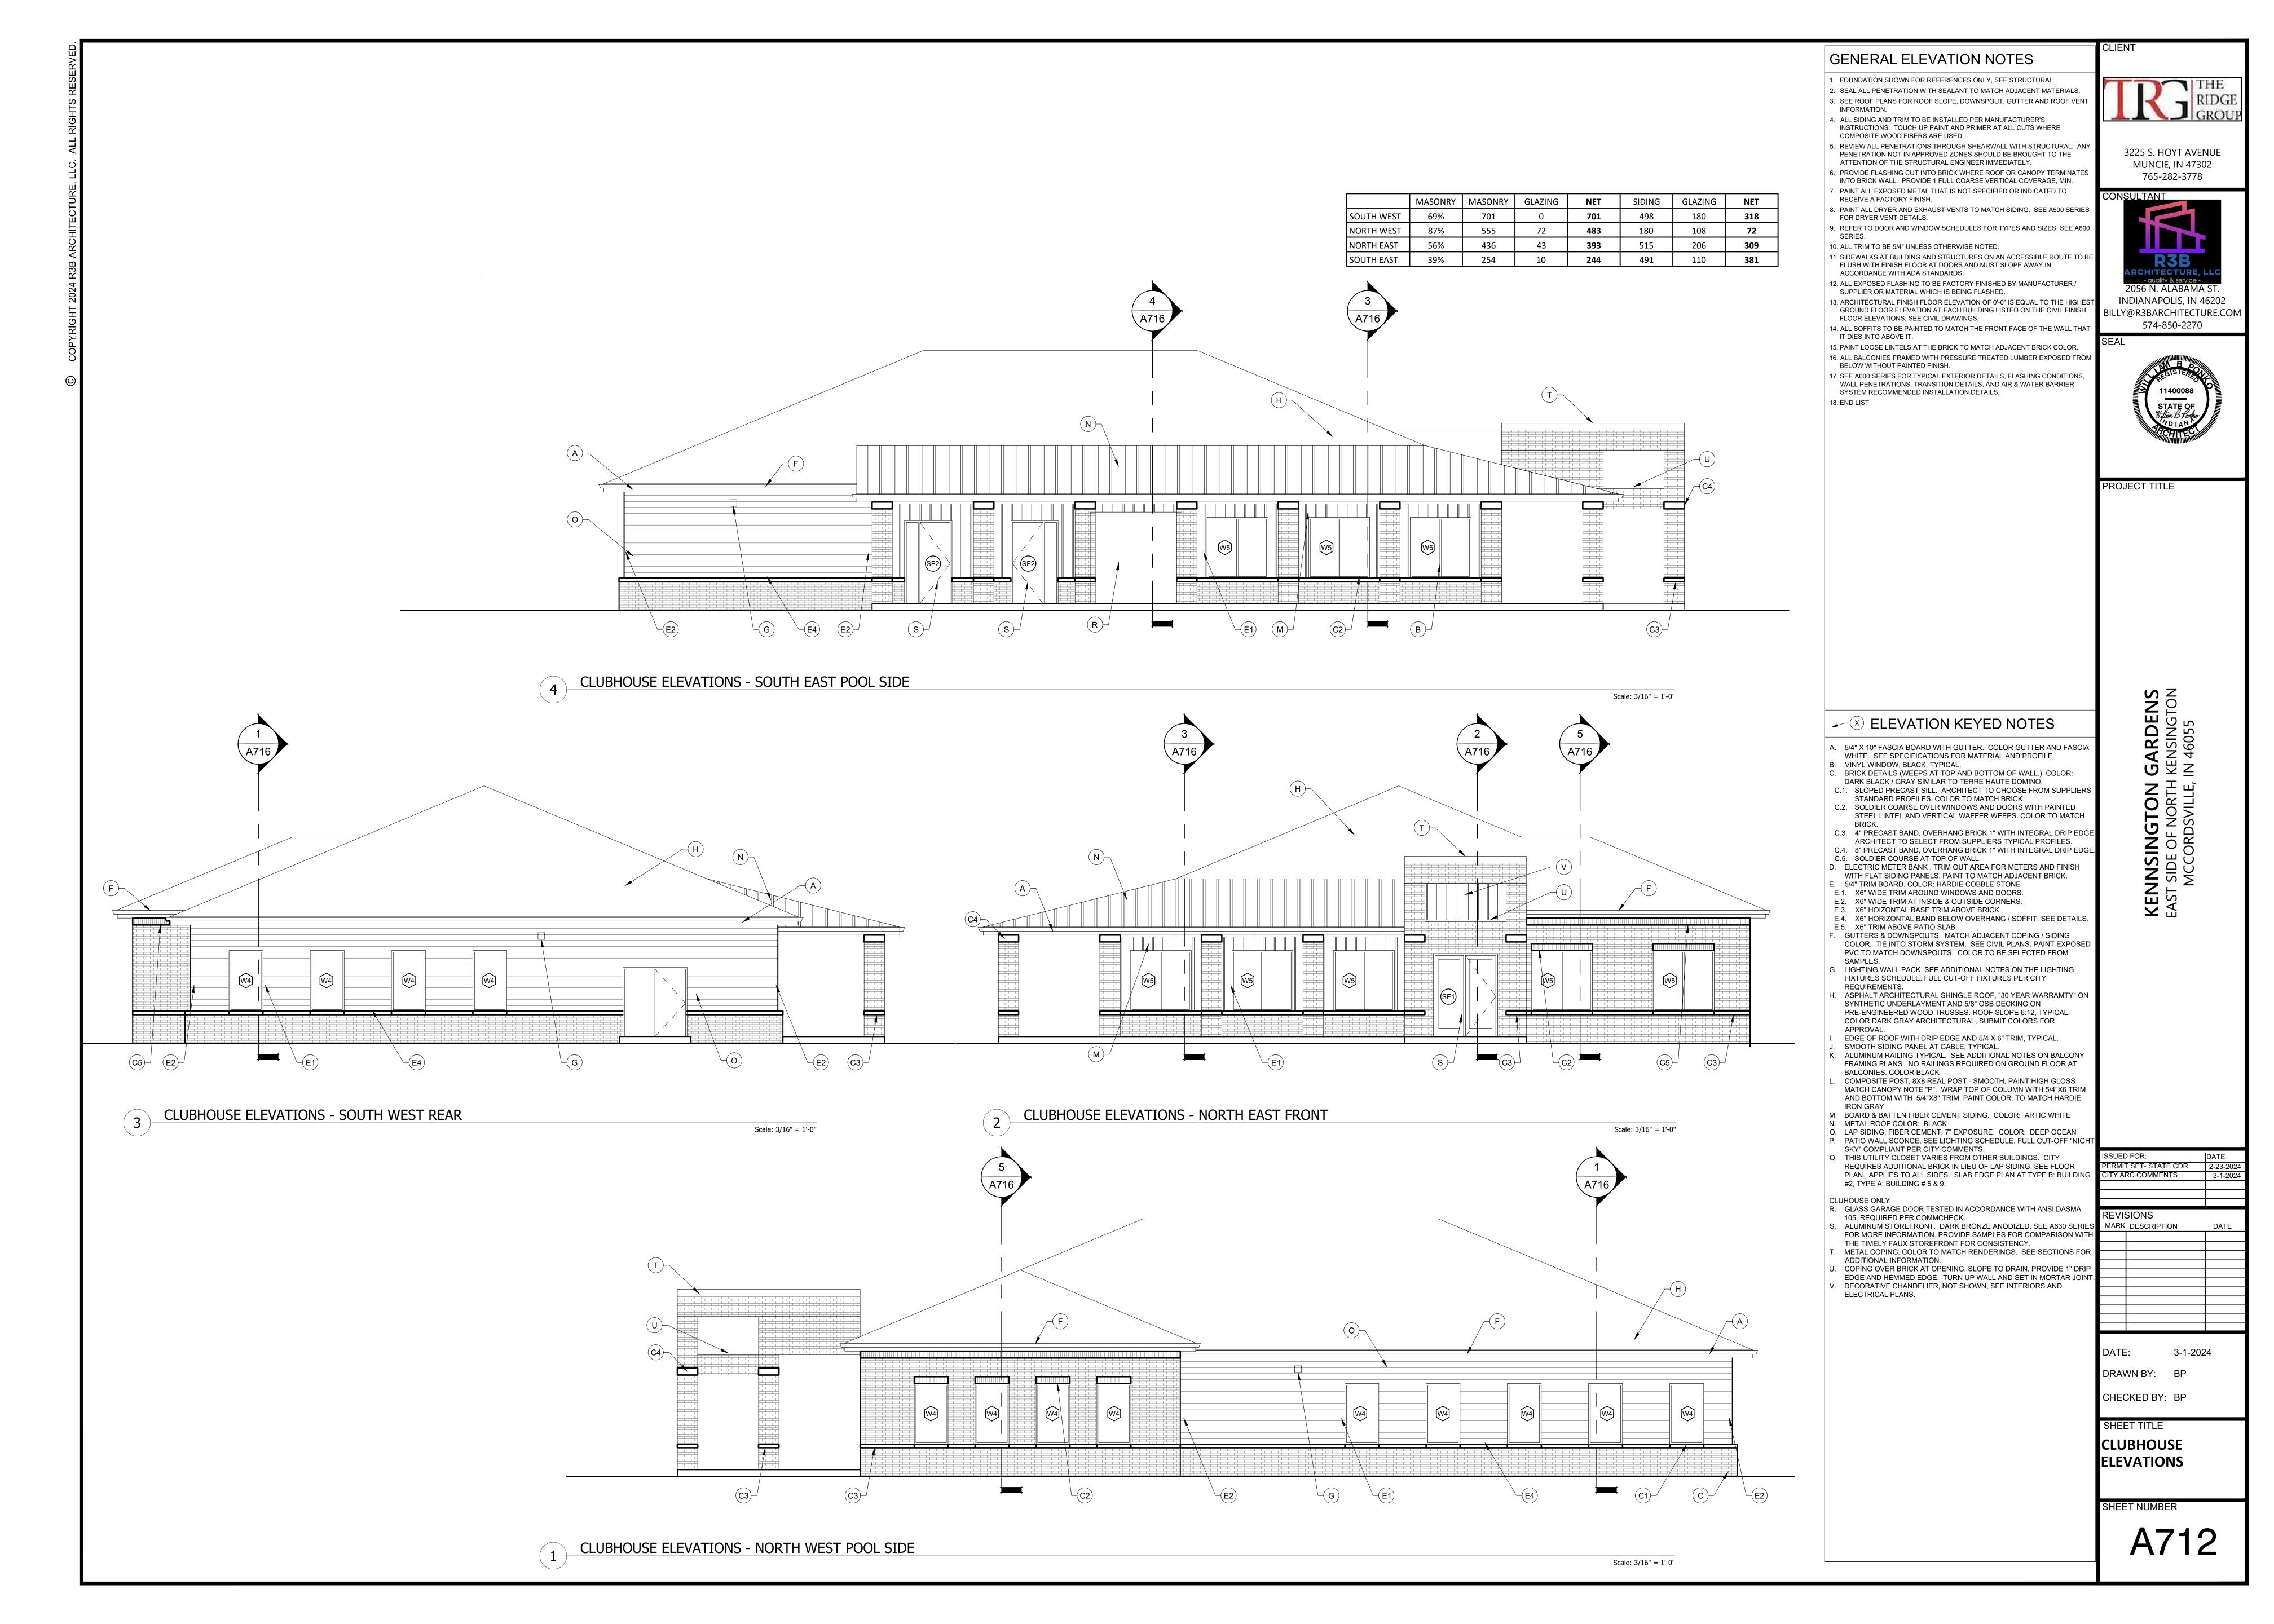

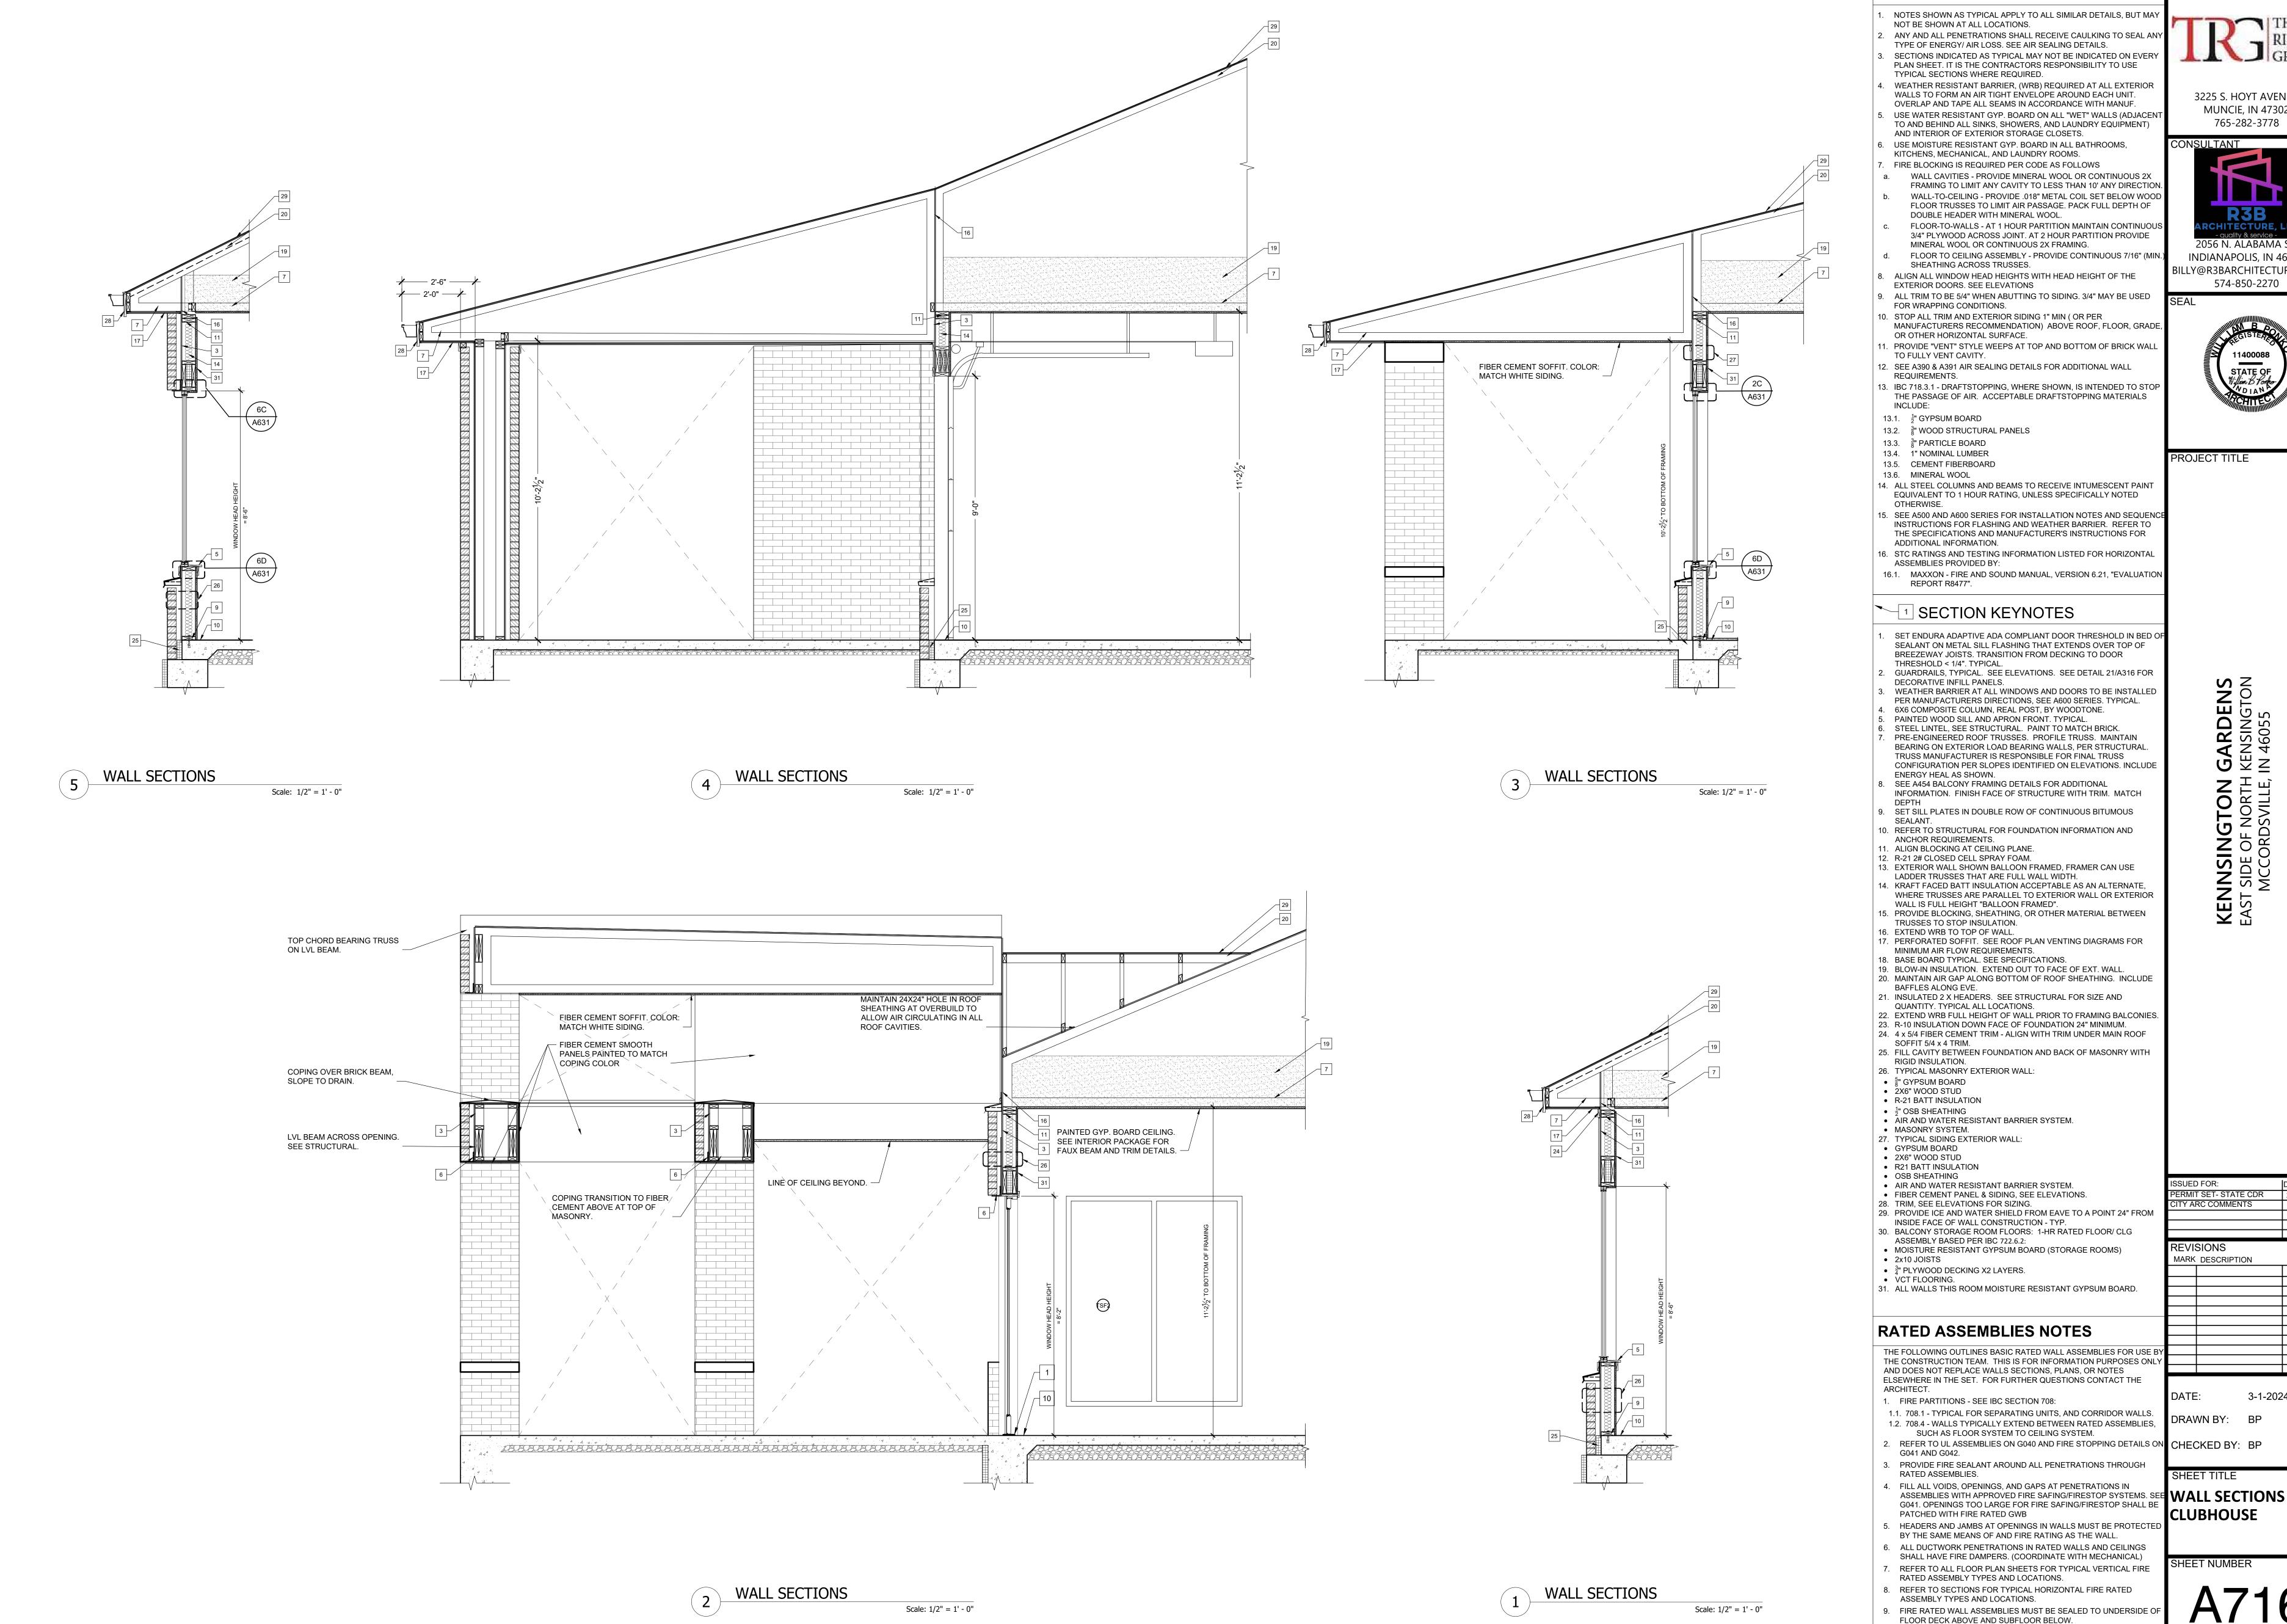


GENERAL SECTION NOTES

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PROJECT TITLE

SET ENDURA ADAPTIVE ADA COMPLIANT DOOR THRESHOLD IN BED O SEALANT ON METAL SILL FLASHING THAT EXTENDS OVER TOP OF

GUARDRAILS, TYPICAL. SEE ELEVATIONS. SEE DETAIL 21/A316 FOR

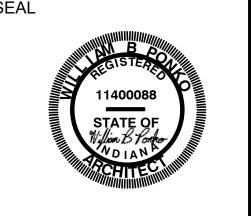WEATHER BARRIER AT ALL WINDOWS AND DOORS TO BE INSTALLED PER MANUFACTURERS DIRECTIONS, SEE A600 SERIES. TYPICAL.

PRE-ENGINEERED ROOF TRUSSES. PROFILE TRUSS. MAINTAIN BEARING ON EXTERIOR LOAD BEARING WALLS, PER STRUCTURAL TRUSS MANUFACTURER IS RESPONSIBLE FOR FINAL TRUSS

. SET SILL PLATES IN DOUBLE ROW OF CONTINUOUS BITUMOUS

14. KRAFT FACED BATT INSULATION ACCEPTABLE AS AN ALTERNATE

WHERE TRUSSES ARE PARALLEL TO EXTERIOR WALL OR EXTERIOR 15. PROVIDE BLOCKING, SHEATHING, OR OTHER MATERIAL BETWEEN

17. PERFORATED SOFFIT. SEE ROOF PLAN VENTING DIAGRAMS FOR

24. 4 x 5/4 FIBER CEMENT TRIM - ALIGN WITH TRIM UNDER MAIN ROOF

THE FOLLOWING OUTLINES BASIC RATED WALL ASSEMBLIES FOR USE BY THE CONSTRUCTION TEAM. THIS IS FOR INFORMATION PURPOSES ONLY AND DOES NOT REPLACE WALLS SECTIONS, PLANS, OR NOTES ELSEWHERE IN THE SET. FOR FURTHER QUESTIONS CONTACT THE

1.1. 708.1 - TYPICAL FOR SEPARATING UNITS, AND CORRIDOR WALLS. 1.2. 708.4 - WALLS TYPICALLY EXTEND BETWEEN RATED ASSEMBLIES, DRAWN BY: BP

REFER TO UL ASSEMBLIES ON G040 AND FIRE STOPPING DETAILS ON CHECKED BY: BP

G041. OPENINGS TOO LARGE FOR FIRE SAFING/FIRESTOP SHALL BE

10. END LIST.

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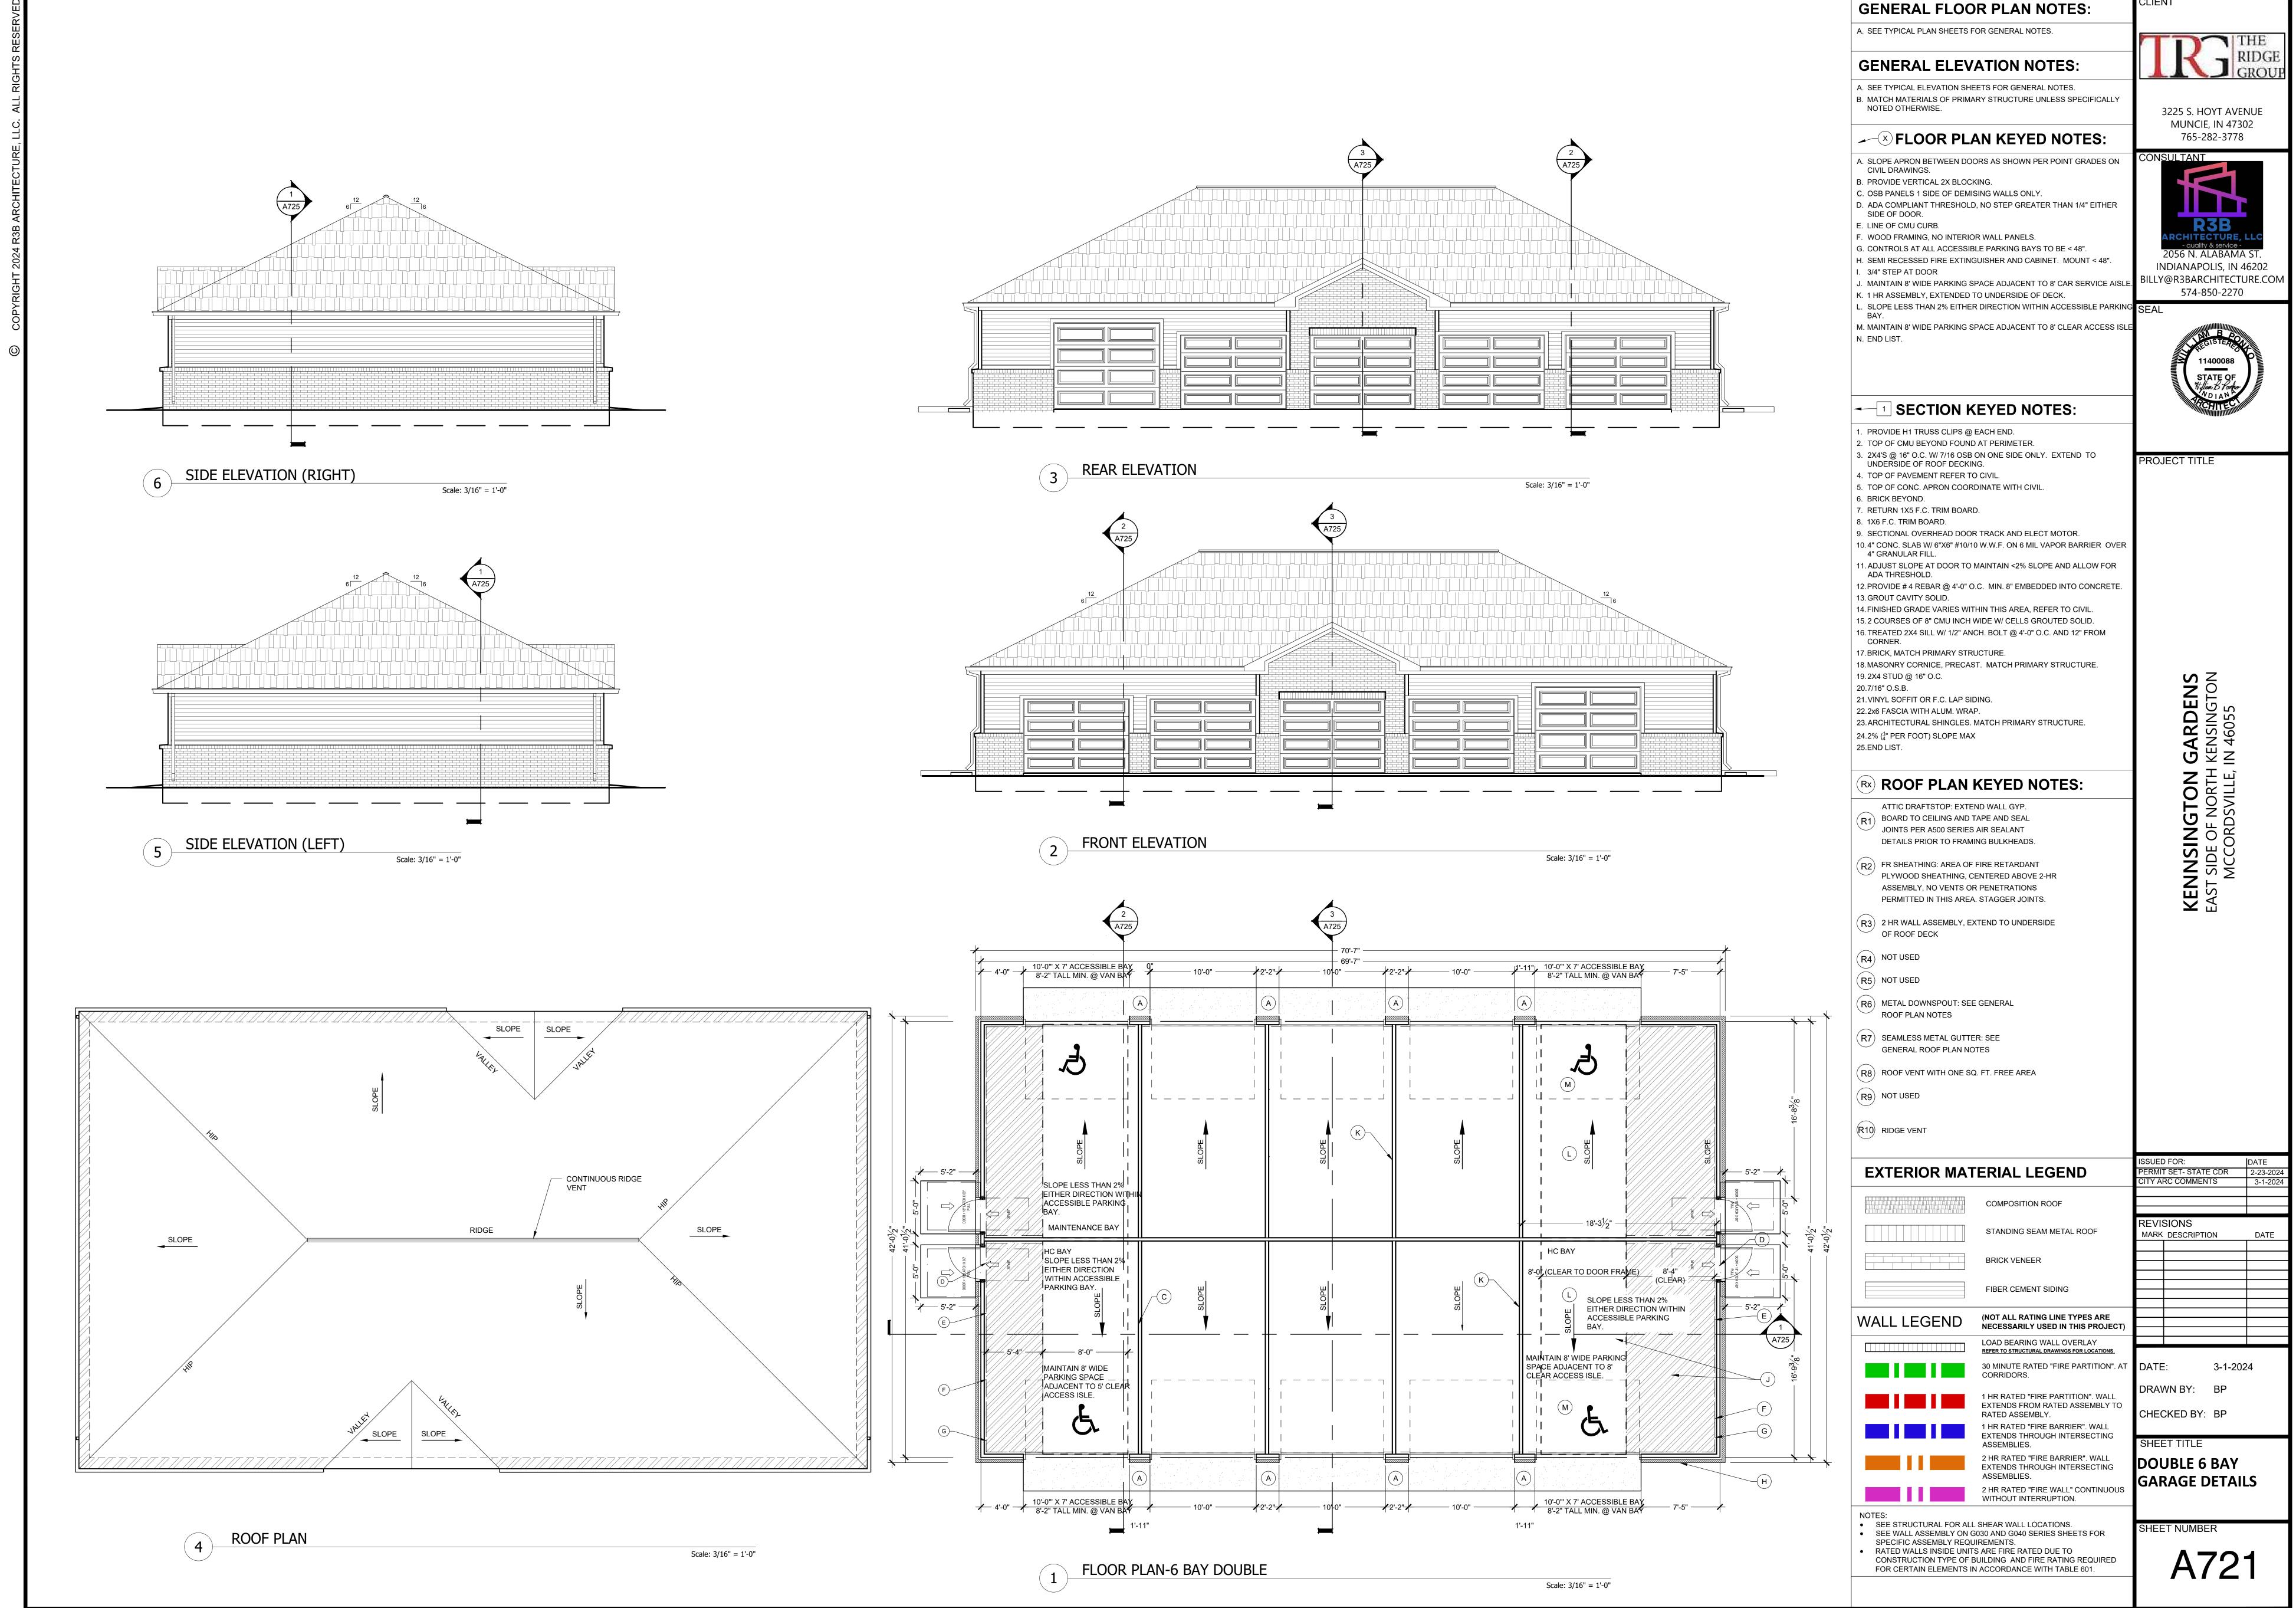
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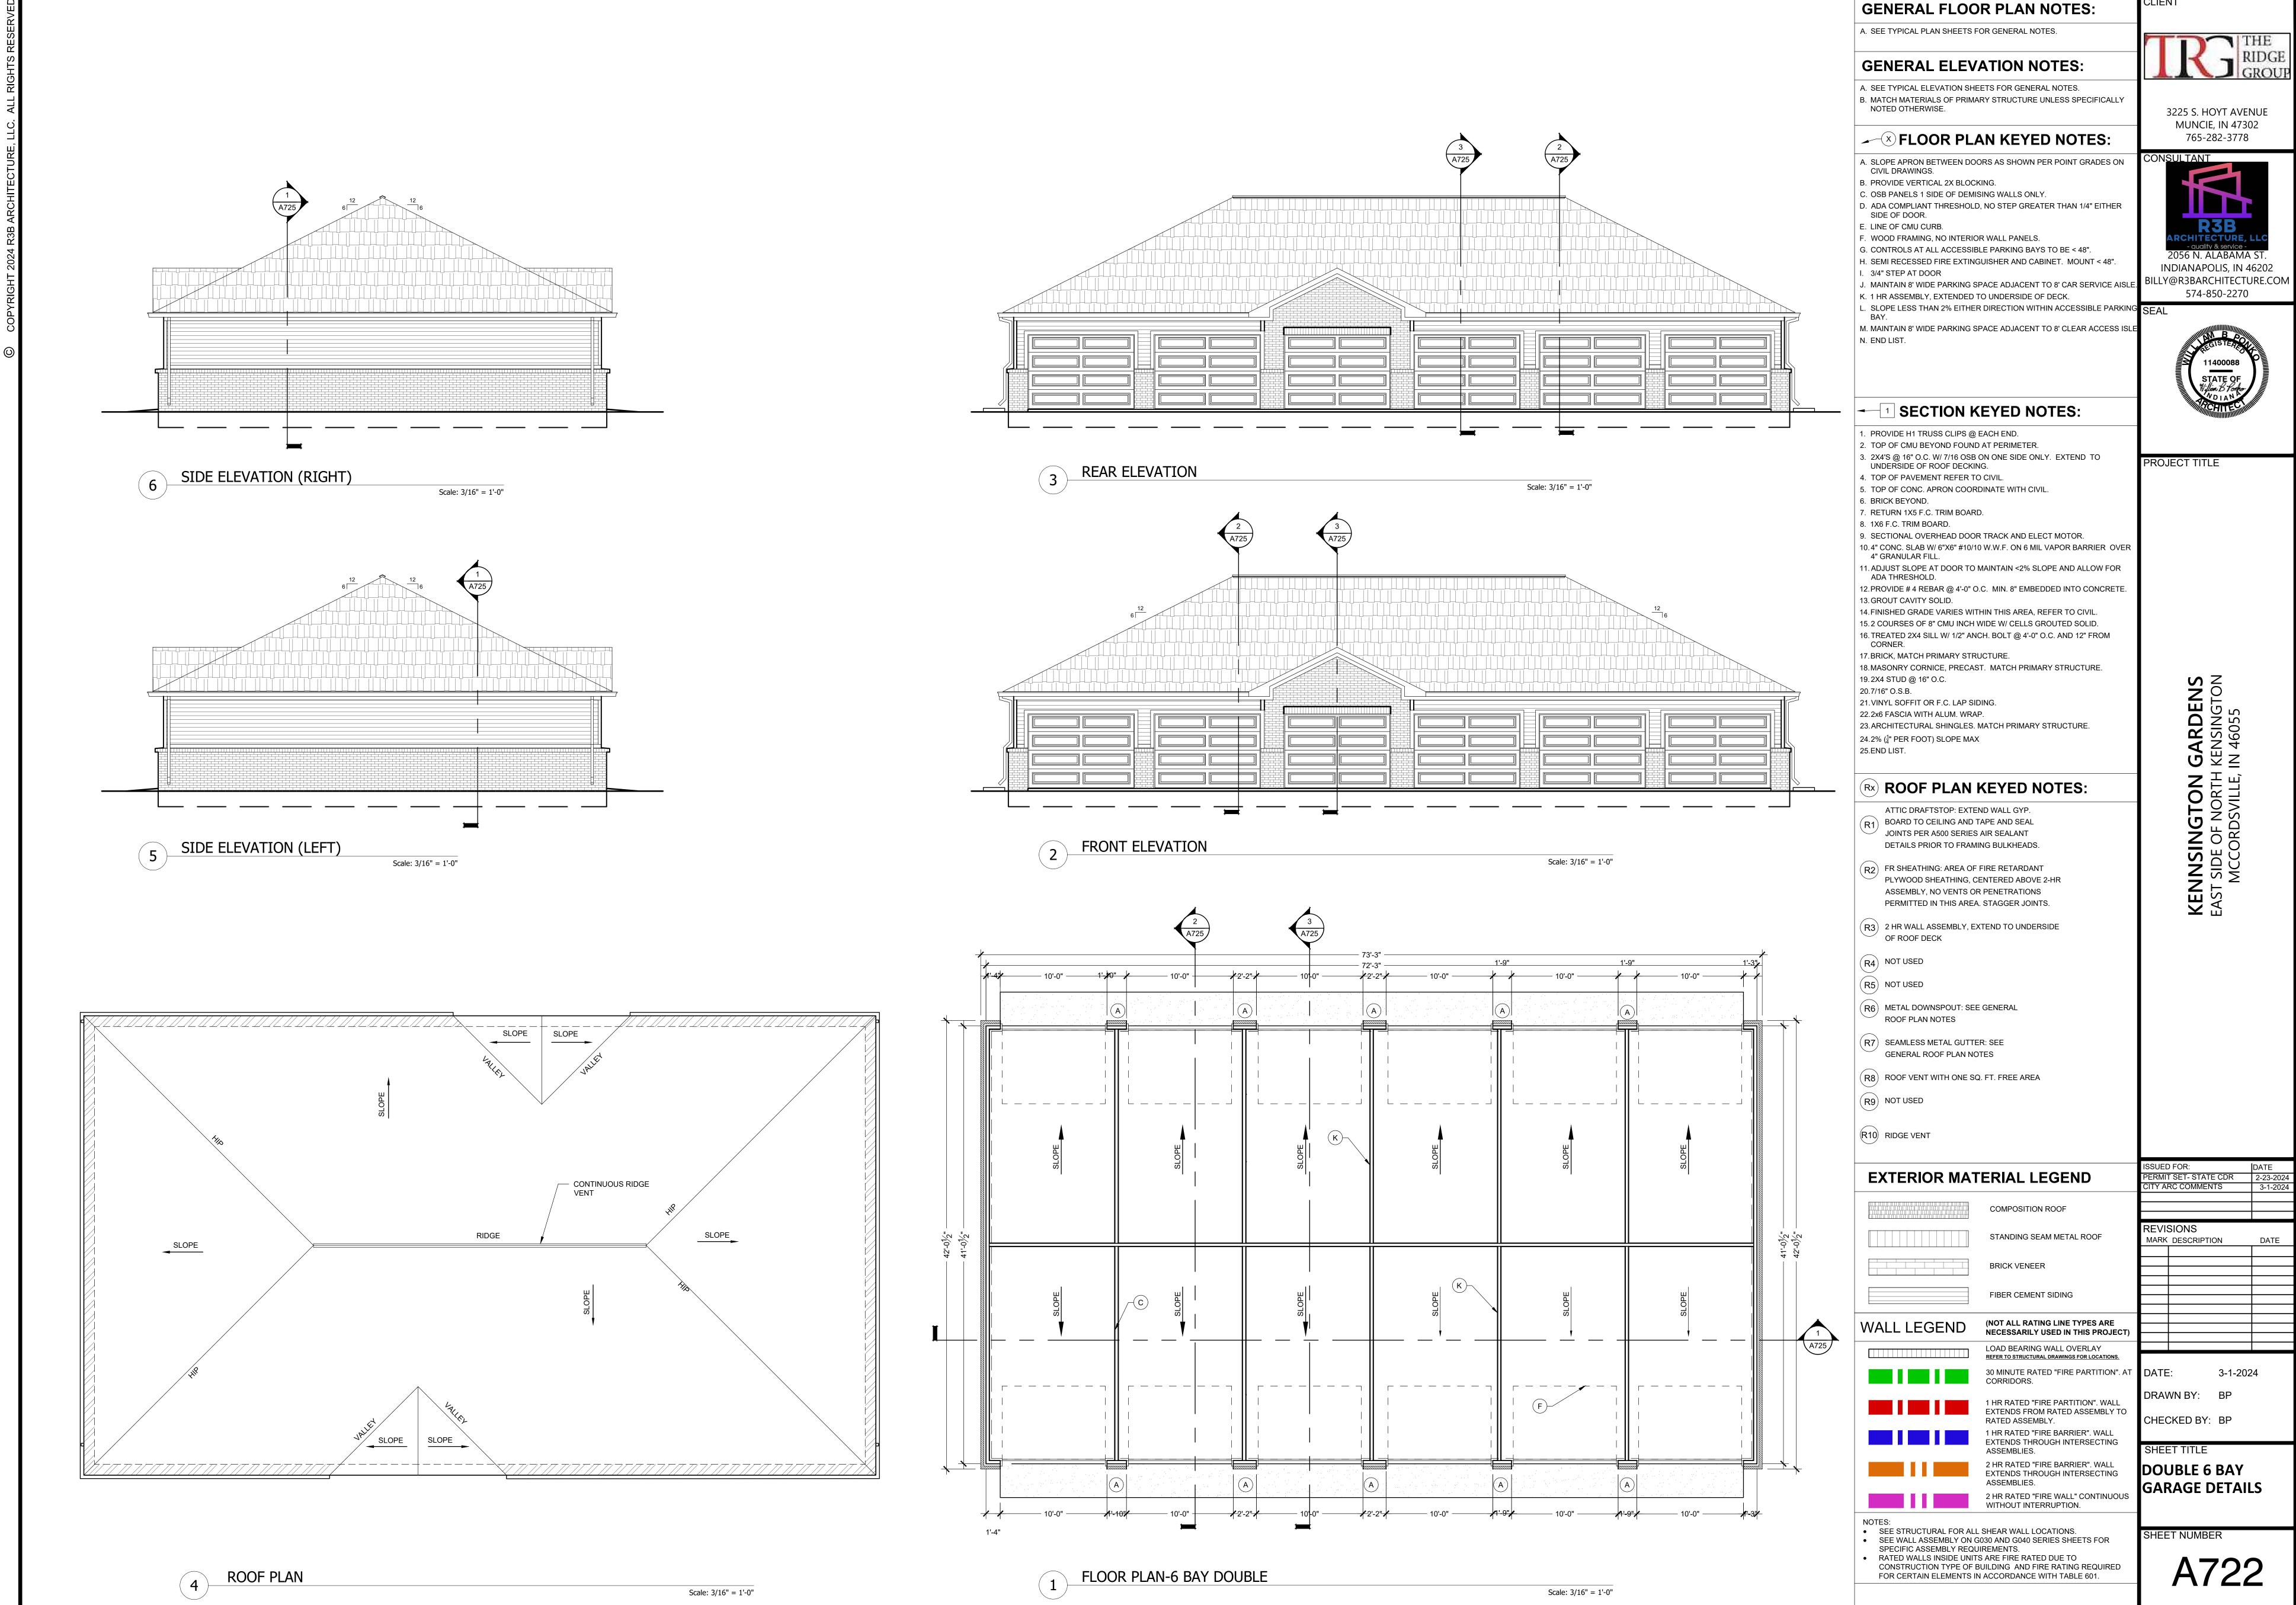
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CLUBHOUSE


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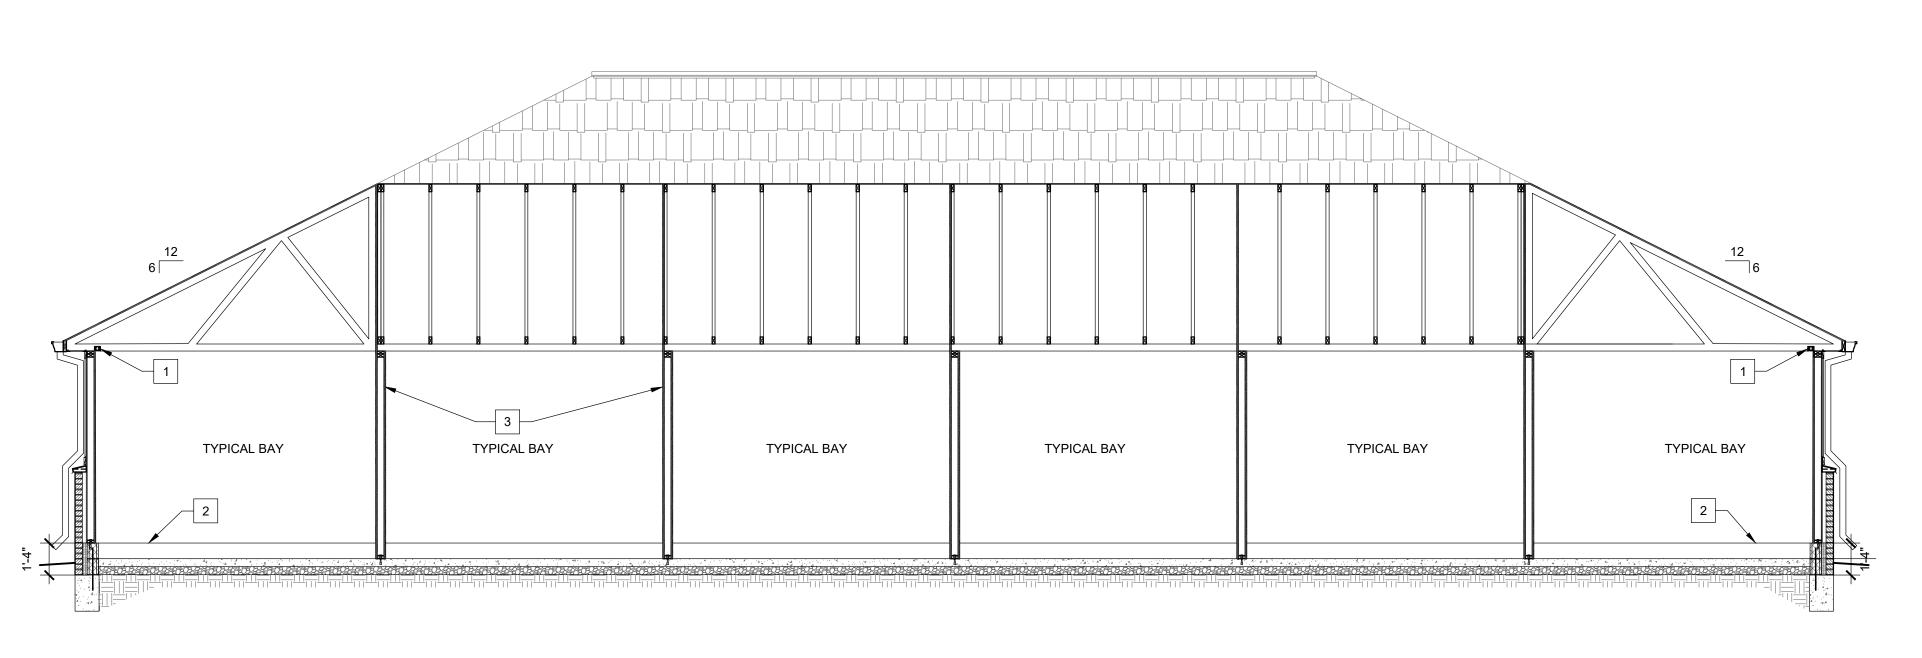




SCALE: 1/4" = 1'-0"





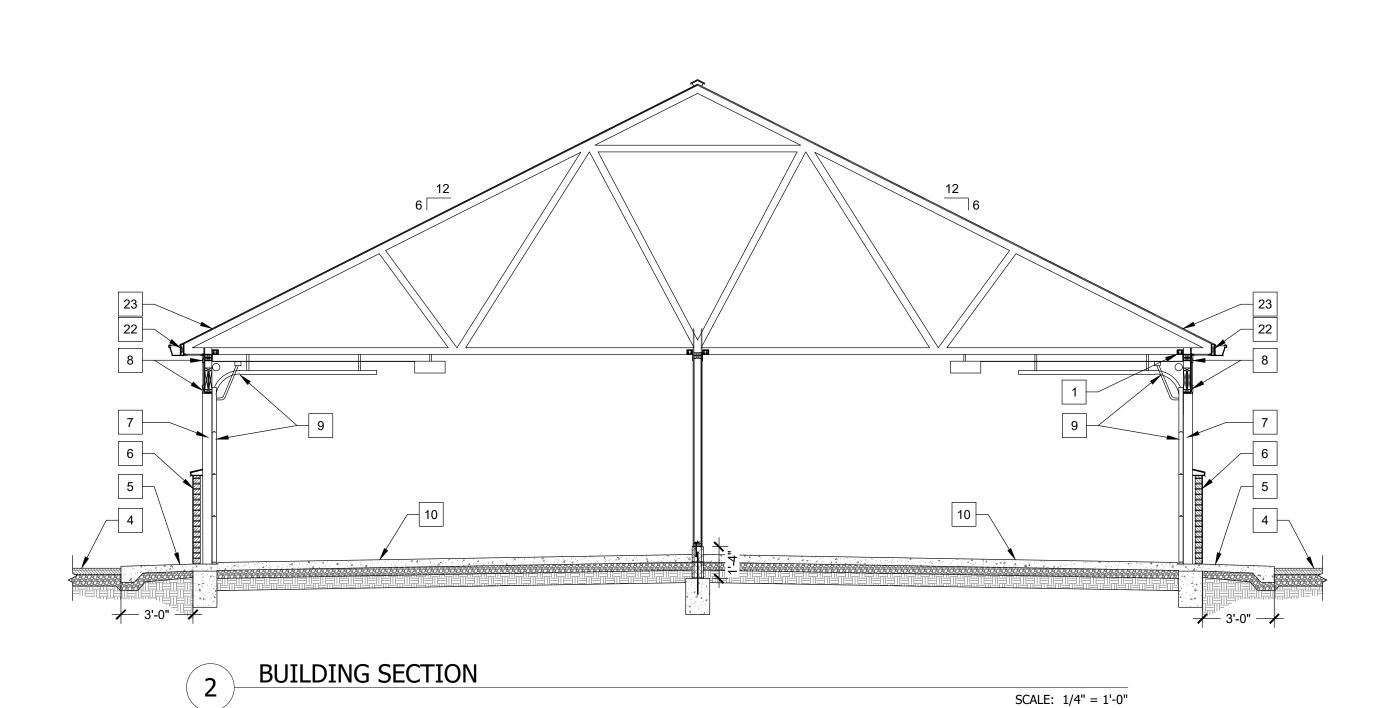

3 WALL SECTION Scale: 3/4'' = 1'-0''

5

1 BUILDING SECTION

SCALE: 1/4" = 1'-0"

GENERAL FLOOR PLAN NOTES:

A. SEE TYPICAL PLAN SHEETS FOR GENERAL NOTES.

GENERAL ELEVATION NOTES:

A. SEE TYPICAL ELEVATION SHEETS FOR GENERAL NOTES. B. MATCH MATERIALS OF PRIMARY STRUCTURE UNLESS SPECIFICALLY

NOTED OTHERWISE.

A. SLOPE APRON BETWEEN DOORS AS SHOWN PER POINT GRADES ON

FLOOR PLAN KEYED NOTES:

- CIVIL DRAWINGS.
- B. PROVIDE VERTICAL 2X BLOCKING. C. OSB PANELS 1 SIDE OF DEMISING WALLS ONLY.
- D. ADA COMPLIANT THRESHOLD, NO STEP GREATER THAN 1/4" EITHER SIDE OF DOOR. E. LINE OF CMU CURB.
- F. WOOD FRAMING, NO INTERIOR WALL PANELS.
- G. CONTROLS AT ALL ACCESSIBLE PARKING BAYS TO BE < 48". H. SEMI RECESSED FIRE EXTINGUISHER AND CABINET. MOUNT < 48".

K. 1 HR ASSEMBLY, EXTENDED TO UNDERSIDE OF DECK.

- I. 3/4" STEP AT DOOR J. MAINTAIN 8' WIDE PARKING SPACE ADJACENT TO 8' CAR SERVICE AISLE
- L. SLOPE LESS THAN 2% EITHER DIRECTION WITHIN ACCESSIBLE PARKING SEAL

M. MAINTAIN 8' WIDE PARKING SPACE ADJACENT TO 8' CLEAR ACCESS ISLE N. END LIST.



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SECTION KEYED NOTES:

- 1. PROVIDE H1 TRUSS CLIPS @ EACH END.
- 2. TOP OF CMU BEYOND FOUND AT PERIMETER. 3. 2X4'S @ 16" O.C. W/ 7/16 OSB ON ONE SIDE ONLY. EXTEND TO UNDERSIDE OF ROOF DECKING.
- 4. TOP OF PAVEMENT REFER TO CIVIL.
- 5. TOP OF CONC. APRON COORDINATE WITH CIVIL.
- 6. BRICK BEYOND.
- 7. RETURN 1X5 F.C. TRIM BOARD.
- 8. 1X6 F.C. TRIM BOARD. 9. SECTIONAL OVERHEAD DOOR TRACK AND ELECT MOTOR.
- 10.4" CONC. SLAB W/ 6"X6" #10/10 W.W.F. ON 6 MIL VAPOR BARRIER OVER 4" GRANULAR FILL.
- 11. ADJUST SLOPE AT DOOR TO MAINTAIN <2% SLOPE AND ALLOW FOR ADA THRESHOLD. 12.PROVIDE # 4 REBAR @ 4'-0" O.C. MIN. 8" EMBEDDED INTO CONCRETE.
- 13. GROUT CAVITY SOLID.
- 14. FINISHED GRADE VARIES WITHIN THIS AREA, REFER TO CIVIL. 15.2 COURSES OF 8" CMU INCH WIDE W/ CELLS GROUTED SOLID.
- 16. TREATED 2X4 SILL W/ 1/2" ANCH. BOLT @ 4'-0" O.C. AND 12" FROM 17.BRICK, MATCH PRIMARY STRUCTURE.
- 18. MASONRY CORNICE, PRECAST. MATCH PRIMARY STRUCTURE. 19.2X4 STUD @ 16" O.C.
- 20.7/16" O.S.B. 21. VINYL SOFFIT OR F.C. LAP SIDING.
- 22.2x6 FASCIA WITH ALUM. WRAP.
- 23.ARCHITECTURAL SHINGLES. MATCH PRIMARY STRUCTURE.
- 24.2% ($\frac{1}{4}$ " PER FOOT) SLOPE MAX 25.END LIST.

(RX) ROOF PLAN KEYED NOTES:

- ATTIC DRAFTSTOP: EXTEND WALL GYP. (R1) BOARD TO CEILING AND TAPE AND SEAL JOINTS PER A500 SERIES AIR SEALANT
- (R2) FR SHEATHING: AREA OF FIRE RETARDANT PLYWOOD SHEATHING, CENTERED ABOVE 2-HR ASSEMBLY, NO VENTS OR PENETRATIONS PERMITTED IN THIS AREA. STAGGER JOINTS.

DETAILS PRIOR TO FRAMING BULKHEADS.

- (R3) 2 HR WALL ASSEMBLY, EXTEND TO UNDERSIDE OF ROOF DECK
- (R4) NOT USED
- (R5) NOT USED
- (R6) METAL DOWNSPOUT: SEE GENERAL ROOF PLAN NOTES
- (R7) SEAMLESS METAL GUTTER: SEE GENERAL ROOF PLAN NOTES
- (R8) ROOF VENT WITH ONE SQ. FT. FREE AREA
- R9 NOT USE
- R10 RIDGE V

EXTER

SED				
VENT				
RIOR MAT	ERIAL LEGEND	PERMI	D FOR: T SET- STATE CDR RC COMMENTS	DATE 2-23-2024 3-1-2024
	COMPOSITION ROOF			
	STANDING SEAM METAL ROOF		SIONS DESCRIPTION	DATE
	BRICK VENEER			
	FIBER CEMENT SIDING			
EGEND	(NOT ALL RATING LINE TYPES ARE			

NECESSARILY USED IN THIS PROJECT)



RATED ASSEMBLY. 1 HR RATED "FIRE BARRIER". WALL EXTENDS THROUGH INTERSECTING

ASSEMBLIES. 2 HR RATED "FIRE BARRIER". WALL EXTENDS THROUGH INTERSECTING ASSEMBLIES. 2 HR RATED "FIRE WALL" CONTINUOUS WITHOUT INTERRUPTION.

SEE STRUCTURAL FOR ALL SHEAR WALL LOCATIONS.

FOR CERTAIN ELEMENTS IN ACCORDANCE WITH TABLE 601.

 SEE WALL ASSEMBLY ON G030 AND G040 SERIES SHEETS FOR SPECIFIC ASSEMBLY REQUIREMENTS. RATED WALLS INSIDE UNITS ARE FIRE RATED DUE TO CONSTRUCTION TYPE OF BUILDING AND FIRE RATING REQUIRED


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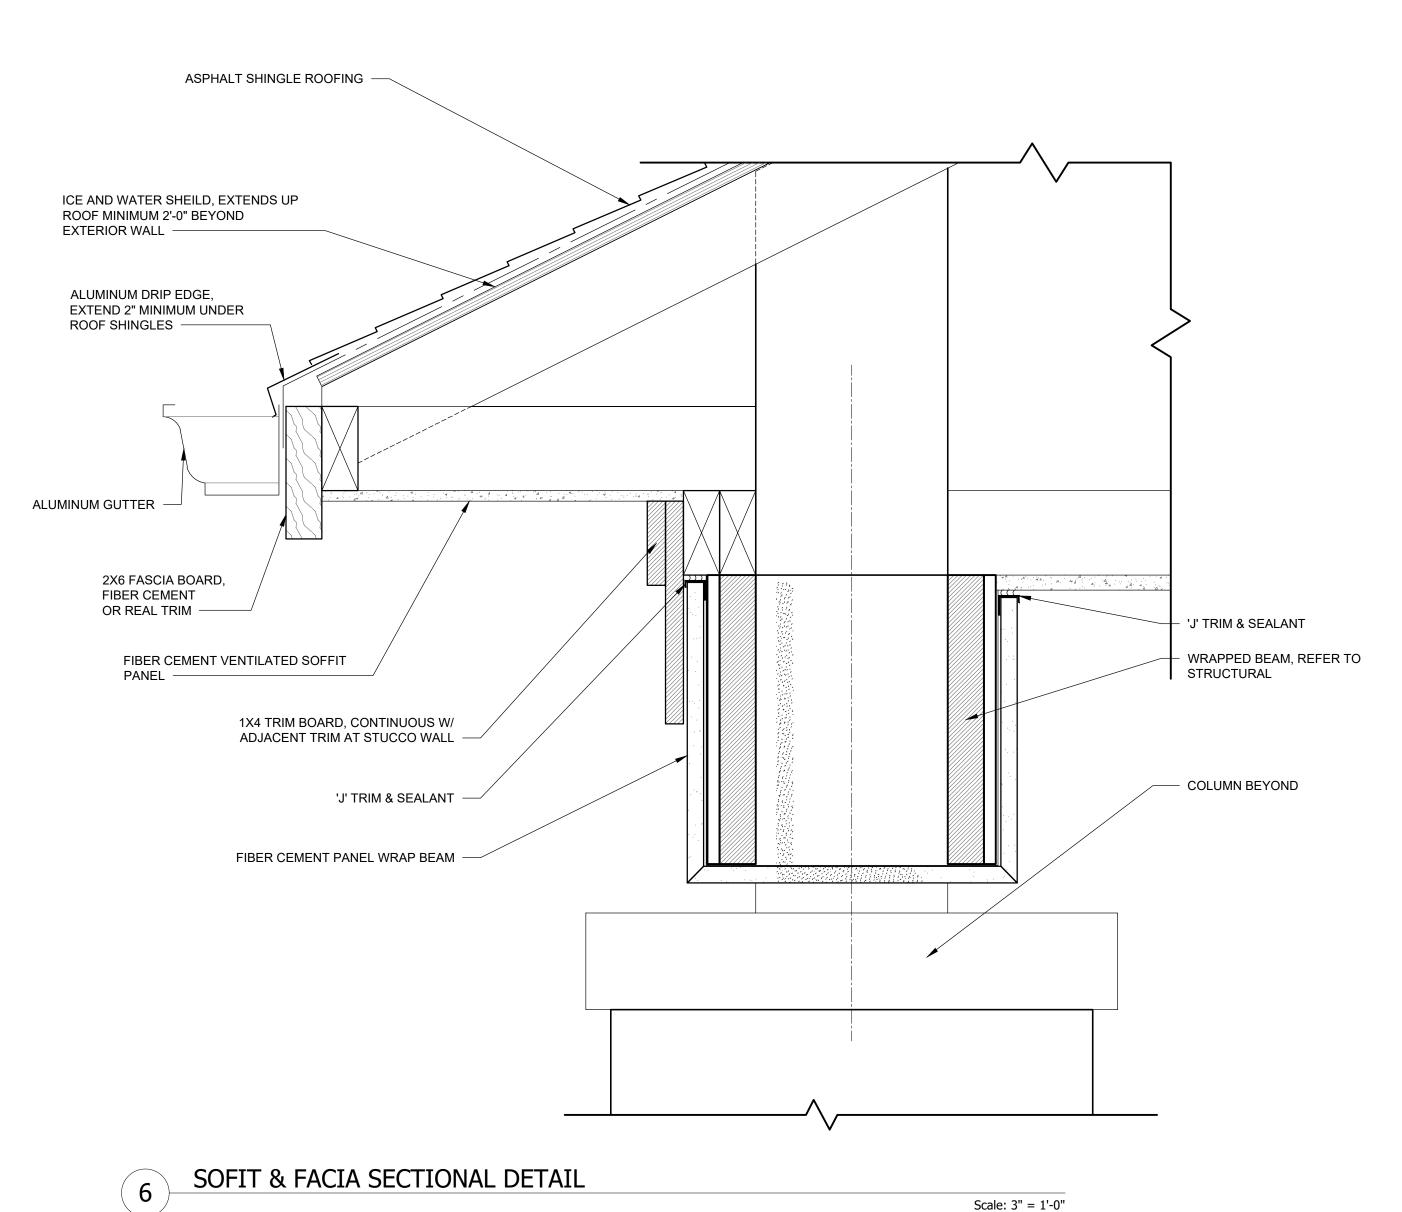
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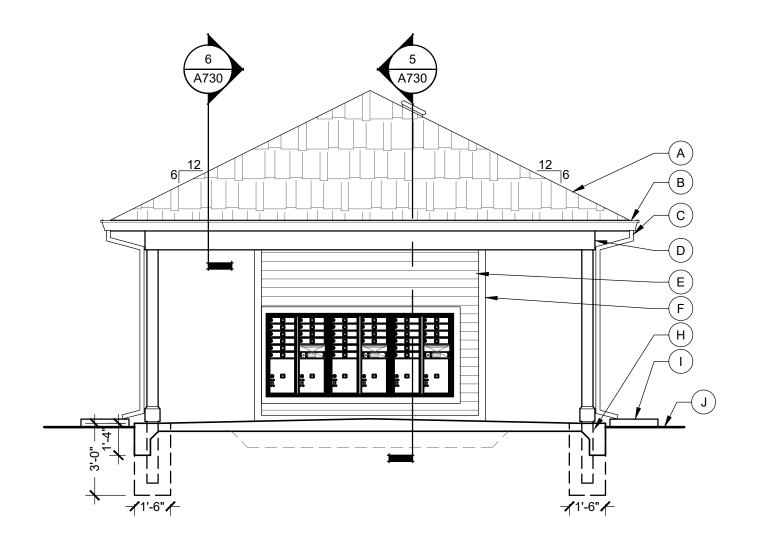
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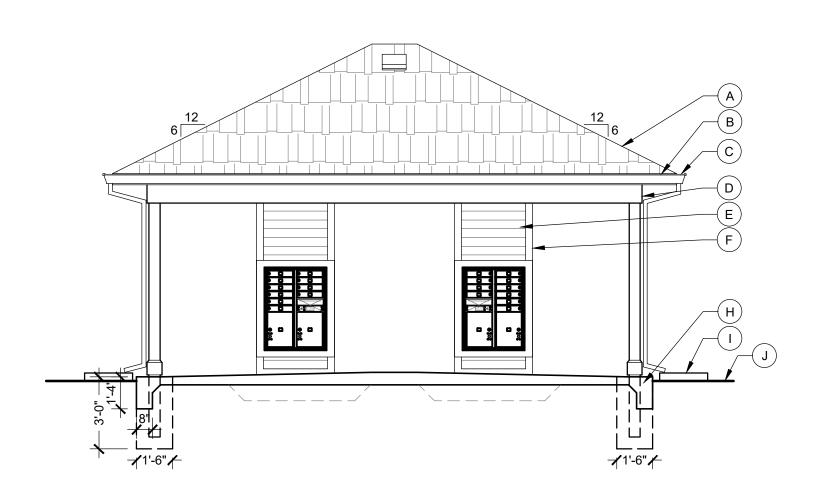
GARAGE SECTION &








4 SIDE ELEVATION (LEFT)

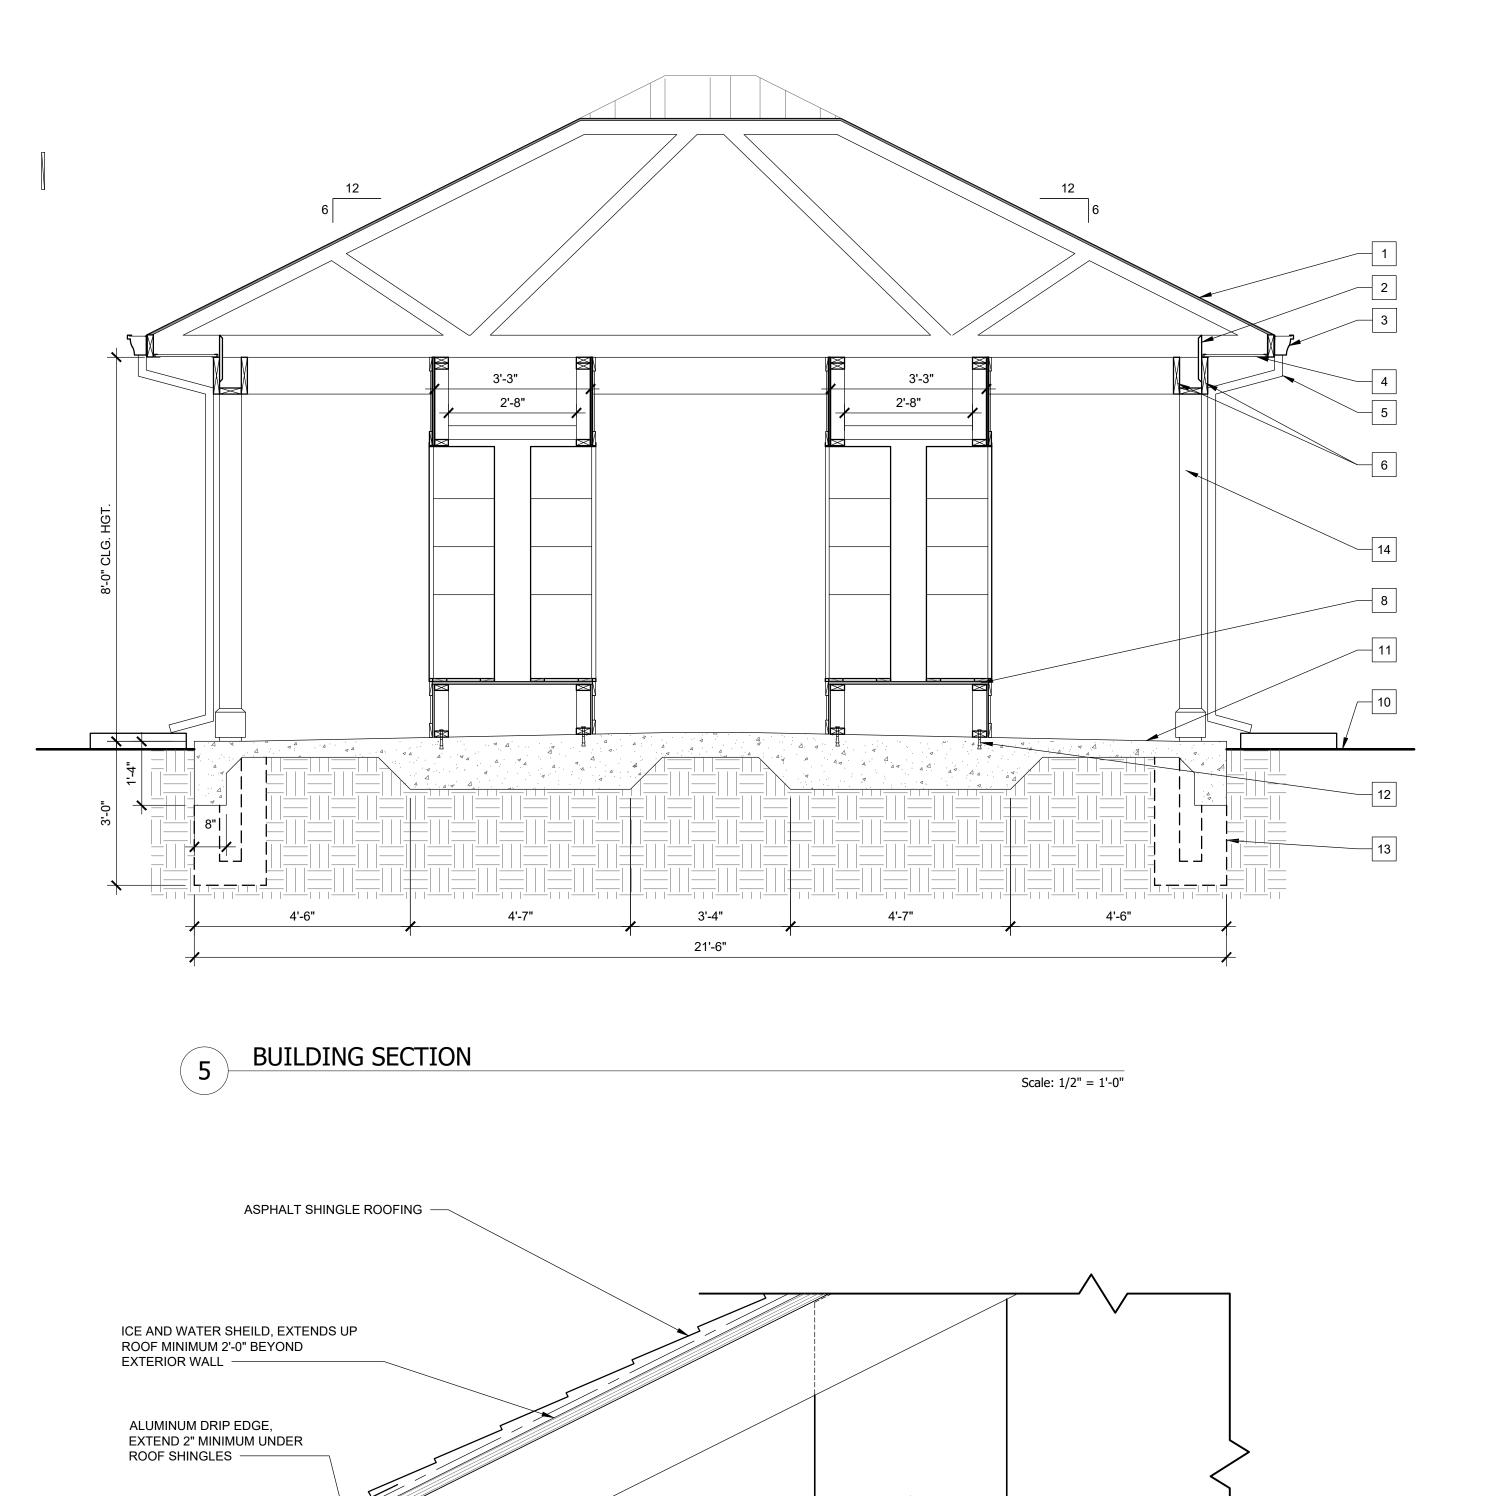

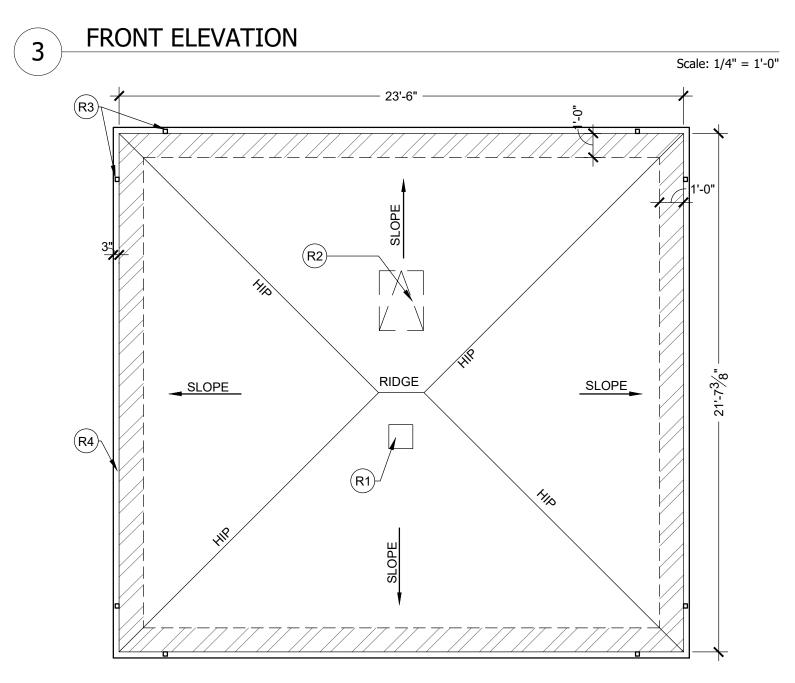

Scale: 1/4" = 1'-0"

Scale: 1/4" = 1'-0"

GENERAL FLOOR PLAN NOTES:

A. SEE TYPICAL PLAN SHEETS FOR GENERAL NOTES.

GENERAL ELEVATION NOTES:

A. SEE TYPICAL ELEVATION SHEETS FOR GENERAL NOTES.

B. MATCH MATERIALS OF PRIMARY STRUCTURE UNLESS SPECIFICALLY NOTED OTHERWISE.

ELEVATION KEYED NOTES:

- A. ARCHITECTUREAL ASPHALT SHINGLES, MATCH PRIMARY STRUCTURE.
- C. ALUMINUM DOWNSPOUT

B. ALUMINUM GUTTER

- D. 2X10 BEAM EACH SIDE OF POST THRU BOLTED W/ (3) $\frac{1}{2}$ " DIAMETER BOLTS AT EACH POST.
- E. FIBER CEMENT SIDING. F. FIBER CEMENT TRIM 5/4" X 6".
- G. 8"X8" REAL POST, SMOOTH
- H. 4" CONC. SLAB W/ 6X6X10 W.W.F. ON 4" COMPACTED FILL
- I. SPLASH BLOCK. J. GRADE
- K. PRECAST CONCRETE CAP STONES. L. MASONRY - MATCH PRIMARY STRUCTURE.

SECTION KEYED NOTES:

- SHINGLES ON PRE-ENGINEERED ROOF TRUSS @ 24" O.C. MATCH
- PRIMARY STRUCTURES.

Scale: 1/4" = 1'-0"

- 2. ROOF TRUSS TIE DOWNS CLIPS. 3. ALUMINUM GUTTER W/DRIP.
- 4. PERFORATED VINYL SOFFIT AT PERIMETER. 5. ALUMINUM DOWNSPOUT, BEYOND.
- 6. 2x10 SMOOTH CEDAR BEAM EACH SIDE OF POST THRU BOLTED W/(3), 1/2"\DIAMETER BOLTS AT EACH POST, PROVIDE INTERMEDIATE BLOCKING PROJECT TITLE
- 7. 14"X14" RS CEDAR POST.
- 8. PRESSURE TREATED $\frac{3}{4}$ " OSB W/2X BLOCKING AS REQ'D.
- 9. PRESSURE TREATED 2x6 @ 16" O.C. W/ 7/16" OSB AND BUILDING WRAP. 10.LINE OF GRADE, SEE CIVIL
- 11.4" CONCRETE SLAB W/ 6X6X10 W.W.F. ON 4" COMPACTED FILL. SEE STRUCTURAL.
- $12.\frac{1}{2}$ " DIA. ANCHOR BOLTS @48"O.C. 12" MAX. FROM ENDS.
- 13.1'-6" DIAMETER CONC. PIER. 14.8"X 8" REAL POST.
- 15.2X6 SMOOTH CEDAR (SOFFIT) FLUSH WITH BOTTOM OF BEAMS. 16.MASONRY - MATCH PRIMARY STRUCTURE.

(RX) ROOF PLAN KEYED NOTES:

- (R1) ROOF VENT, 144 SQ. INCHES FREE AREA, MIN.
- (R2) ATTIC ACCESS W/LOCK
- (R3) DOWNSPOUT LOCATION
- (R4) ALUMINUM GUTTER W/ DRIP

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EXTERIOR MATERIAL LEGEND

COMPOSITION ROOF

STANDING SEAM METAL ROOF

FIBER CEMENT SIDING

BRICK VENEER

REVISIONS MARK DESCRIPTION (NOT ALL RATING LINE TYPES ARE NECESSARILY USED IN THIS PROJECT

PERMIT SET- STATE CDR CITY ARC COMMENTS

LOAD BEARING WALL OVERLAY REFER TO STRUCTURAL DRAWINGS FOR LOCATIONS. 30 MINUTE RATED "FIRE PARTITION". AT CORRIDORS.

SPECIFIC ASSEMBLY REQUIREMENTS.

ELEMENTS IN ACCORDANCE WITH TABLE 601.

1 HR RATED "FIRE PARTITION". WALL EXTENDS FROM RATED ASSEMBLY TO RATED ASSEMBLY. 1 HR RATED "FIRE BARRIER". WALL EXTENDS THROUGH INTERSECTING ASSEMBLIES.

2 HR RATED "FIRE BARRIER". WALL EXTENDS THROUGH INTERSECTING ASSEMBLIES. 2 HR RATED "FIRE WALL" CONTINUOUS WITHOUT INTERRUPTION.

 SEE STRUCTURAL FOR ALL SHEAR WALL LOCATIONS. SEE WALL ASSEMBLY ON G030 AND G040 SERIES SHEETS FOR

RATED WALLS INSIDE UNITS ARE FIRE RATED DUE TO CONSTRUCTION TYPE OF BUILDING AND FIRE RATING REQUIRED FOR CERTAIN

PARCEL BOXES SHEET NUMBER

DRAWN BY: BP

CHECKED BY: BP

SHEET TITLE

MAIL KIOSK DETAILS

140 MAIL BOXES, 28