

#### **Exhibit B**

#### Statement of Intent

The proposed development of 8.69 acres along N. Kensington Avenue is comprised of 128 multifamily units, made up of 1 and 2-bedroom apartment units. The development will consist of eight, 2-story apartment buildings and a clubhouse with leasing offices, tenant amenities, and a pool. The property will have surface parking available to all tenants, as well as private garages for lease. The exterior of the buildings is proposed to be a combination of masonry and fiber cement lap and panel siding. Based on the current PUD, overlay, and zoning requirements, the below variances are being requested:

#### 1. Parking Variance:

Current zoning requires 2.5:1 parking ratio, requiring the development to maintain 320 parking spaces. Based on regional and national multifamily parking statistics, we are requesting a reduction in the current parking requirement from 2.5:1 to 2.0:1 to have a minimum available parking of 256 spaces. Based on data provided by the National Apartment Association (NAA) the average garden style multifamily development maintains a 1.50:1 parking ratio. We believe, based on national data, as well as our own data from existing properties, that a parking reduction from 2.5:1 to 2.0:1 will provide adequate parking spaces for the property. Site plan with current parking shown in Exhibit E.

#### 2. 100% First Floor Masonry – Apartment Buildings Variance:

The Gateway Crossing PUD requires all multifamily structures to have 100% masonry across the first floor with the exception of bays, windows, and doors. We request relief from the requirement in select locations (shown in Exhibit C), primarily located at unit entry, first floor patio areas, and utility rooms not facing Kensington Avenue. We believe the deviation from first floor masonry in these select locations gives texture and depth to the elevation of the building.

#### 3. <u>Clubhouse – 50% Masonry on sides facing adjacent properties:</u>

The McCordsville Overlay and Architectural Standards require all clubhouse sides facing adjacent properties to maintain 50% Masonry. We request a variance for relief of the 50% requirement on the south and east facing sides of the clubhouse. We request a reduction from 50% to 40% on the south facing side and a reduction from 50% to 45% on the east facing side of the building. (Exhibit D)

#### **EXHIBIT C**

#### **Building A**

Request for relief of masonry requirement at location shown below. Inset balconies at the rear of the buildings, utility closets at end of buildings (non-Kensington facing utility closets), storage closets at rear first floor balconies, and unit entry points at front of buildings.



#### **Building B**

Request for relief of masonry requirement at location shown below. Inset balconies at the rear of the buildings, utility closets at end of buildings (non-Kensington facing utility closets), storage closets at rear first floor balconies, and unit entry points at front of buildings.



#### **Exhibit D**


#### Clubhouse

Request for relief of 50% Masonry requirement for sides facing adjacent properties. The south and east facing sides of the clubhouse are designed with less than the 50% masonry requirement for sides facing adjacent properties. The south facing side is comprised of 40% masonry and the east, pool facing side is comprised of 45% masonry.

#### East: (pool facing side)




#### South facing side:

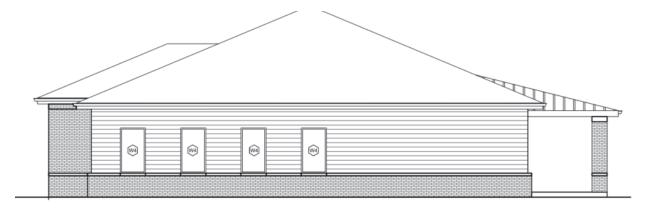

Scale: 3/16" = 1'-0"

3 CLUBHOUSE ELEVATIONS - REAR

#### Aerial of Clubhouse:

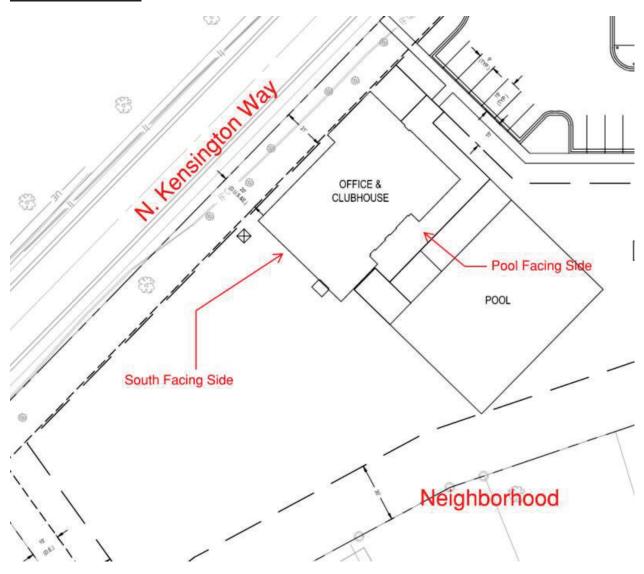


#### **Exhibit E**

#### **Parking Reduction:**


Request for parking reduction from the 2.5:1 to 2.0:1 parking ratio. The current site plan accounts for 270 parking spaces between garage and surface spaces. This number could slightly decrease as we coordinate with utility companies, but we will maintain the minimum of 2.0:1 parking plus additional spaces for the leasing office and guests.

Type	Quantity	
ADA	17	
Standard	193	
Garage	60	
Total	270	

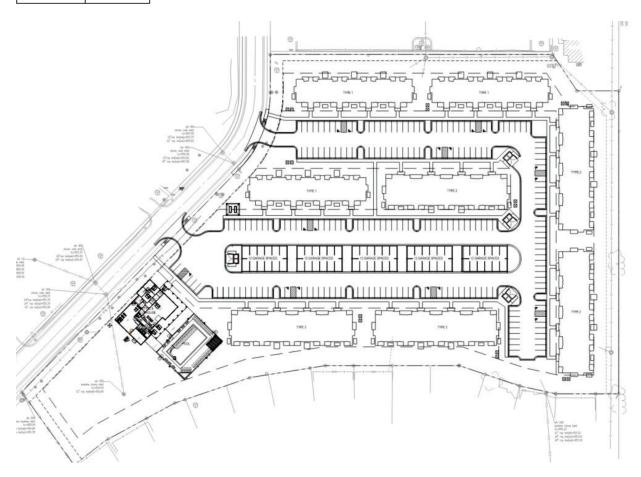

# KENNSINGTON WAY MCCORDSVILLE, IN 46055



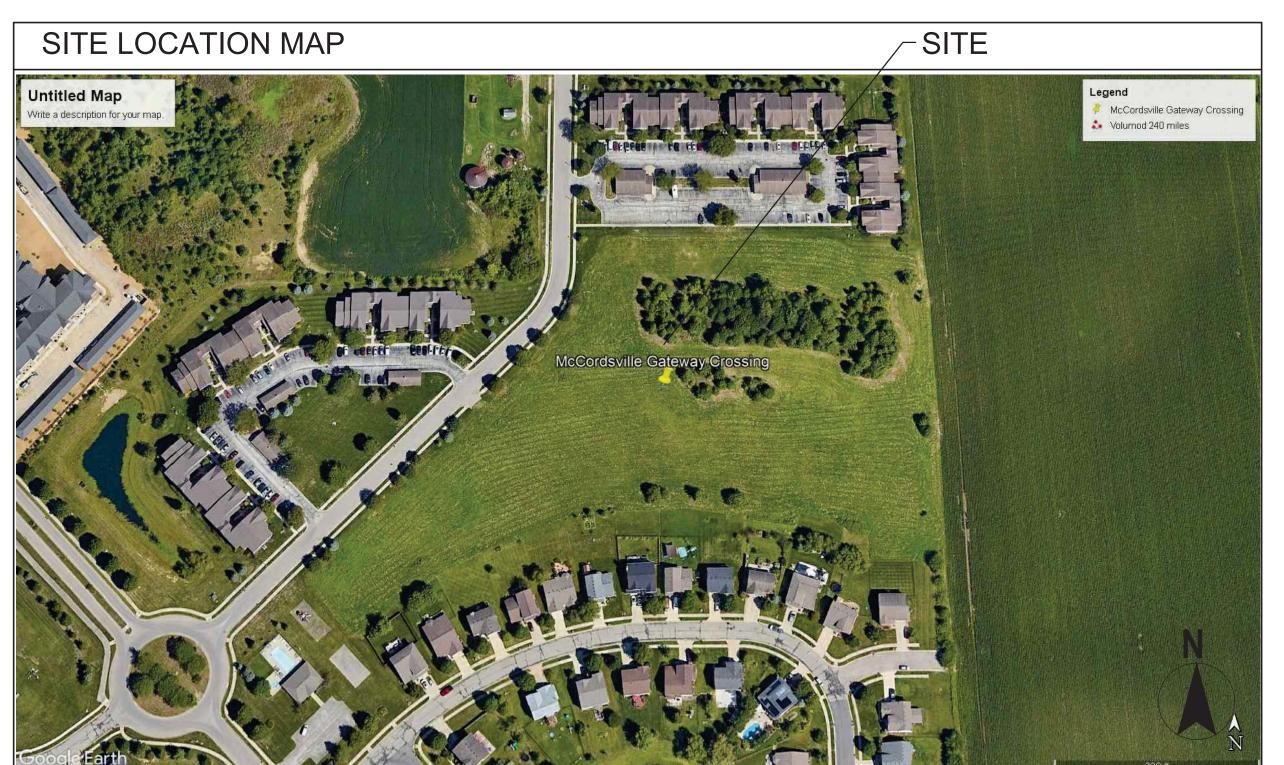



## **PROJECT TEAM**

#### **DEVELOPER:**

## THE RIDGE GROUP

TYLER BOWERS 3225 S. HOYT AVENUE MUNCIE, IN 47302

## ARCHITECT:



BILLY@R3BARCHITECTURE.COM

#### STRUCTURAL ENGINEER

## CONSULTING JPS CONSULTING ENGINEERS

9365 COUNSELORS ROW INDIANAPOLIS, IN 46240 PHONE: 317-503-0447 jburke@jpsconsultingengineers.com

## **MECH., PLUMBING & ELEC. ENGINEER:**

# LATIMER SOMMERS & ASSOC. 3639 SW SUMMERFIELD DR. TOPEKA, KS 66614 CONTACT: DAVID EVERHART

## CIVIL ENGINEER:

#### **STANTEC**

5778 WEST 74TH STREET INDIANAPOLIS, IN 46278-1754 MICHAEL KING MICHAEL.KING@STANTEC.COM

#### LANDSCAPE

#### STANTEC

5778 WEST 74TH STREET INDIANAPOLIS, IN 46278-1754 MICHAEL KING 317-879-8902 MICHAEL.KING@STANTEC.COM

## **CONSTRUCTION:**

## THE RIDGE GROUP

BRITTANY OLMSTEAD 3225 S. HOYT AVENUE MUNCIE, IN 47302 BOLMSTEAD@RIDGECORPORATION.COM

## INTERIOR DESIGNER:

## KELSEY PARKISON, NCIDQ

2325 N. DELAWARE ST INDIANAPOLIS, IN 46205 CONTACT: KELSEY PARKISON PHONE: 219-851-0192 KELSEYPARKISON@GMAIL.COM



3225 S. HOYT AVENUE MUNCIE, IN 47302 765-282-3778



INDIANAPOLIS, IN 46202 BILLY@R3BARCHITECTURE.COM 574-850-2270

PROGRESS **PRINT** 


PROJECT TITLE

**REVISIONS** MARK DESCRIPTION

DRAWN BY: BP

CHECKED BY: BP

COVER

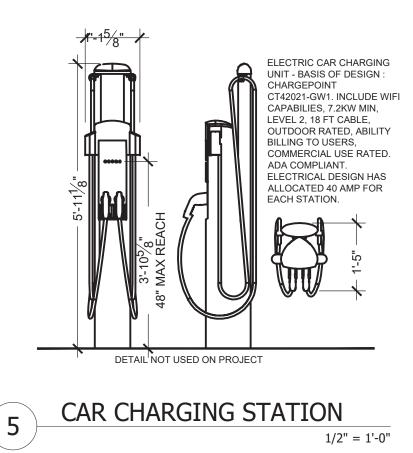

5'-0"

BIKE RACK "B"

14'-8"

CONCRETE PAD SHALL BE DESIGNED TO WITHSTAND

10,000#/ WHEEL AXLE LOAD. 10" CONCRETE W/ #4 BAR @12" O.C.

EQ


FOUNDATION DETAIL.

4'-0"

3'-0"


16'-0"


4'-0"

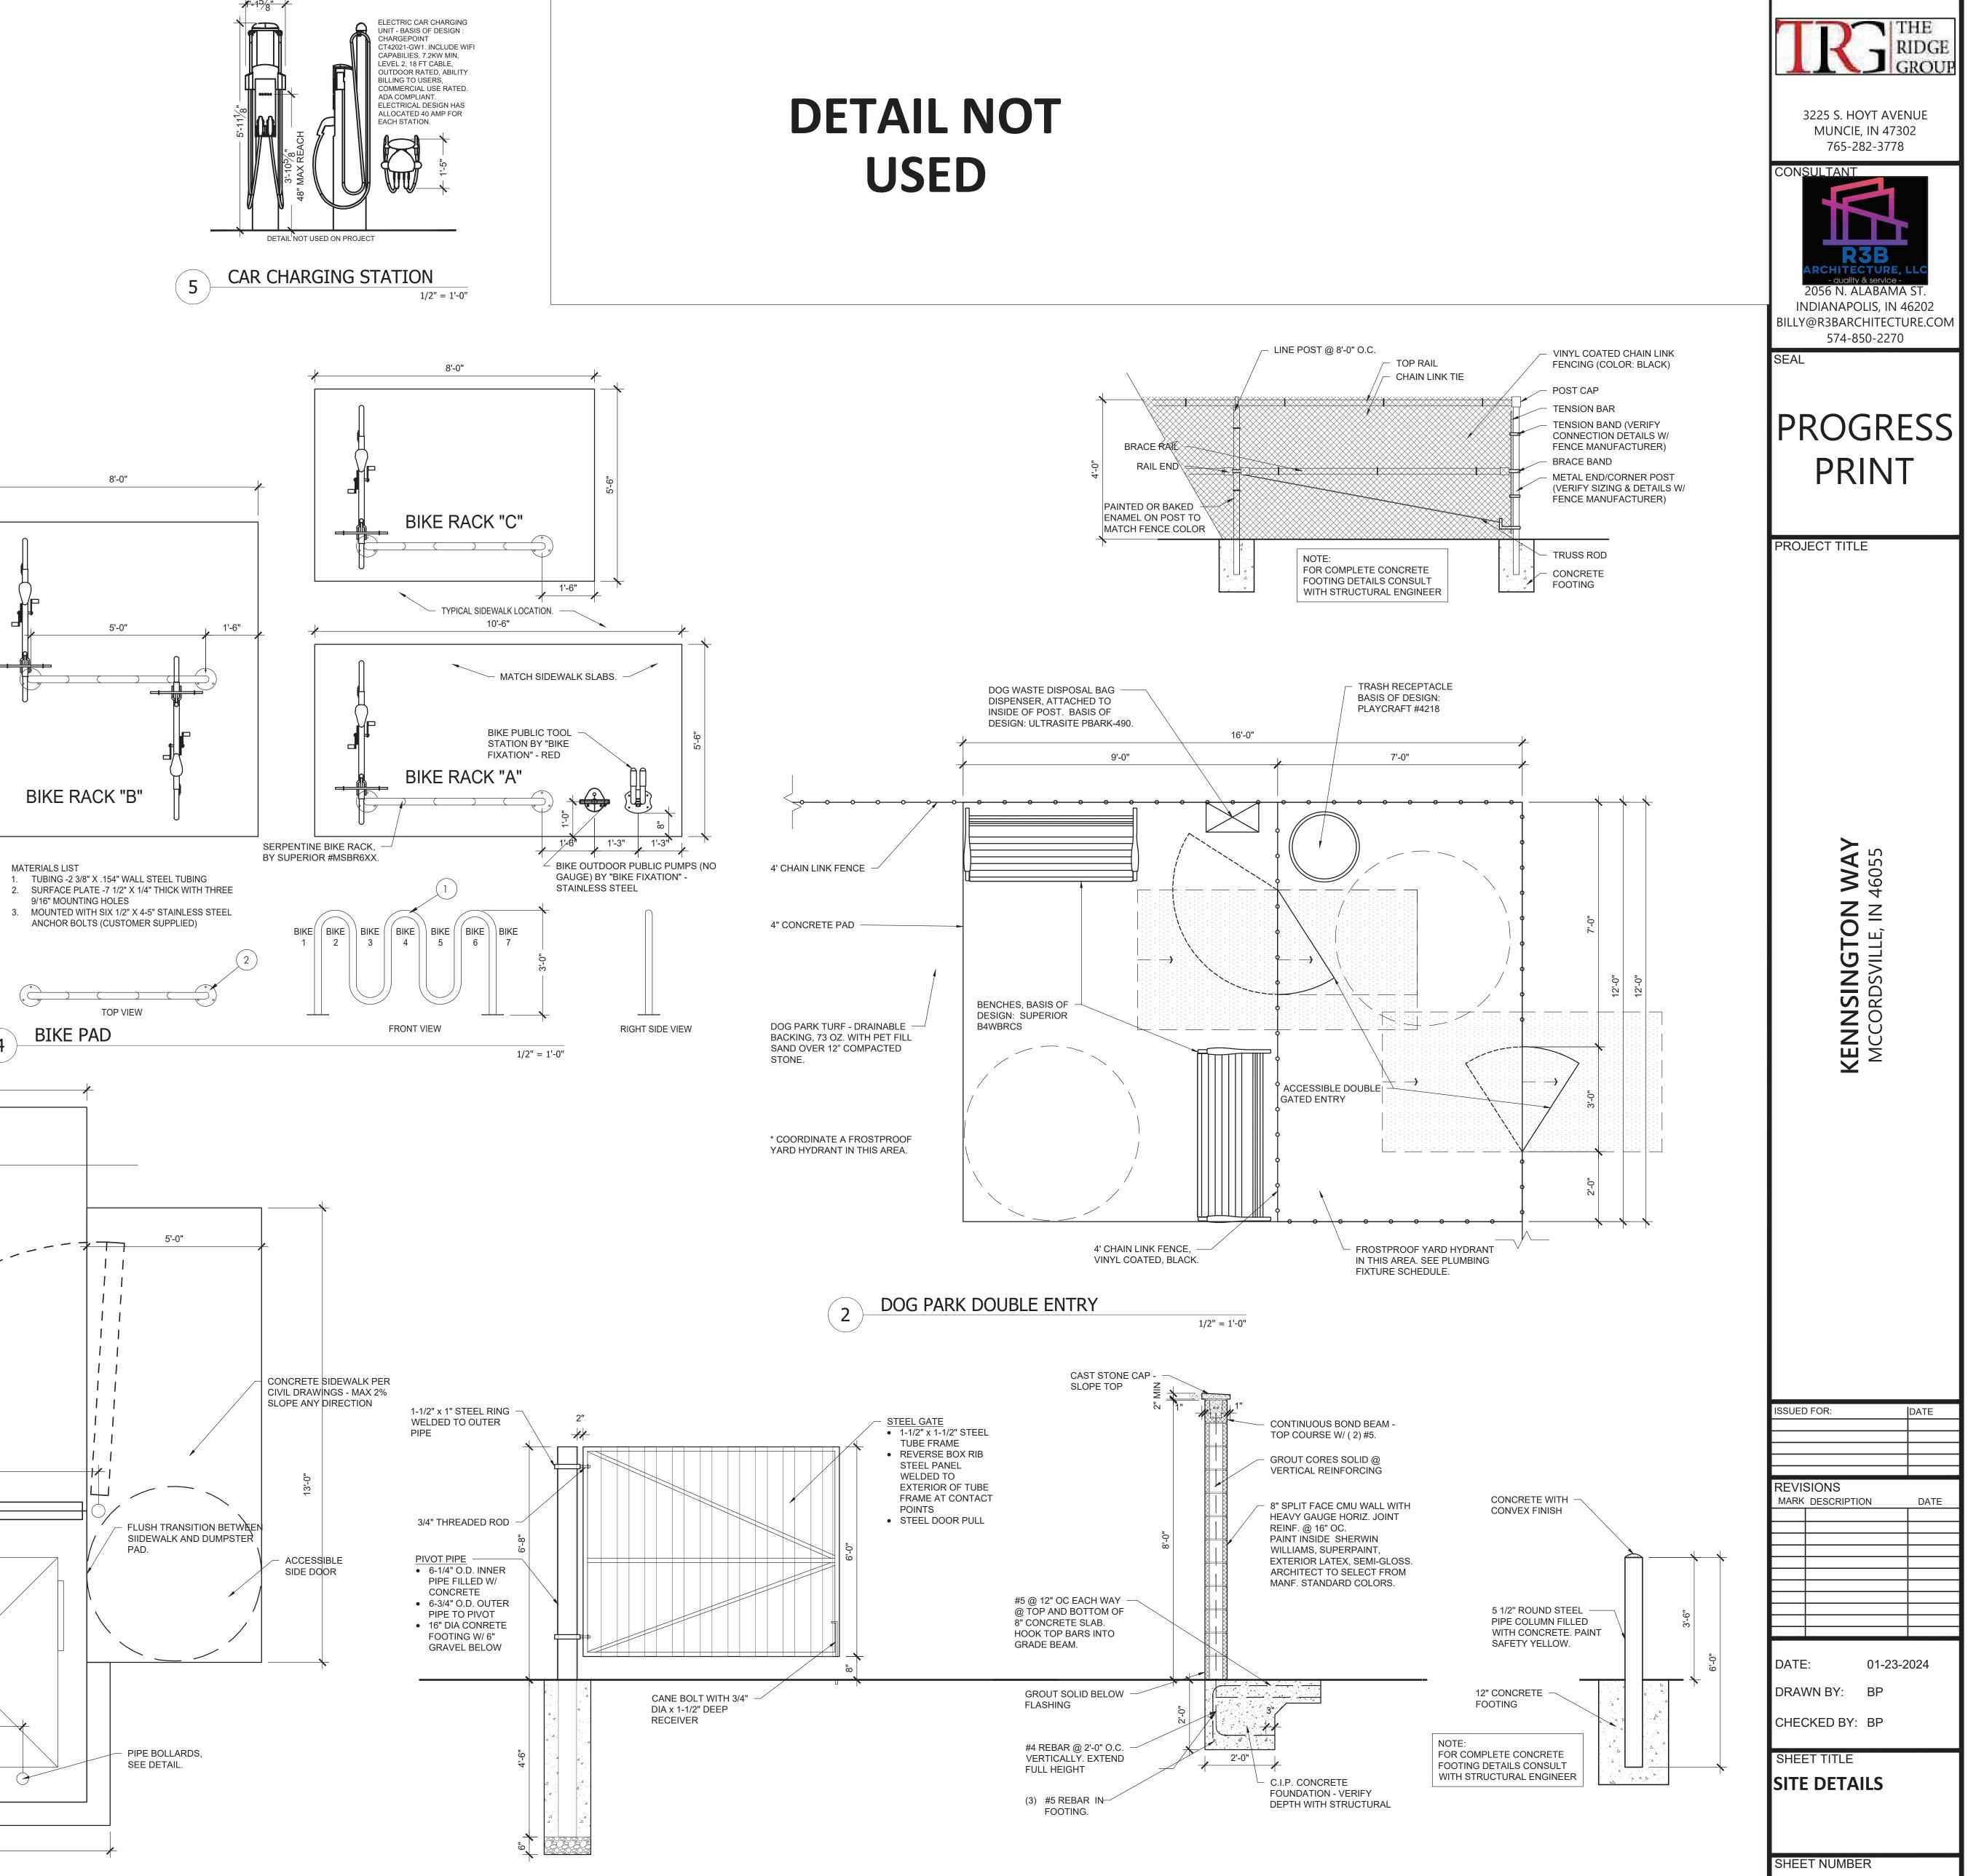


1 DUMPSTER ENCLOSURE

1/2" = 1'-0"

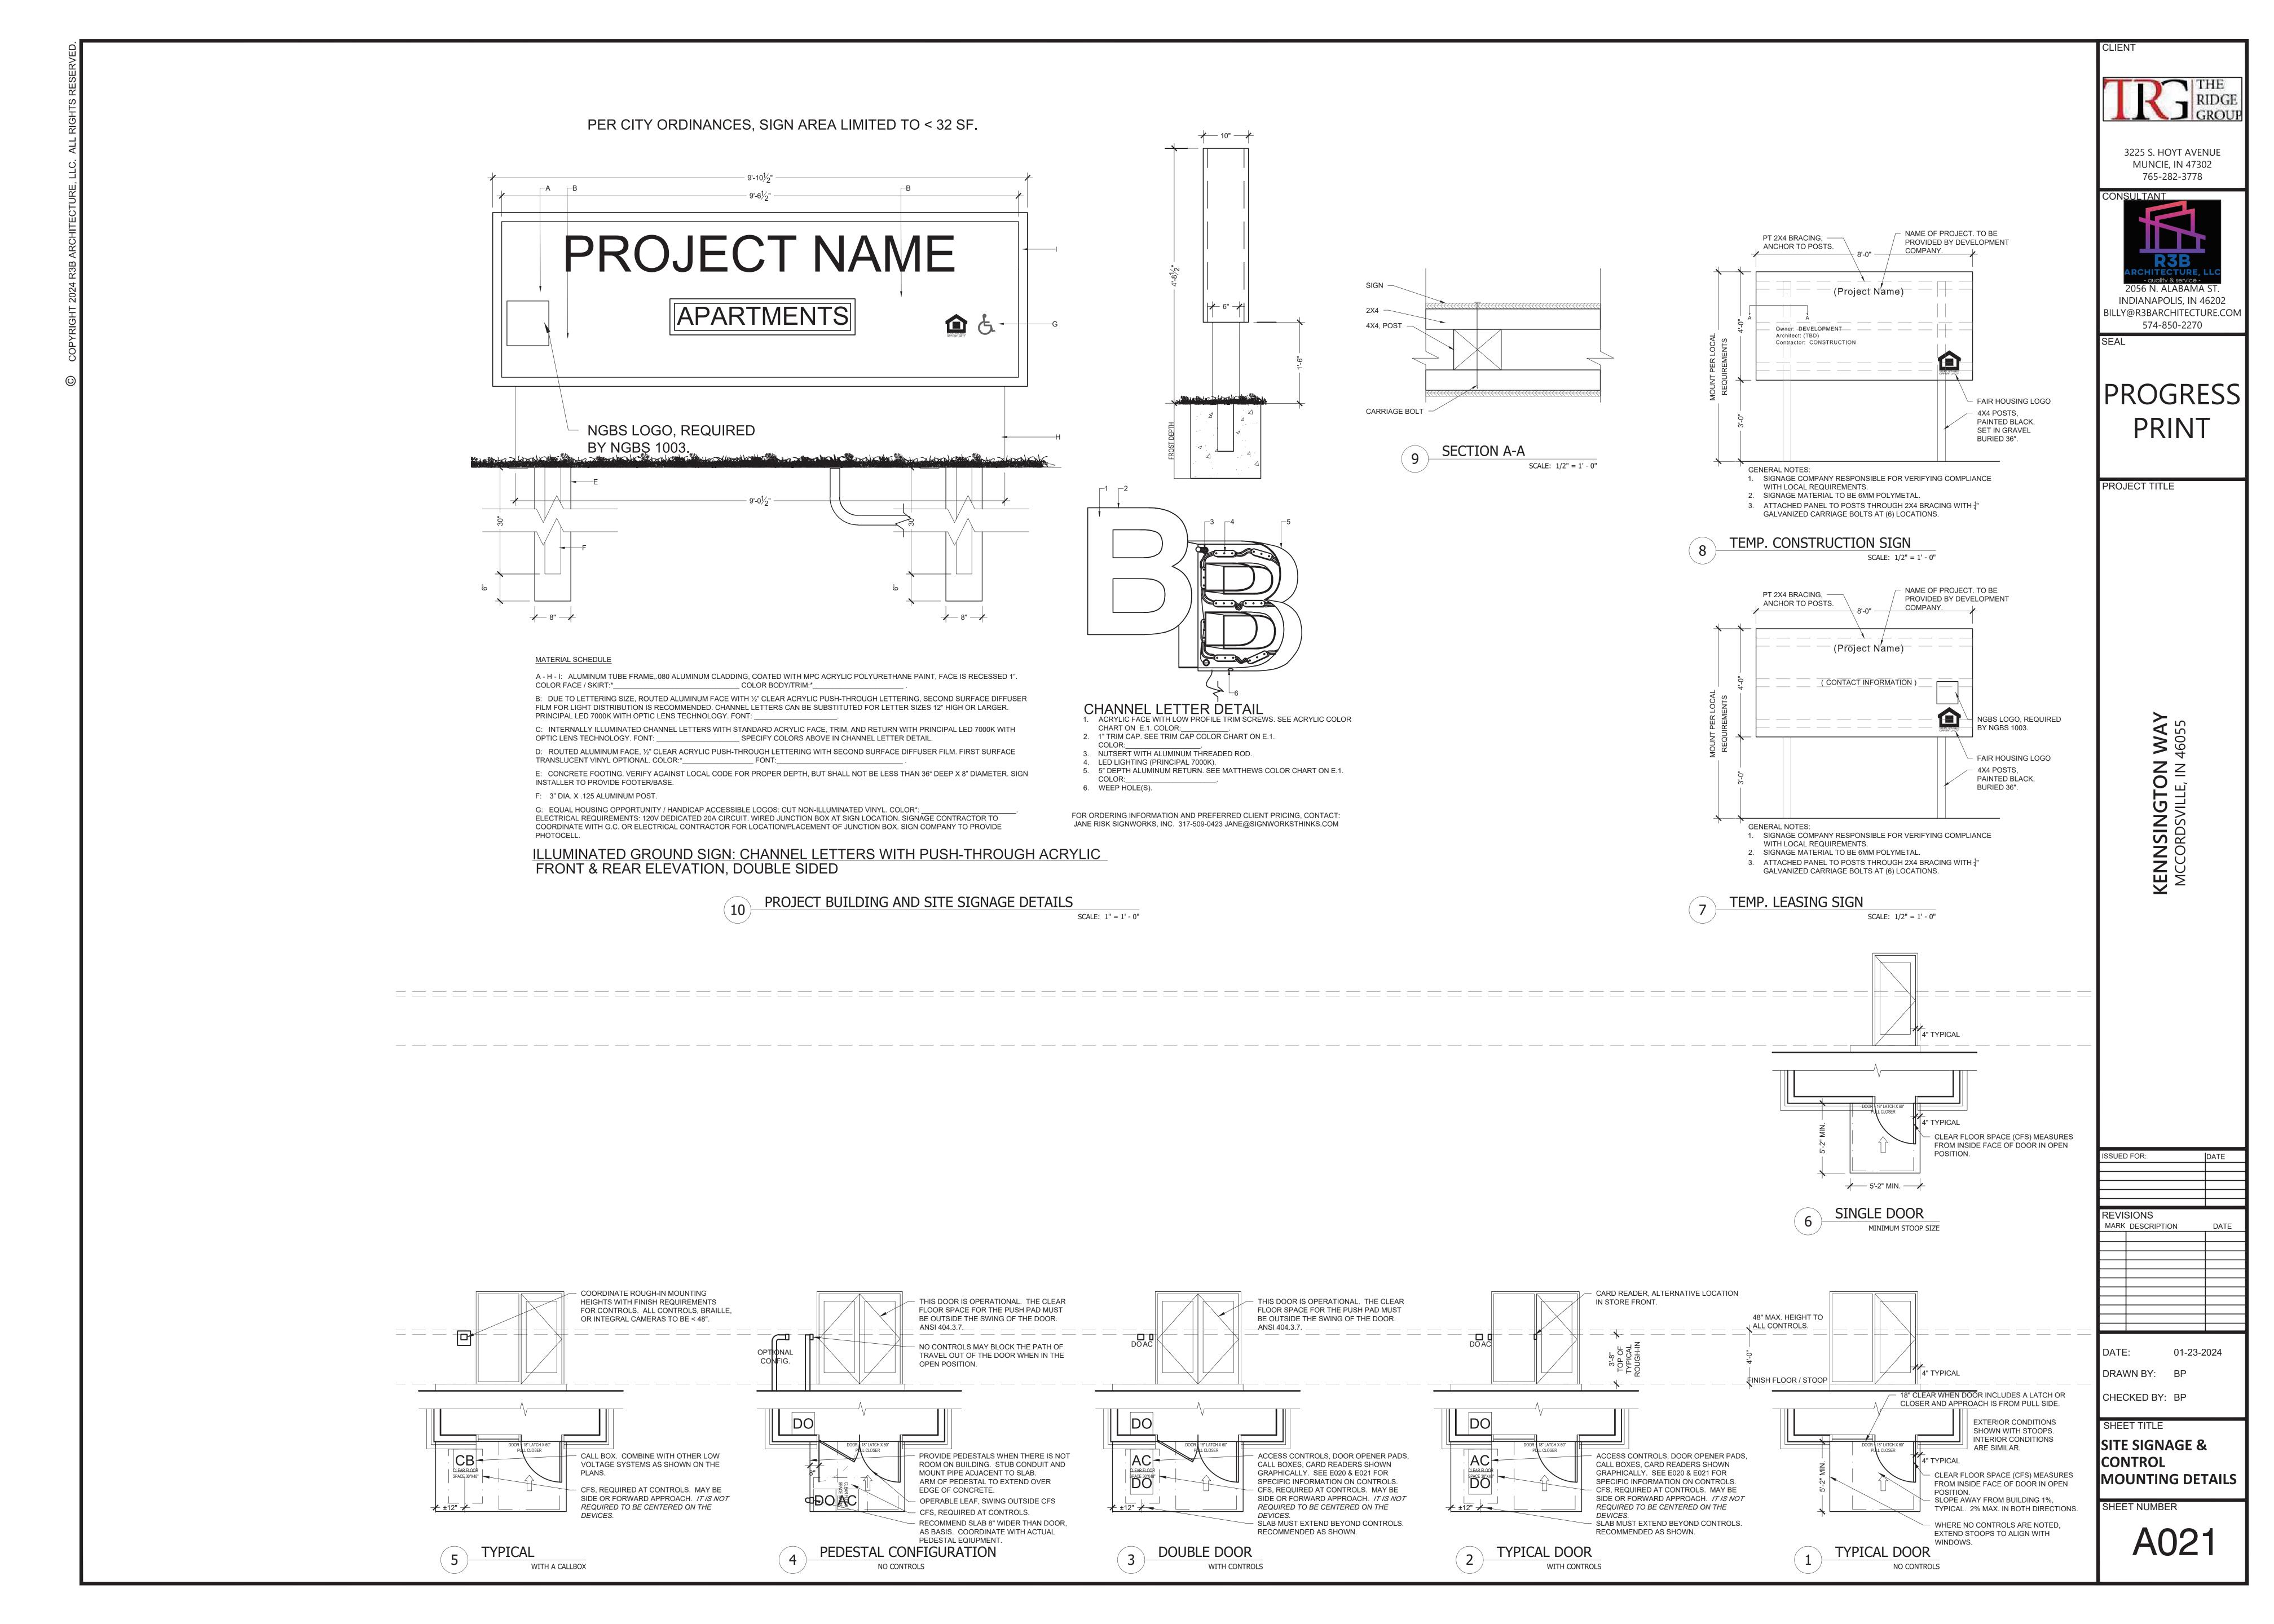

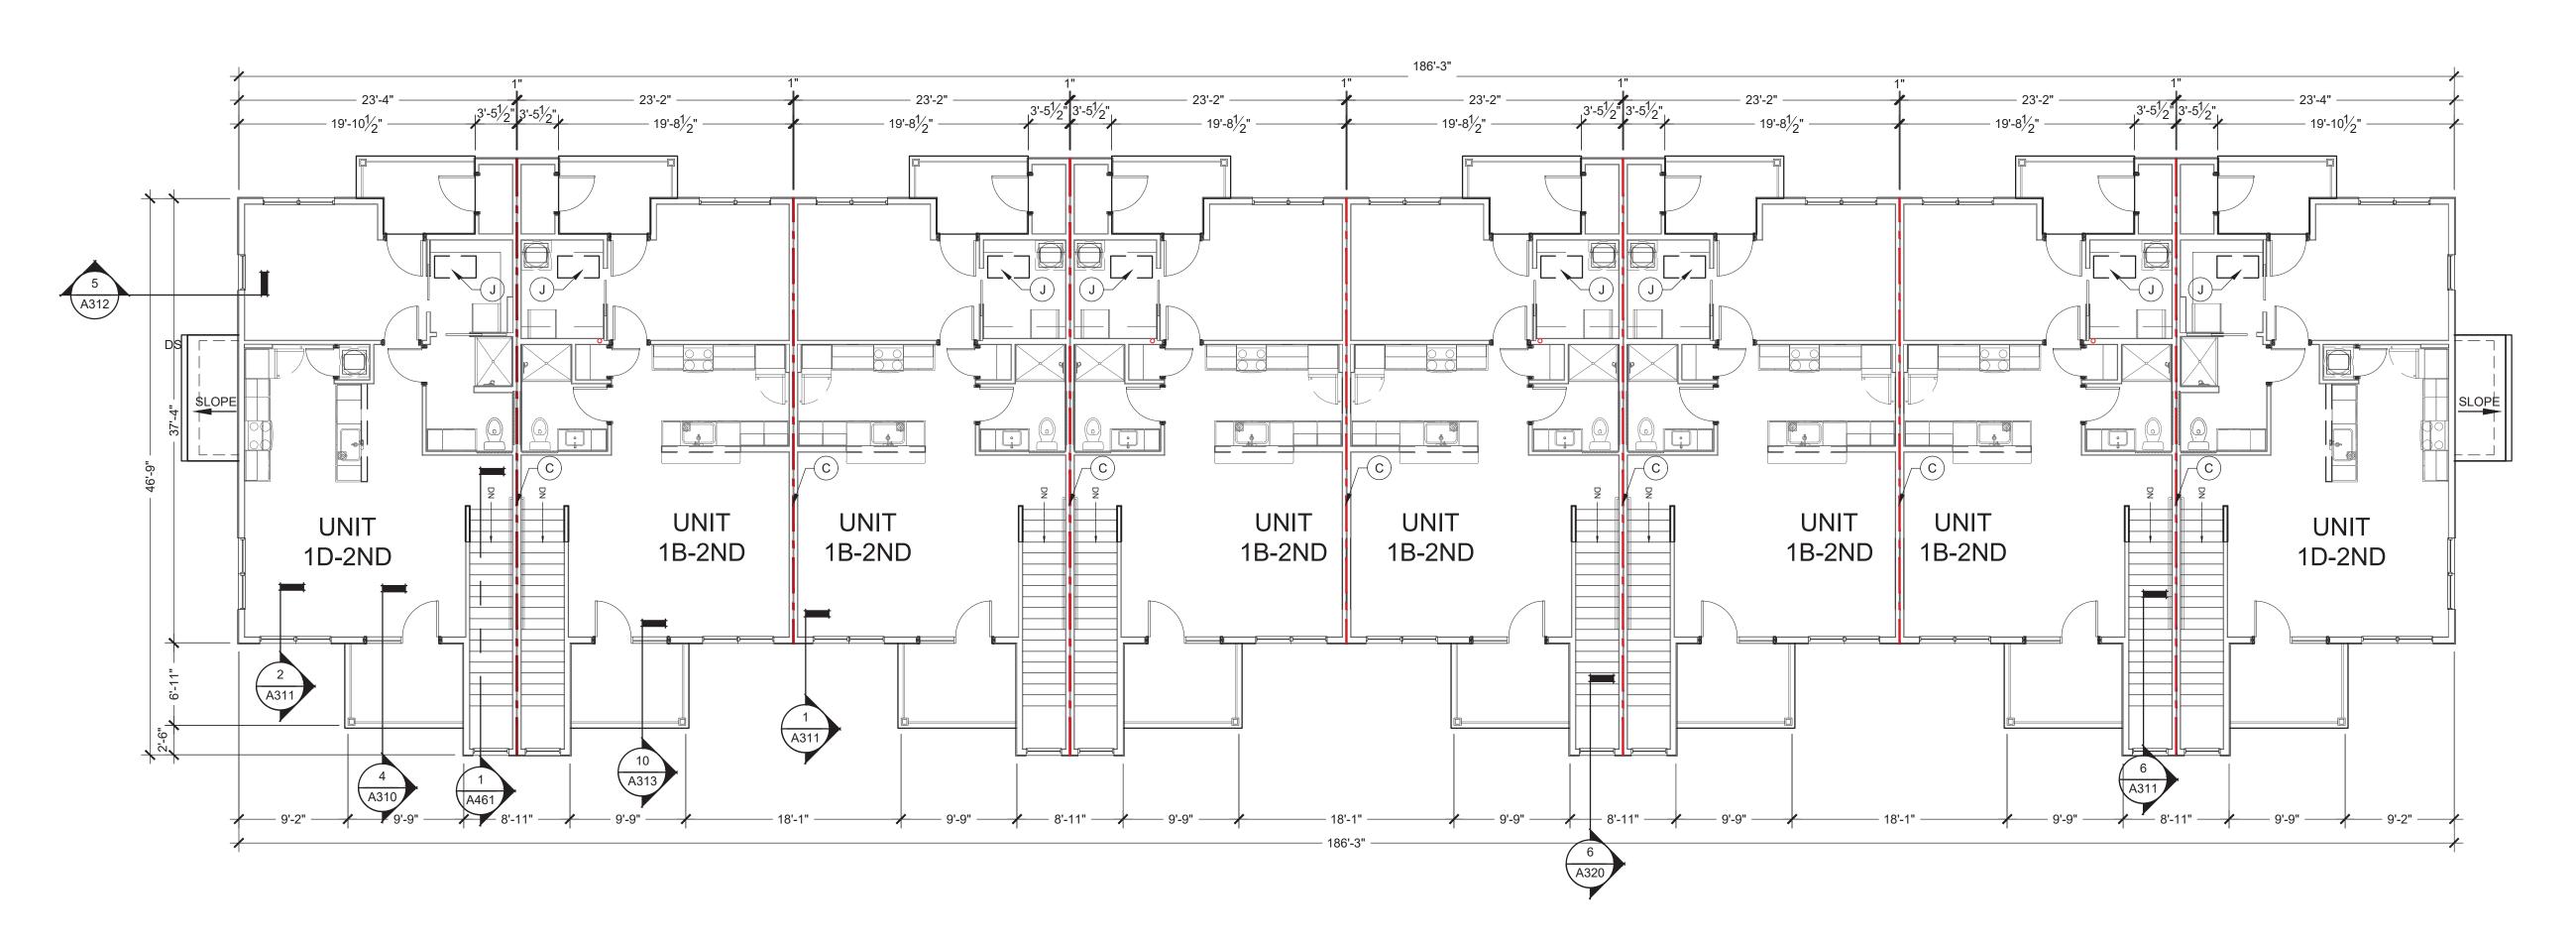

FLOOR PLAN BUILDING TYPE-A - LEVEL 2

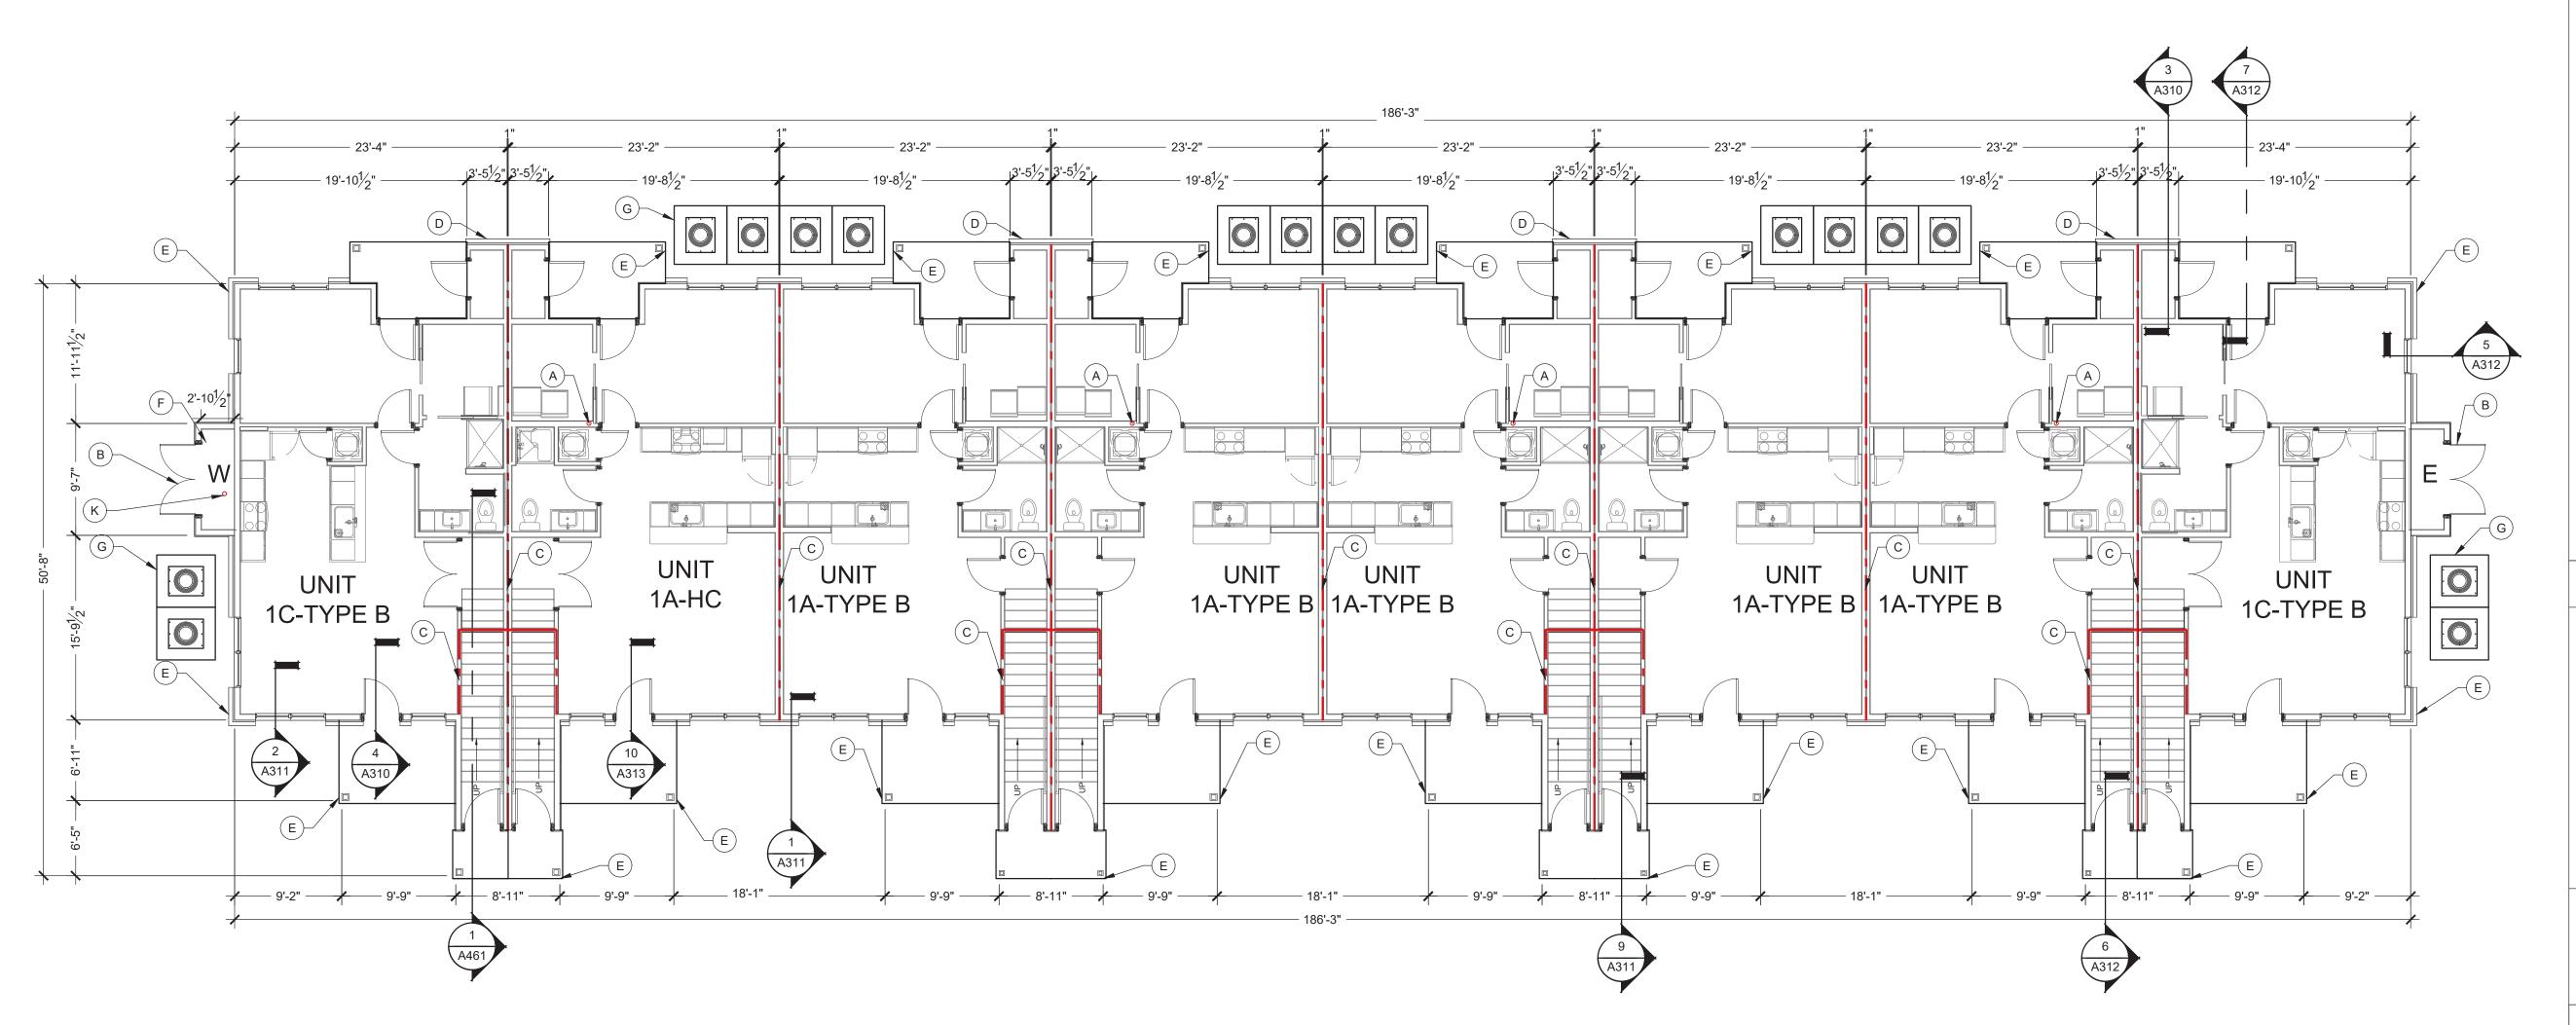

FLOOR PLAN BUILDING TYPE-A - LEVEL 1

**GENERAL FLOOR PLAN NOTES** 

1. FLOOR TRUSSES ARE TO BE POSITIONED SO THEY DO NOT INTERFERE WITH PLUMBING AND HVAC, ADJUST SPACING AS NECESSARY. REFER TO SPECIFICATIONS AND STRUCTURAL PLANS FOR ADDITIONAL

2. DETAILED FLOOR AND ROOF TRUSS FRAMING DIAGRAMS ARE TO BE FURNISHED BY A STRUCTURAL ENGINEER LICENSED IN THE STATE. 3. ROUGH OPENINGS IN EXTERIOR WALLS SHALL BE UPSIZE APPROXIMATELY 1/2" TO ACCOMMODATE SHRINKAGE AT GROUND FLOOR

OF WOOD BUILDINGS 3-4 STORIES AND GREATER FOR 5 STORIES... 4. ALL DIMENSIONS ARE TO FACE OF STUDS.

5. ALL CONTRACTORS ARE REQUIRED TO COORDINATE THEIR WORK WITH ALL DISCIPLINES TO AVOID CONFLICTS, SEE MECHANICAL, ELECTRICAL AND PLUMBING DRAWINGS FOR ADDITIONAL INFORMATION REGARDING SIZE AND QUANTITY OF OPENINGS, SLAB REQUIREMENTS AND LINTELS. INCLUDE FIRE PROTECTION NOT SHOWN ON PLANS.

6. SEAL AROUND ALL PENETRATIONS TO INSURE TIGHT BUILDING ENVELOPE. SEE A390 AND A391 FOR ADDITIONAL INFORMATION. 7. PROVIDE FIRE SEALANT AROUND ALL PENETRATIONS THROUGH RATED

8. ALL WALLS ARE PAINTED UNLESS NOTED OTHERWISE.

9. COORDINATE BUILDING STEP LOCATIONS WITH FLOOR ELEVATIONS SHOWN ON ARCHITECTURAL AND CIVIL SITE PLANS. 10.PATIO SLOPES SHALL BE 1/4" PER FOOT MAX. AWAY FROM UNIT AND

11.PROVIDE CONTROL JOINTS IN GYPSUM BOARD ASSEMBLIES AS RECOMMENDED BY MANUFACTURER. PROVIDE CJ IN CEILINGS SO NO DIMENSION EXCEEDS 50 FT. IN EITHER DIRECTION WHERE THERE IS PERIMETER RELIEF OR 30 FT. IN EITHER DIRECTION WITHOUT PERIMETER RELIEF. DO NOT SEPARATE SUSPENSION SYSTEM. CAULK SEAL JOINT AND PAINT TO MATCH.

12.REFER TO G100 SERIES DRAWINGS FOR ADDITIONAL INFORMATION ON ACCESSIBILITY. SHEETS ARE INCLUDED FOR REFERENCE ONLY. CONTRACT SHOULD NOT MAKE ADJUSTMENTS TO THE PLANS WITHOUT APPROVAL FROM ARCHITECT.

13.REFER TO ELECTRICAL DRAWINGS AND E307 AND E308 FOR ADDITIONAL INFORMATION AND CLARIFICATION OF DESIGN-BUILD SCOPE FOR ACCESS CONTROLS, SECURITY CAMERAS, DOOR OPERATORS, AND DATA/TV. ICONS AND SYMBOLS SHOWN ON FLOOR PLANS FOR COORDINATION ACROSS DESIGN DISCIPLINES. 14.REFER TO WALL SECTIONS A300 SERIES FOR UL ASSEMBLIES FOR

HORIZONTAL ASSEMBLIES AND EXTERIOR WALL INFORMATION. 15.PROVIDE DEFLECTION CLIPS AT ALL NON-BEARING WALLS WHERE THE WALLS DO NOT STACK VERTICALLY THROUGH THE BUILDING. SEE 6/A540. TYPICAL WHERE UNITS ARE ABOVE AMENITY AREAS. SEE STRUCTURAL SET S310 FOR DETAIL.

16. HANDRAILS AT BALCONIES ON FLOORS 2 AND UP. NOT SHOWN ON FLOOR PLANS. 17. REFER TO A040 FOR MOUNTING DETAILS FOR ACCESS CONTROLS,

DOOR OPENERS, CALL BOXES, AND PEDESTALS AT ENTRY DOORS. 18.REFER TO A510 FOR ADDITIONAL SPRINKLER DETAILS WHERE INSULATION MAY BE REQUIRED BELOW TOP OF ROOF DECK. TO BE COORDINATED WITH FINAL SPRINKLER INSTALLER.

19. REFER TO A531 FOR ADDITIONAL PLAN DETAILS FOR "FIRE WALLS".

20.ALL CORRIDOR WALLS ARE TO BE WALL TYPE 1C1 WITH RC-DELUXE RESILIENT CHANNEL ON THE CORRIDOR SIDE, UNLESS NOTED DIFFERENTLY. SEE STRUCTURAL FOR SHEARWALL LOCATIONS. CORRIDORS ARE NOT USED FOR SHEARWALLS THIS PROJECT. 21.END LIST

## **FLOOR PLAN KEYED NOTES:**

A. RADON VENT. REFER TO G110 FOR ADDITIONAL INFORMATION. B. DOUBLE 36" DOORS, INSULATED, SEE DOOR SCHEDULE #B01. C. 1 HOUR DEMISING WALL.

D. METER CENTER, SEE ELECTRICAL DRAWINGS.

Scale: 1/8" = 1' - 0"

Scale: 1/8" = 1' - 0"

E. DOWNSPOUT, SEE ROOF PLANS FOR MORE INFORMATION. F. SPRINKLER CLOSET, ONLY OCCURS ON ONE END OF BUILDING. SEE ARCHITECTURAL SITE PLAN FOR LOCATION. G. MECHANICAL EQUIPMENT PAD, SEE FOUNDATION PLANS FOR SIZE AN

H. PERFORATED TILE TO BE INSTALLED UNDER CONNECTING WALKWAY AT DOWNSPOUT, SEE SITE PLAN AND CIVIL DRAWINGS FOR LOCATION

CONCRETE MECHANICAL EQUIPMENT PADS, COORDINATE SIZE AND CLEARANCE WITH MECHANICAL EQUIPMENT. J. ATTIC ACCESS AT ALL TOP FLOOR UNITS.SEE DETAIL 6/A521. K. FLOOR DRAIN, SEE PLUMBING.

2056 N. ALABAMA ST

3225 S. HOYT AVENUE

MUNCIE, IN 47302

765-282-3778

CLIENT

INDIANAPOLIS, IN 46202 BILLY@R3BARCHITECTURE.COM 574-850-2270

ROJECT TITLE

KENNSINGTON N MCCORDSVILLE, IN 4

(NOT ALL RATING LINE TYPES ARE NECESSARILY USED IN THIS PROJECT) REVISIONS MARK DESCRIPTION LOAD BEARING WALL OVERLAY REFER TO STRUCTURAL DRAWINGS FOR LOCATIONS.

30 MINUTE RATED "FIRE PARTITION". AT 2 HR RATED "FIRE BARRIER". WALL EXTENDS THROUGH INTERSECTING

1 HR RATED "FIRE PARTITION". WALL EXTENDS FROM RATED ASSEMBLY TO RATED ASSEMBLY. 1 HR RATED "FIRE BARRIER". WALL EXTENDS THROUGH INTERSECTING

EXTENDS THROUGH INTERSECTING ASSEMBLIES. 2 HR RATED "FIRE WALL" CONTINUOUS WITHOUT INTERRUPTION.

DRAWN BY: BP

 SEE STRUCTURAL FOR ALL SHEAR WALL LOCATIONS. SEE WALL ASSEMBLY ON G030 AND G040 SERIES SHEETS FOR

SPECIFIC ASSEMBLY REQUIREMENTS. RATED WALLS INSIDE UNITS ARE FIRE RATED DUE TO CONSTRUCTION TYPE OF BUILDING AND FIRE RATING REQUIRED FOR CERTAIN ELEMENTS IN ACCORDANCE WITH TABLE 601.

LOW VOLTAGE LEGEND

ACCESS CONTROLS DO

SECURITY CAMERA. SEE E020 AND E021 FOR ADDITIONAL INFORMATION.

SEE E307 AND E308 FOR ADDITIONAL INFORMATION.

AUTOMATIC DOOR OPENER СВ INTERCOM CALL BOX

SHEET NUMBER


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OVERALL FLOOR

SHEET TITLE

**PLANS** 

LEVEL 1-2

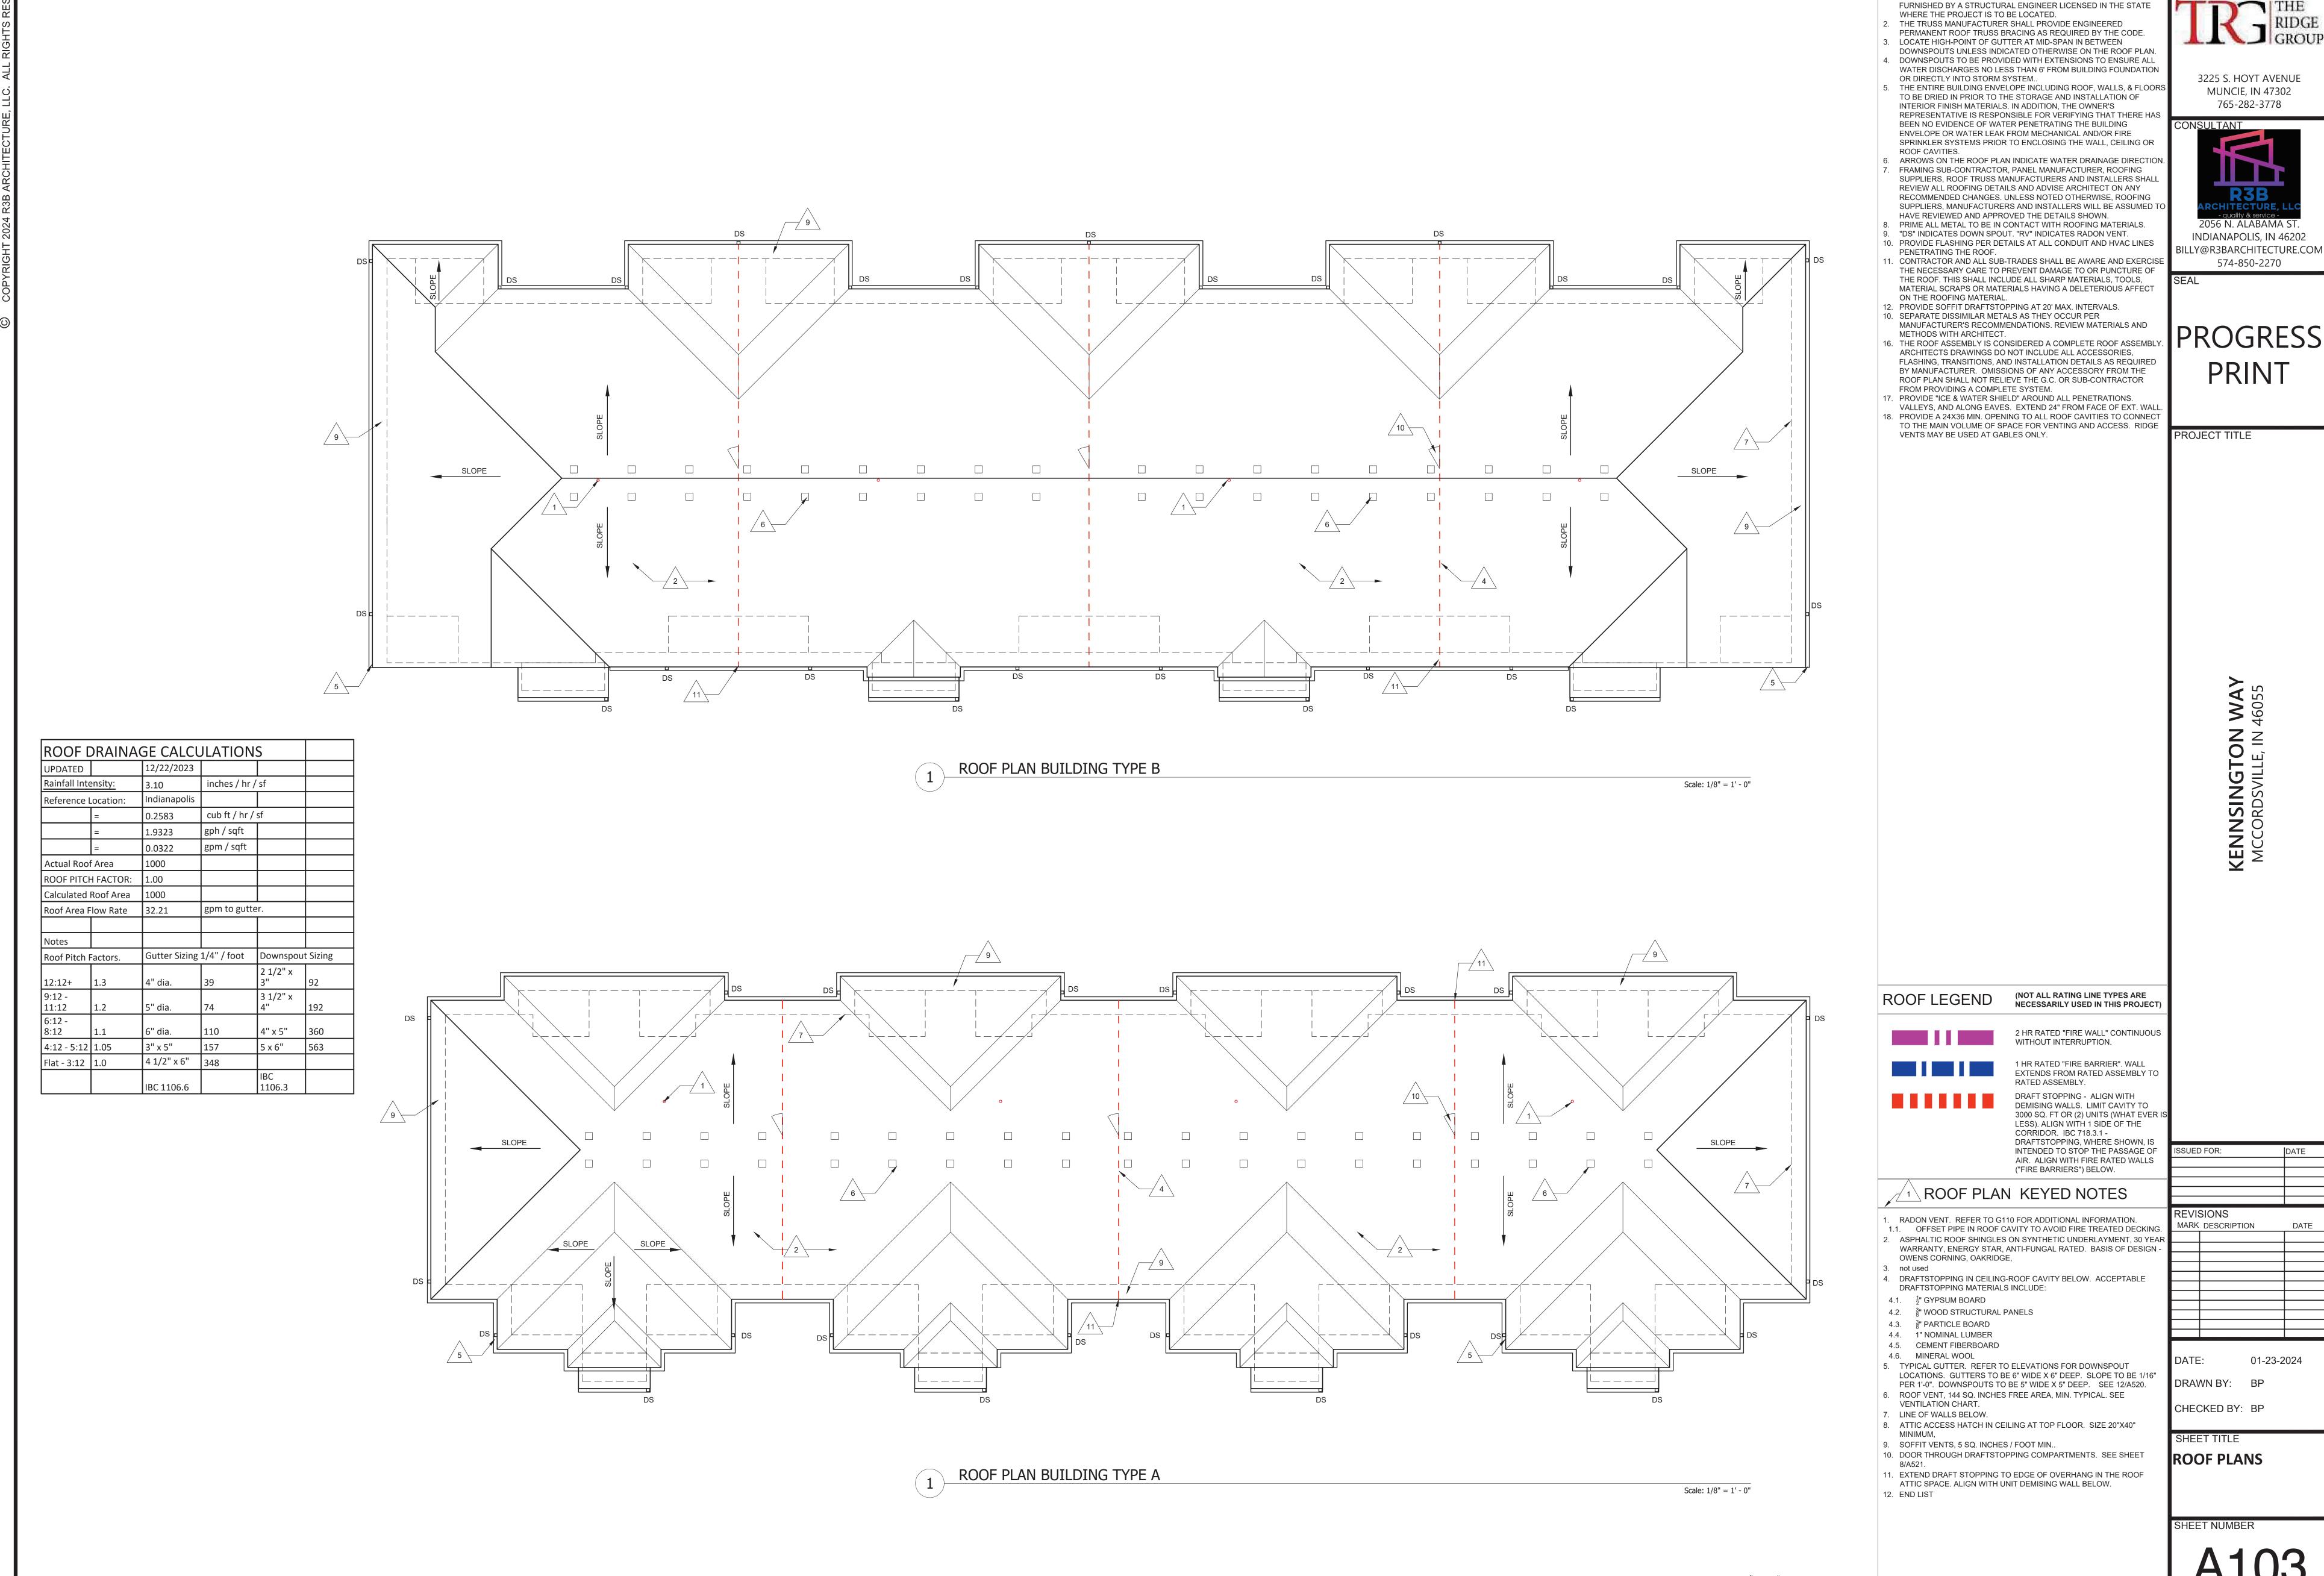

CLIENT

GENERAL NOTES - ROOF PLAN

1. DETAILED FLOOR AND ROOF TRUSS FRAMING DIAGRAMS ARE TO BE





# PROGRESS PRINT

PROJECT TITLE

KENNSINGTON WAY MCCORDSVILLE, IN 46055





		R3B ARCHITECTURE, LLC - quality & service -

ISSUE	FOR:	DATE
REVISIONS		
MARK	DESCRIPTION	DATE
		-

DRAWN BY: BP CHECKED BY: BP

SHEET TITLE
RENDERINGS
TYPE A

SHEET NUMBER





SEAL

# PROGRESS PRINT

PROJECT TITLE

KENNSINGTON WAY MCCORDSVILLE, IN 46055



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CHECKED BY: BP

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RENDERINGS
TYPE B

SHEET NUME

A202





SEAL

## PROGRESS PRINT

PROJECT TITLE

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MARK DESCRIPTION DATE		
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DATE: 01-2

DRAWN BY: BP

CHECKED BY: BP

SHEET TITLE
RENDERINGS
CLUBHOUSE

SHEET NUME

A203



## GENERAL ELEVATION NOTES

- 1. FOUNDATION SHOWN FOR REFERENCES ONLY, SEE STRUCTURAL.
- 2. SEAL ALL PENETRATION WITH SEALANT TO MATCH ADJACENT MATERIALS. 3. SEE ROOF PLANS FOR ROOF SLOPE, DOWNSPOUT, GUTTER AND ROOF VENT INFORMATION.

- GROUND FLOOR ELEVATION AT EACH BUILDING LISTED ON THE CIVIL FINISH

TAG	MATERIAL	COLOR
L1	LAP SIDING, LP SMART SIDING, 7" LAP, PRE-FINISHED.	SNOWSCAPE WHITE
L2	LAP SIDING, LP SMART SIDING, 5" LAP, PRE-FINISHED, 2 TONE WOOD GRAIN BY WOODTONE, RUSTIC SERIES	ROSEWOOD
P1	LP SMARTSIDING SMOOTH PANELS, WITH BLACK ALUM. TRIM.	SNOWSCAPE WHITE
P2	LP SMARTSIDING SMOOTH PANELS, WITH CLEAR ANODIZED ALUM. TRIM.	RAPIDS BLUE
B1	BRICK, TERRE HAUTE, IN.	DOMINO
S1	VERTICAL METAL PANEL HWP 16, PAC CLAD, ALUMINIUM .040",	ANODIC CLEAR

ELECTRIC METER BANK . TRIM OUT AREA FOR METERS AND FINISH

3225 S. HOYT AVENUE

MUNCIE, IN 47302

765-282-3778

2056 N. ALABAMA ST.

INDIANAPOLIS, IN 46202

574-850-2270

PROJECT TITLE

KENNSINGTON WAY MCCORDSVILLE, IN 46055

ISSUED FOR:

REVISIONS

MARK DESCRIPTION

DRAWN BY: BP

CHECKED BY: BP


SHEET TITLE **ELEVATIONS** 


SHEET NUMBER

BILLY@R3BARCHITECTURE.COM





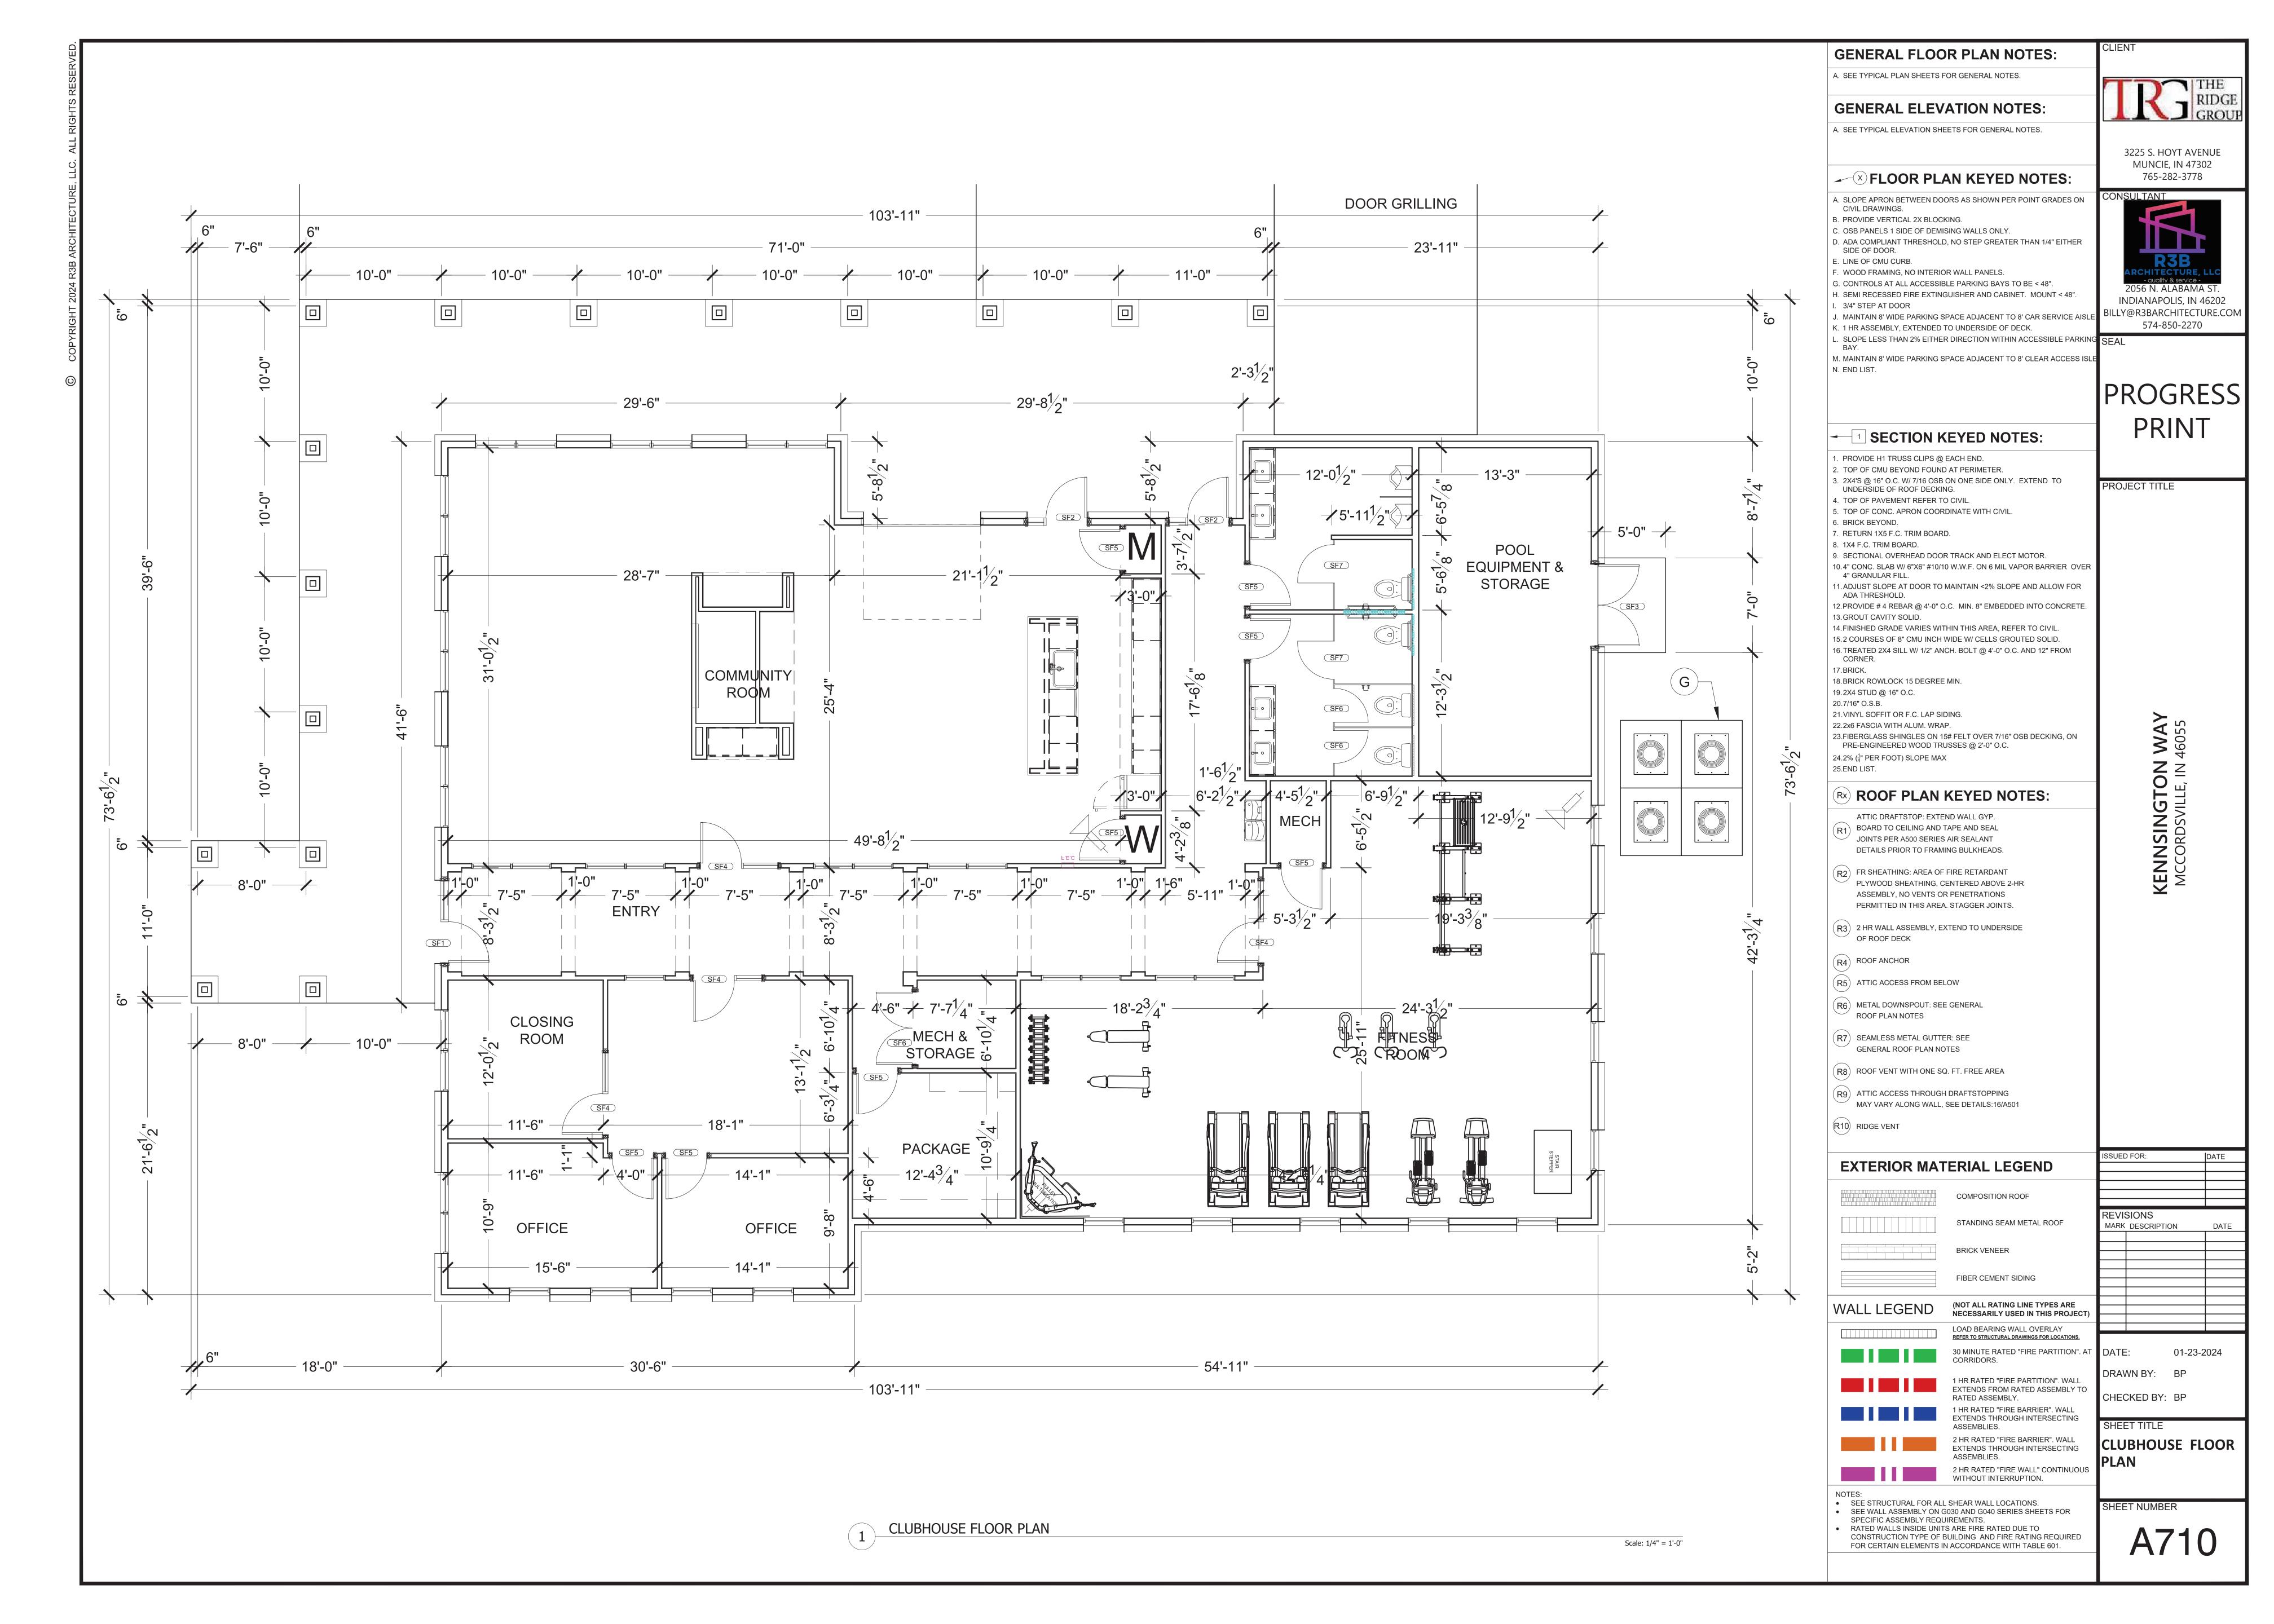

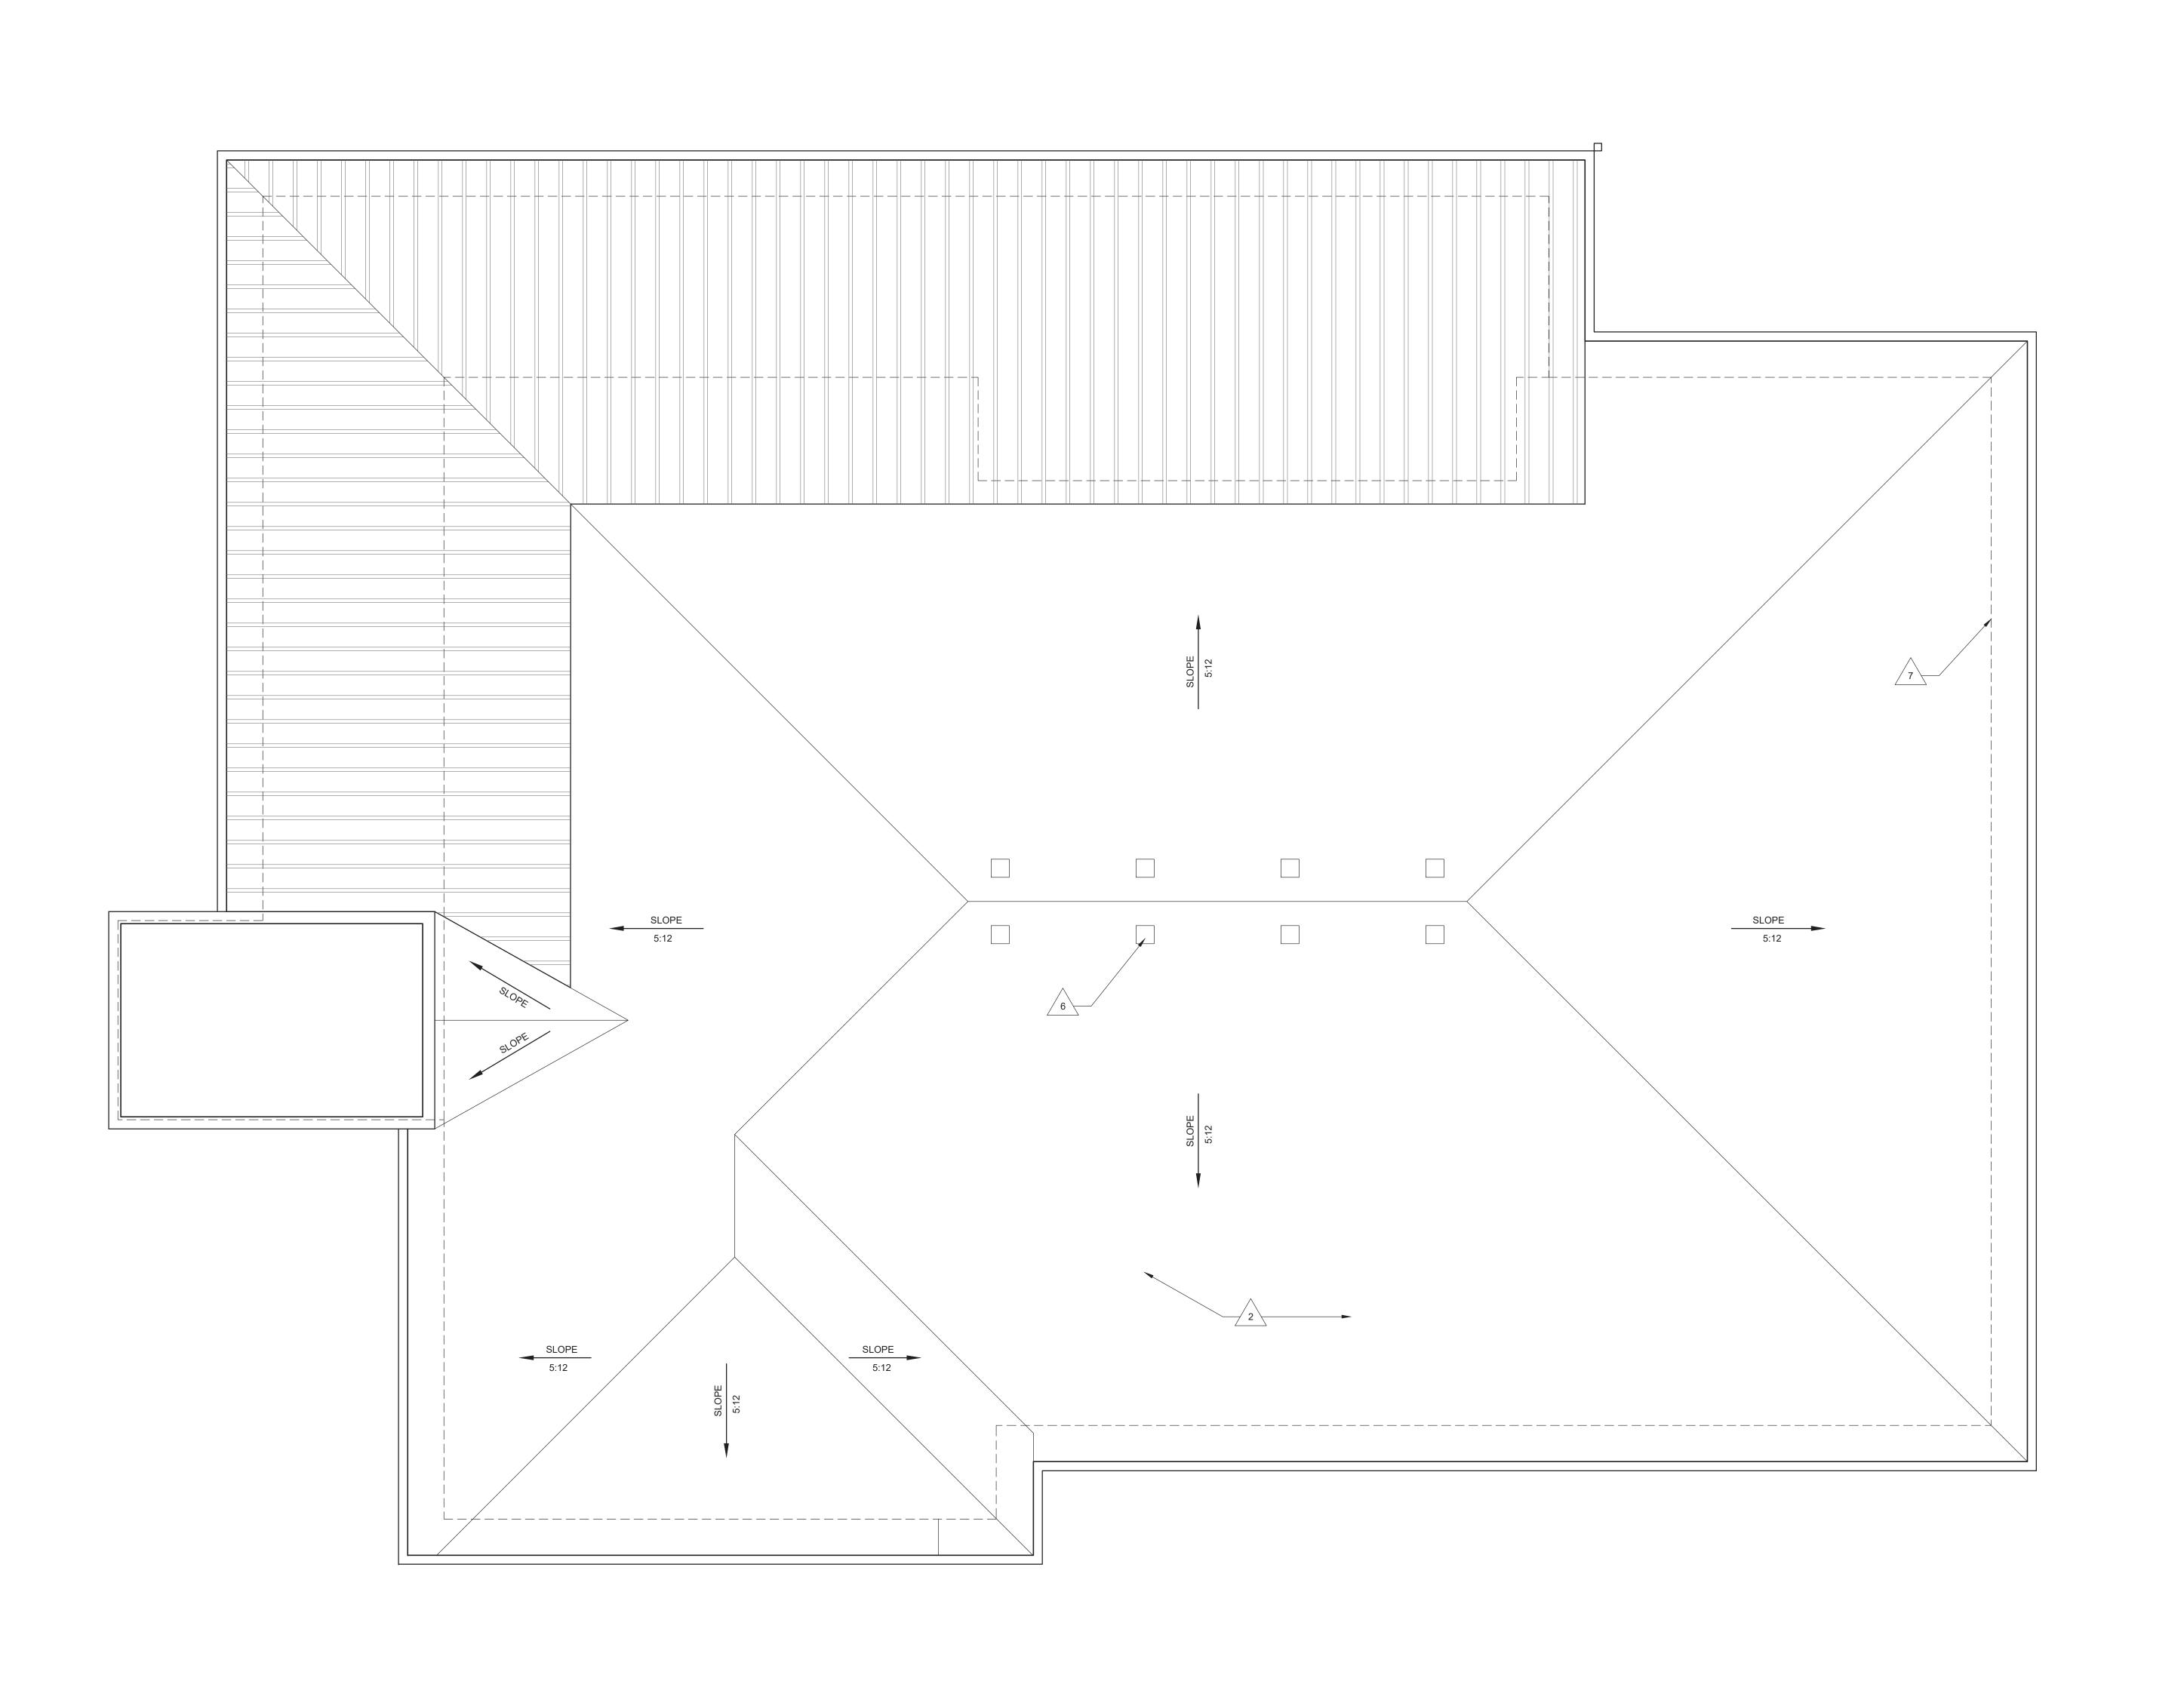

**GENERAL FLOOR PLAN NOTES:** 

A. SEE TYPICAL PLAN SHEETS FOR GENERAL NOTES.

## **GENERAL ELEVATION NOTES:**

A. SEE TYPICAL ELEVATION SHEETS FOR GENERAL NOTES.

CIVIL DRAWINGS.

SIDE OF DOOR. E. LINE OF CMU CURB.

I. 3/4" STEP AT DOOR

N. END LIST.

B. PROVIDE VERTICAL 2X BLOCKING.

C. OSB PANELS 1 SIDE OF DEMISING WALLS ONLY.

F. WOOD FRAMING, NO INTERIOR WALL PANELS.

FLOOR PLAN KEYED NOTES:

A. SLOPE APRON BETWEEN DOORS AS SHOWN PER POINT GRADES ON

D. ADA COMPLIANT THRESHOLD, NO STEP GREATER THAN 1/4" EITHER

H. SEMI RECESSED FIRE EXTINGUISHER AND CABINET. MOUNT < 48".

J. MAINTAIN 8' WIDE PARKING SPACE ADJACENT TO 8' CAR SERVICE AISLE.

M. MAINTAIN 8' WIDE PARKING SPACE ADJACENT TO 8' CLEAR ACCESS ISLE

G. CONTROLS AT ALL ACCESSIBLE PARKING BAYS TO BE < 48".

K. 1 HR ASSEMBLY, EXTENDED TO UNDERSIDE OF DECK.

3225 S. HOYT AVENUE MUNCIE, IN 47302 765-282-3778



2056 N. ALABAMA ST. INDIANAPOLIS, IN 46202 BILLY@R3BARCHITECTURE.COM

574-850-2270 L. SLOPE LESS THAN 2% EITHER DIRECTION WITHIN ACCESSIBLE PARKING SEAL

PROJECT TITLE

PROGRESS

KENNSINGTON WAY MCCORDSVILLE, IN 46055

SECTION KEYED NOTES:

1. PROVIDE H1 TRUSS CLIPS @ EACH END.

2. TOP OF CMU BEYOND FOUND AT PERIMETER. 3. 2X4'S @ 16" O.C. W/ 7/16 OSB ON ONE SIDE ONLY. EXTEND TO UNDERSIDE OF ROOF DECKING.

4. TOP OF PAVEMENT REFER TO CIVIL. 5. TOP OF CONC. APRON COORDINATE WITH CIVIL.

6. BRICK BEYOND.

7. RETURN 1X5 F.C. TRIM BOARD. 8. 1X4 F.C. TRIM BOARD.

4" GRANULAR FILL.

9. SECTIONAL OVERHEAD DOOR TRACK AND ELECT MOTOR. 10.4" CONC. SLAB W/ 6"X6" #10/10 W.W.F. ON 6 MIL VAPOR BARRIER OVER

11. ADJUST SLOPE AT DOOR TO MAINTAIN <2% SLOPE AND ALLOW FOR ADA THRESHOLD.

12.PROVIDE # 4 REBAR @ 4'-0" O.C. MIN. 8" EMBEDDED INTO CONCRETE. 13. GROUT CAVITY SOLID.

14. FINISHED GRADE VARIES WITHIN THIS AREA, REFER TO CIVIL. 15.2 COURSES OF 8" CMU INCH WIDE W/ CELLS GROUTED SOLID.

16. TREATED 2X4 SILL W/ 1/2" ANCH. BOLT @ 4'-0" O.C. AND 12" FROM 17.BRICK.

18.BRICK ROWLOCK 15 DEGREE MIN. 19.2X4 STUD @ 16" O.C.

20.7/16" O.S.B. 21.VINYL SOFFIT OR F.C. LAP SIDING.

22.2x6 FASCIA WITH ALUM. WRAP.

23.FIBERGLASS SHINGLES ON 15# FELT OVER 7/16" OSB DECKING, ON PRE-ENGINEERED WOOD TRUSSES @ 2'-0" O.C.

24.2% ( $\frac{1}{4}$ " PER FOOT) SLOPE MAX 25.END LIST.

## **RX ROOF PLAN KEYED NOTES:**

ATTIC DRAFTSTOP: EXTEND WALL GYP. (R1) BOARD TO CEILING AND TAPE AND SEAL JOINTS PER A500 SERIES AIR SEALANT DETAILS PRIOR TO FRAMING BULKHEADS.

(R2) FR SHEATHING: AREA OF FIRE RETARDANT PLYWOOD SHEATHING, CENTERED ABOVE 2-HR ASSEMBLY, NO VENTS OR PENETRATIONS PERMITTED IN THIS AREA. STAGGER JOINTS.

(R3) 2 HR WALL ASSEMBLY, EXTEND TO UNDERSIDE OF ROOF DECK

ROOF ANCHOR

(R5) ATTIC ACCESS FROM BELOW

(R6) METAL DOWNSPOUT: SEE GENERAL ROOF PLAN NOTES

(R7) SEAMLESS METAL GUTTER: SEE GENERAL ROOF PLAN NOTES

(R8) ROOF VENT WITH ONE SQ. FT. FREE AREA

(R9) ATTIC ACCESS THROUGH DRAFTSTOPPING MAY VARY ALONG WALL, SEE DETAILS:16/A501

R10 RIDGE VENT

Scale: 1/4" = 1'-0"

**EXTERIOR MATERIAL LEGEND** COMPOSITION ROOF REVISIONS STANDING SEAM METAL ROOF MARK DESCRIPTION FIBER CEMENT SIDING

(NOT ALL RATING LINE TYPES ARE NECESSARILY USED IN THIS PROJECT) WALL LEGEND

1 HR RATED "FIRE PARTITION". WALL EXTENDS FROM RATED ASSEMBLY TO

LOAD BEARING WALL OVERLAY REFER TO STRUCTURAL DRAWINGS FOR LOCATIONS. 30 MINUTE RATED "FIRE PARTITION". AT CORRIDORS.

BRICK VENEER

RATED ASSEMBLY. 1 HR RATED "FIRE BARRIER". WALL EXTENDS THROUGH INTERSECTING ASSEMBLIES. 2 HR RATED "FIRE BARRIER". WALL ASSEMBLIES.

EXTENDS THROUGH INTERSECTING 2 HR RATED "FIRE WALL" CONTINUOUS WITHOUT INTERRUPTION.

 SEE STRUCTURAL FOR ALL SHEAR WALL LOCATIONS. SEE WALL ASSEMBLY ON G030 AND G040 SERIES SHEETS FOR SPECIFIC ASSEMBLY REQUIREMENTS.

CONSTRUCTION TYPE OF BUILDING AND FIRE RATING REQUIRED

FOR CERTAIN ELEMENTS IN ACCORDANCE WITH TABLE 601.

RATED WALLS INSIDE UNITS ARE FIRE RATED DUE TO


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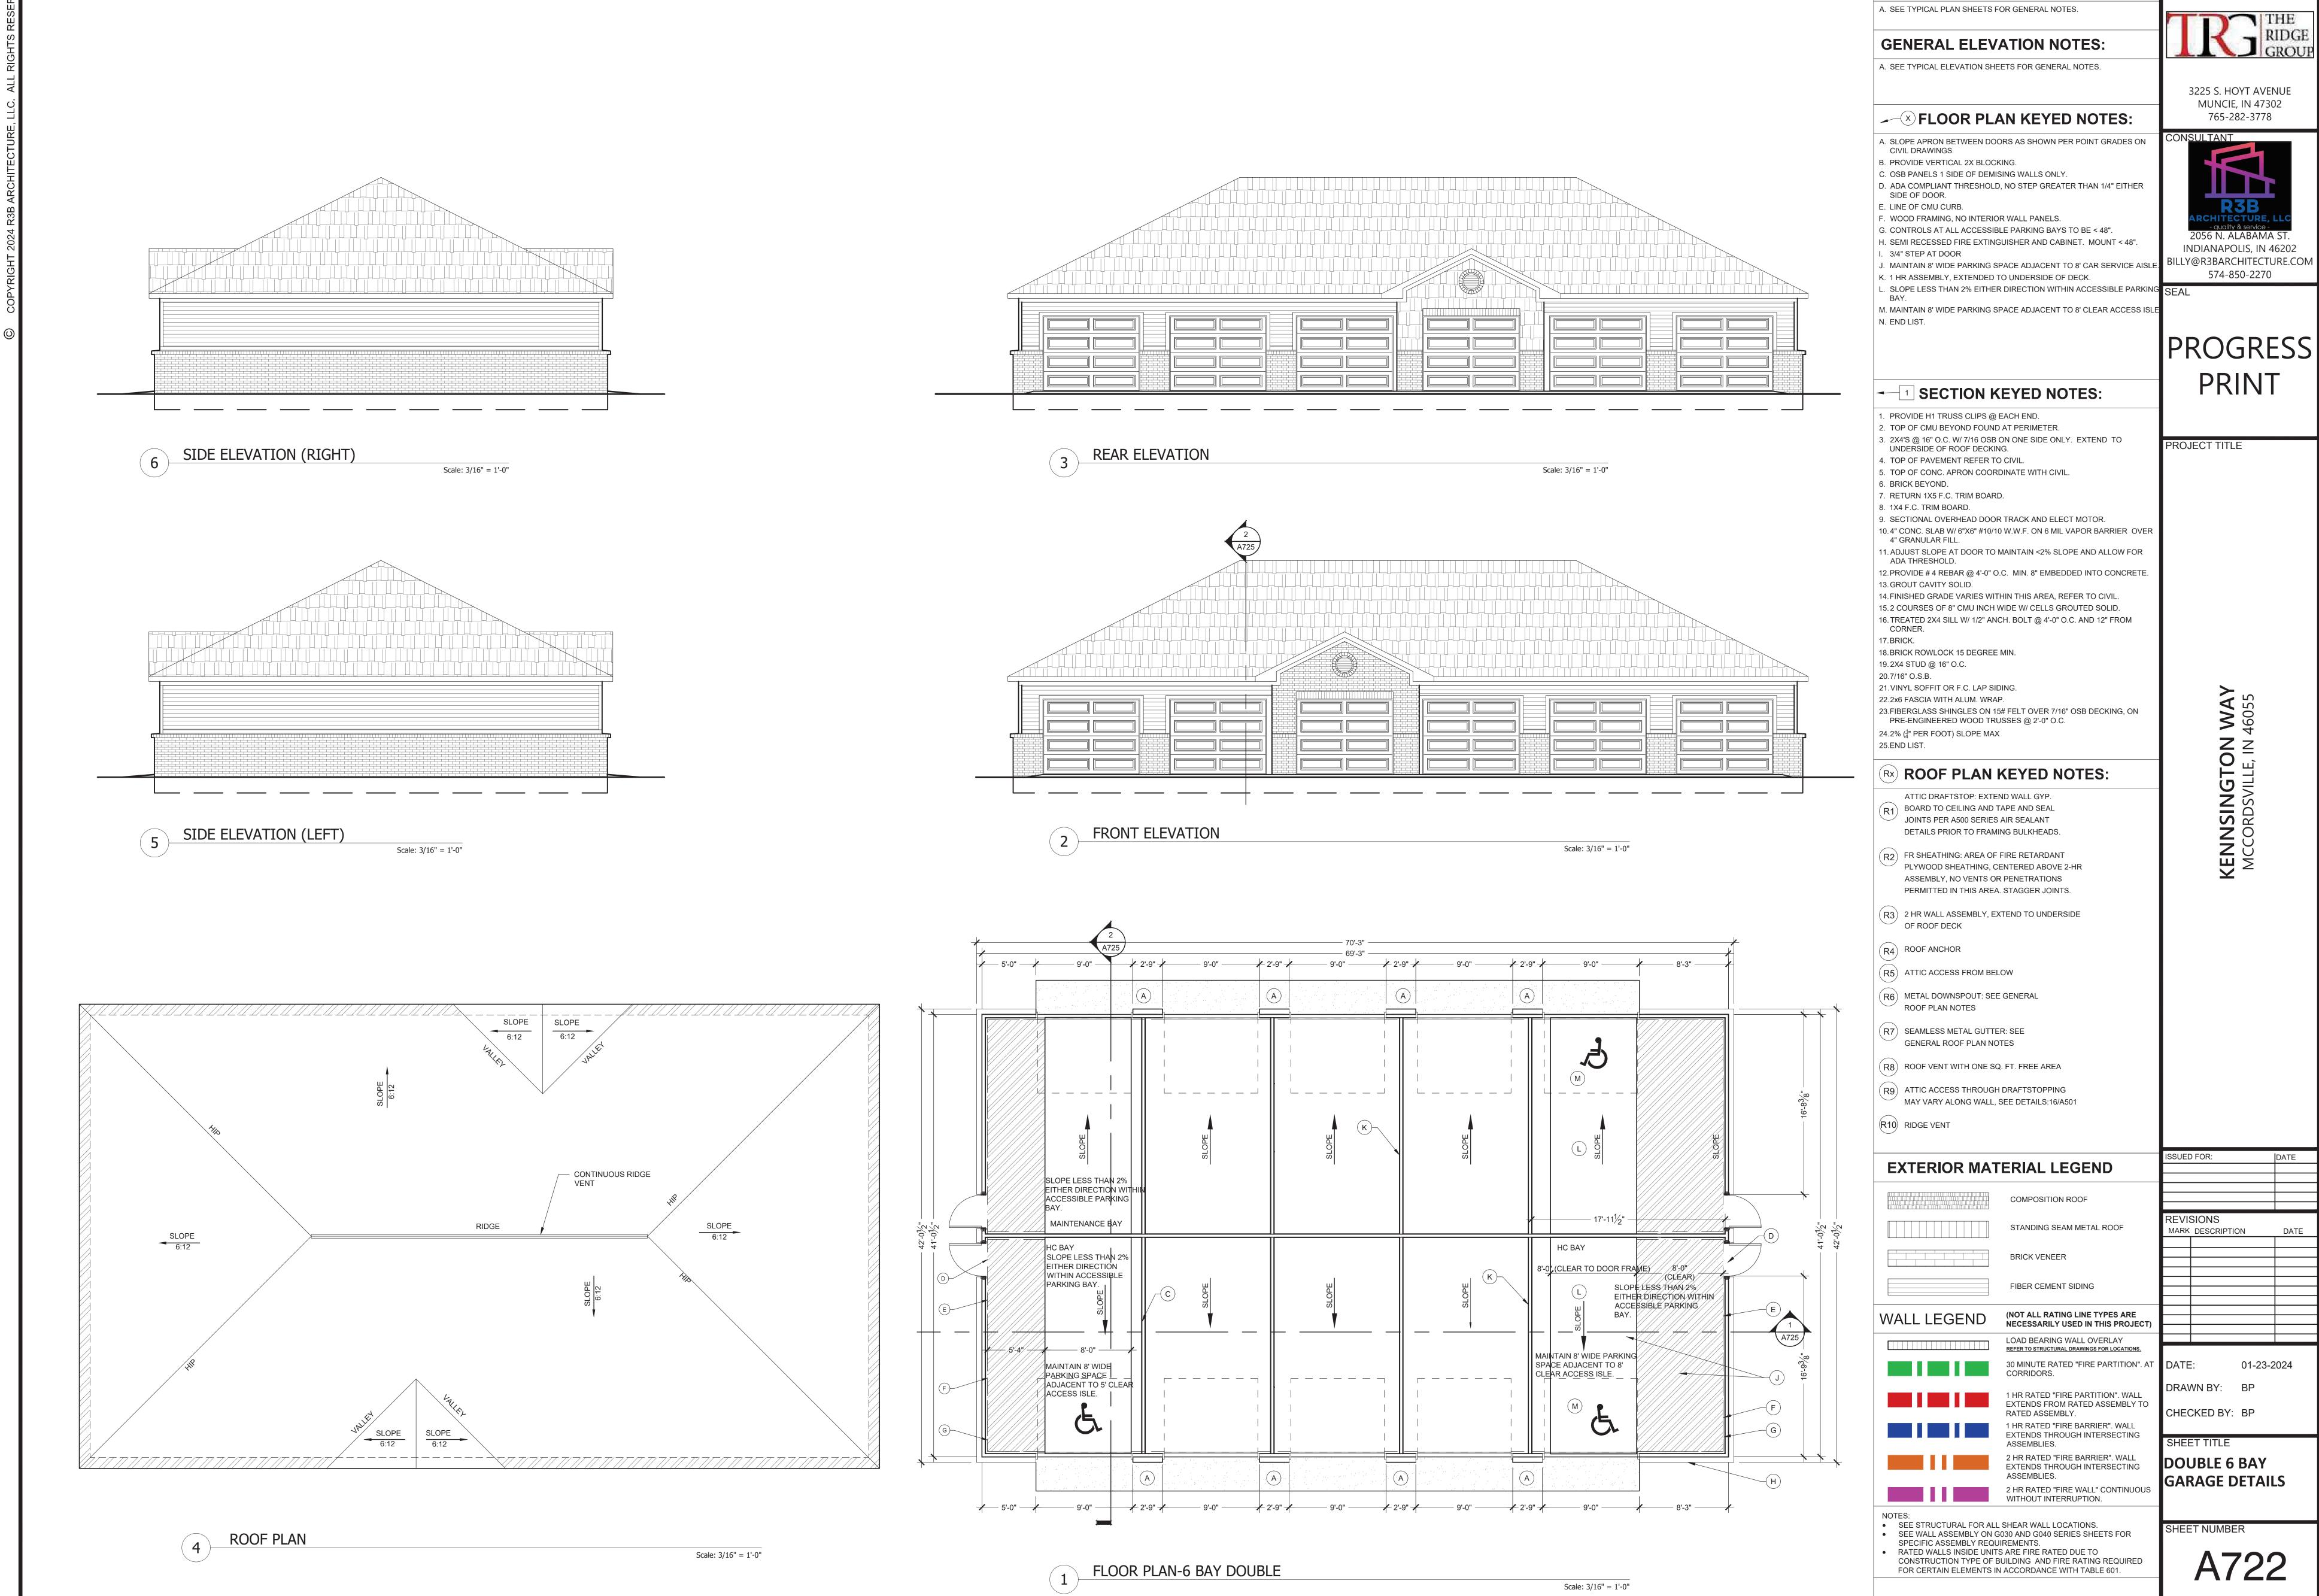
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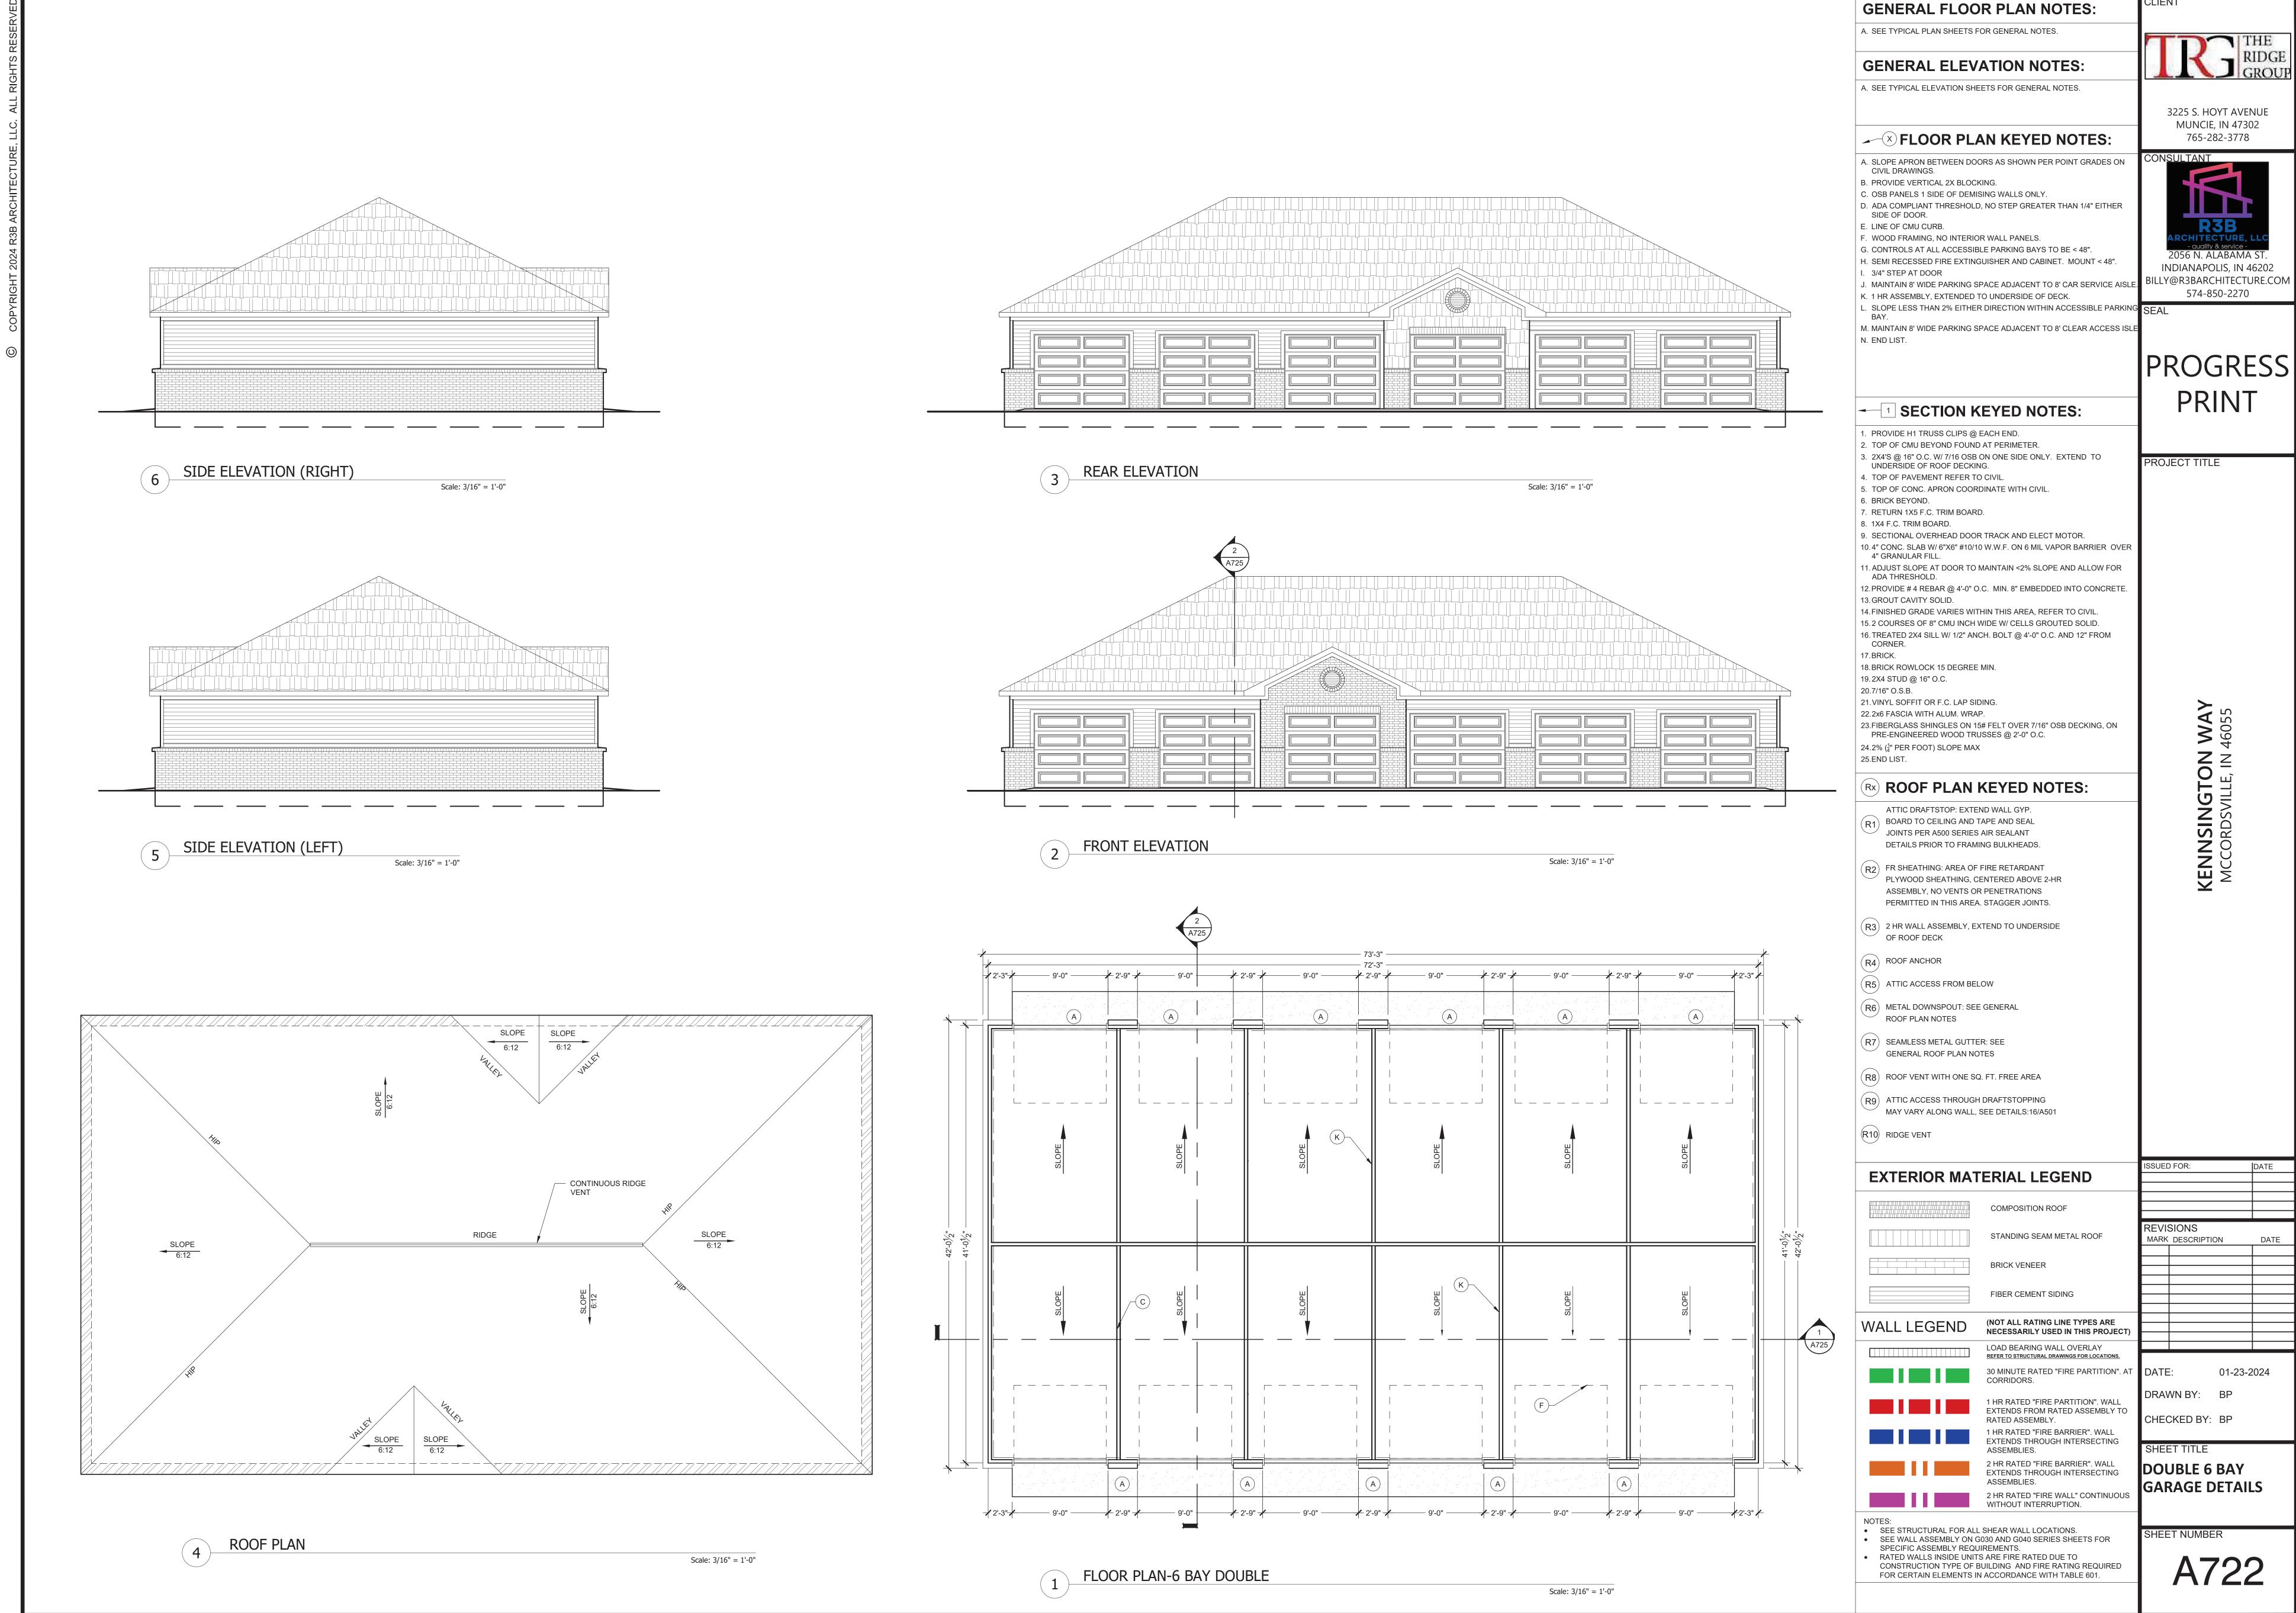
SHEET TITLE


CLUBHOUSE ROOF







**GENERAL FLOOR PLAN NOTES:** 

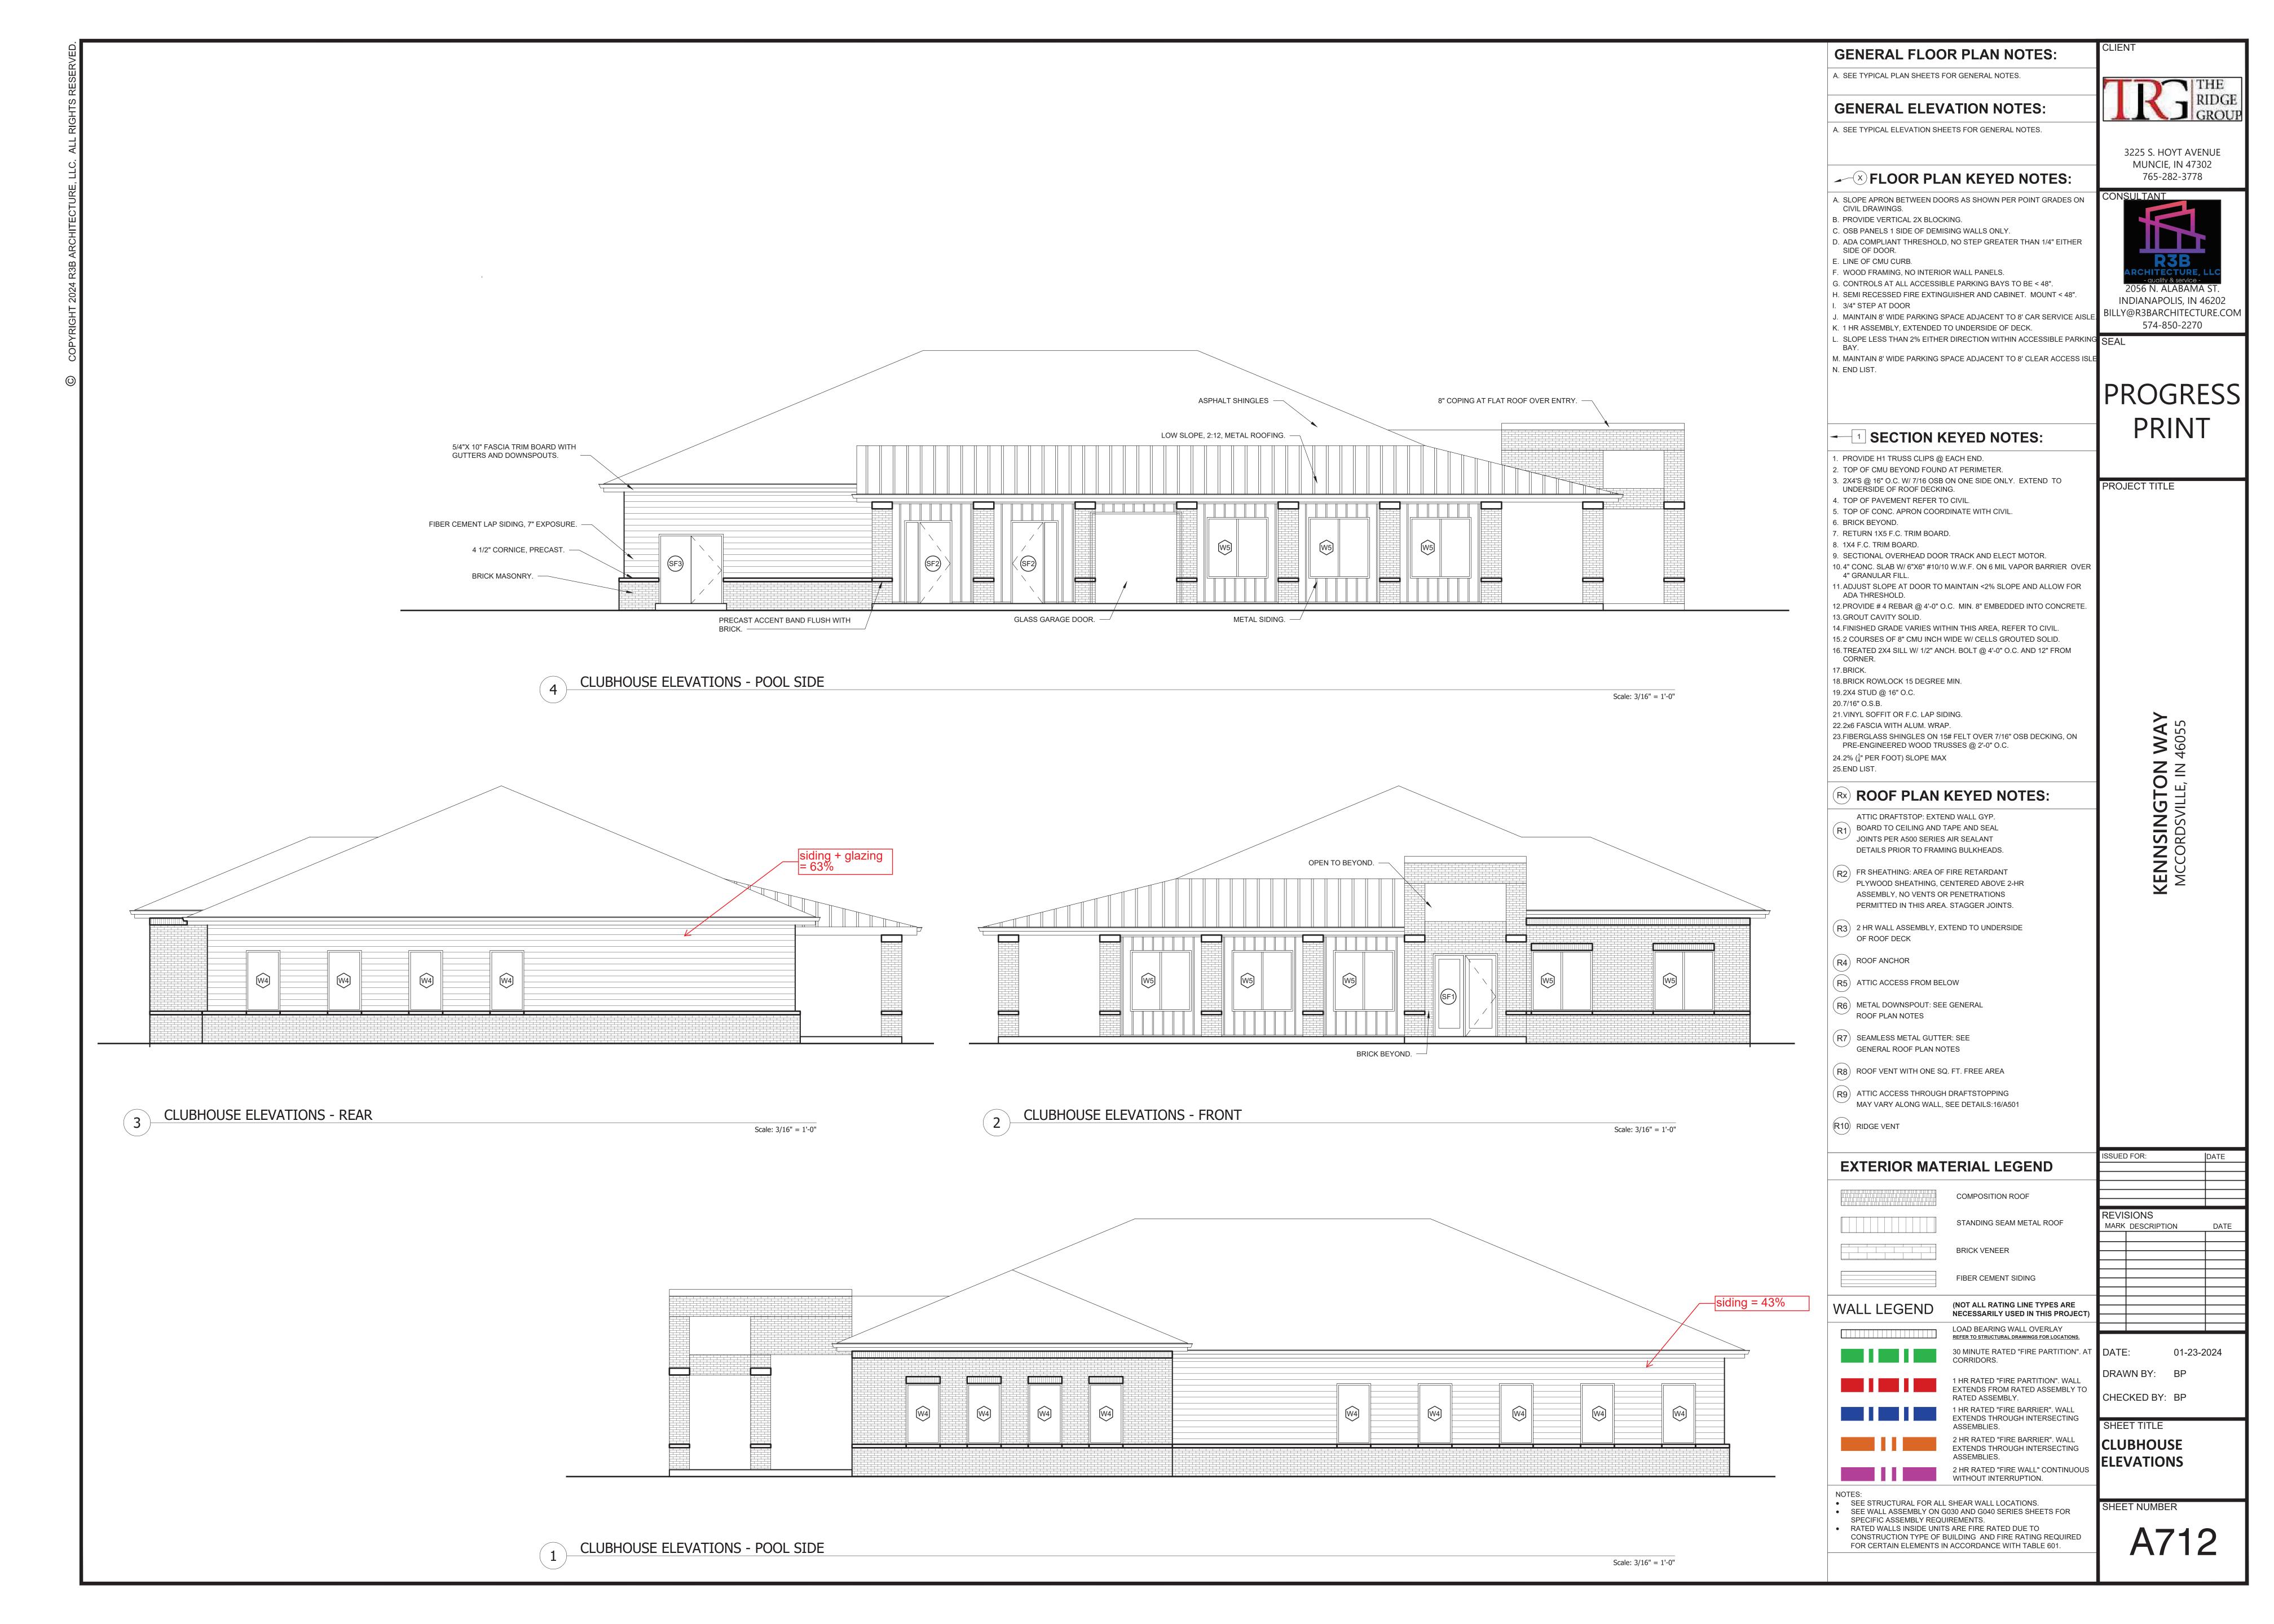


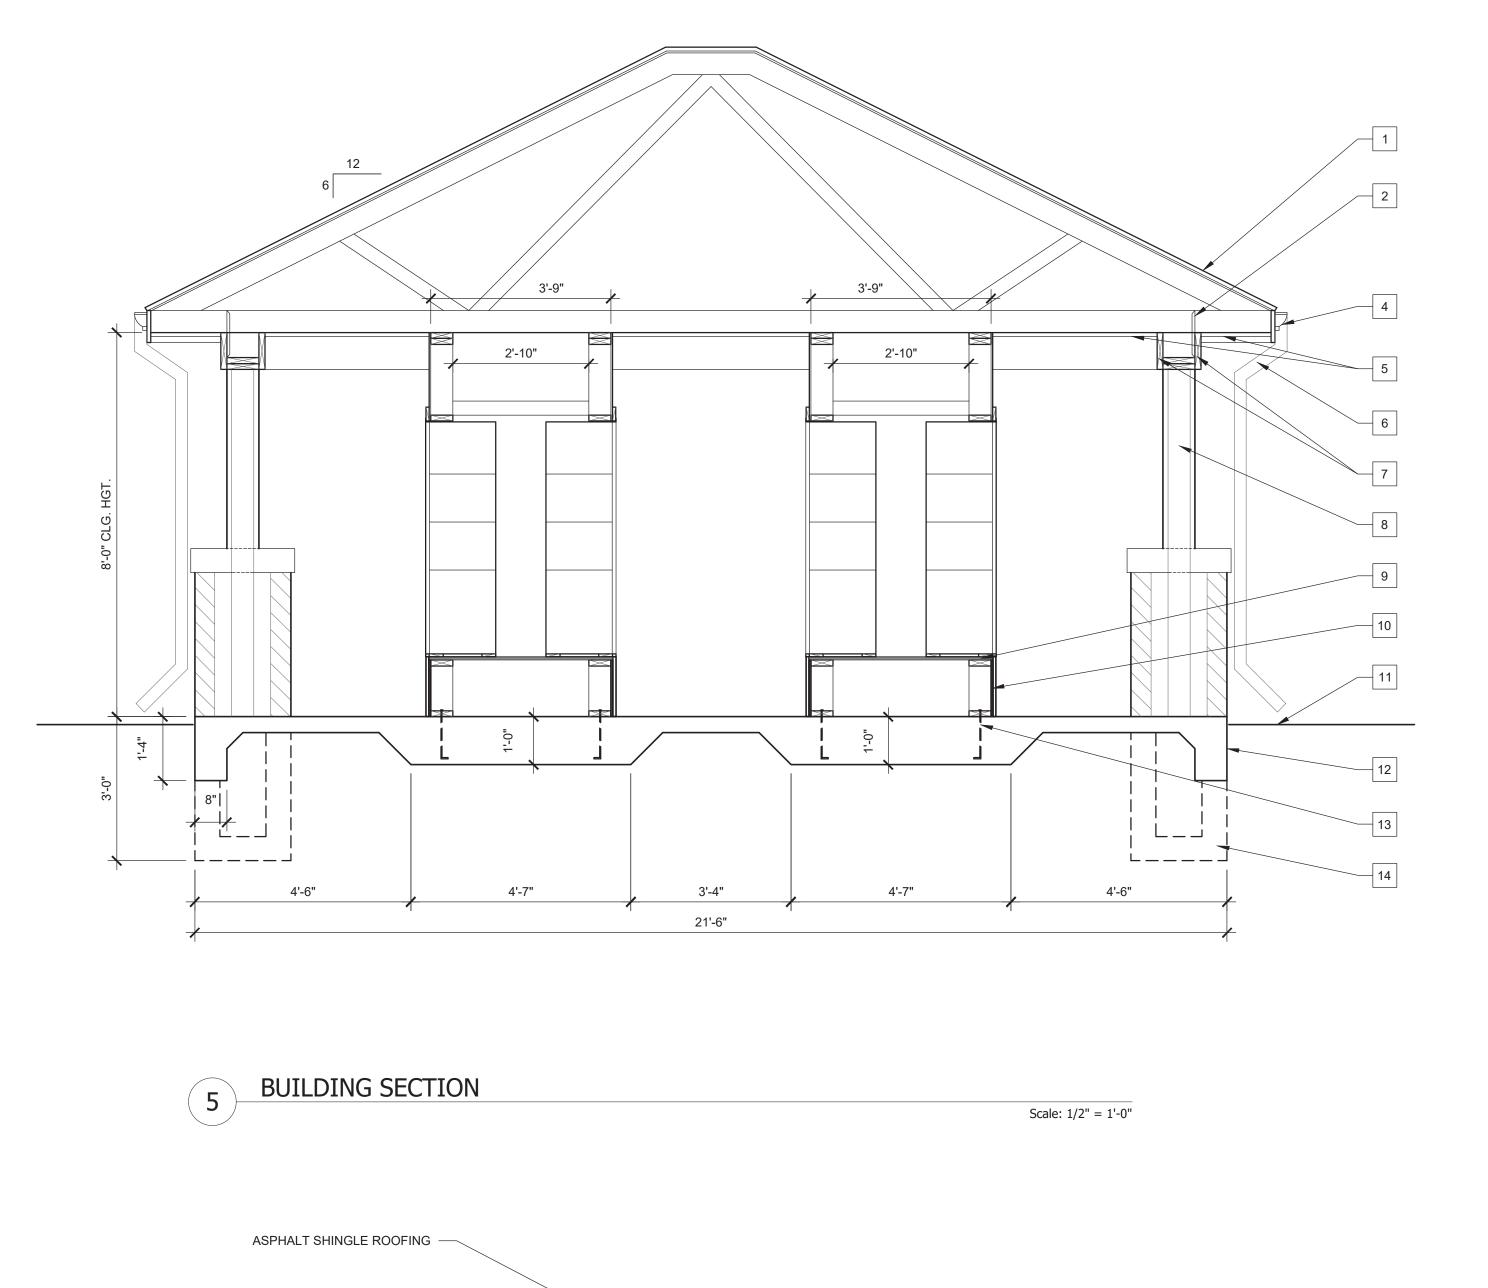


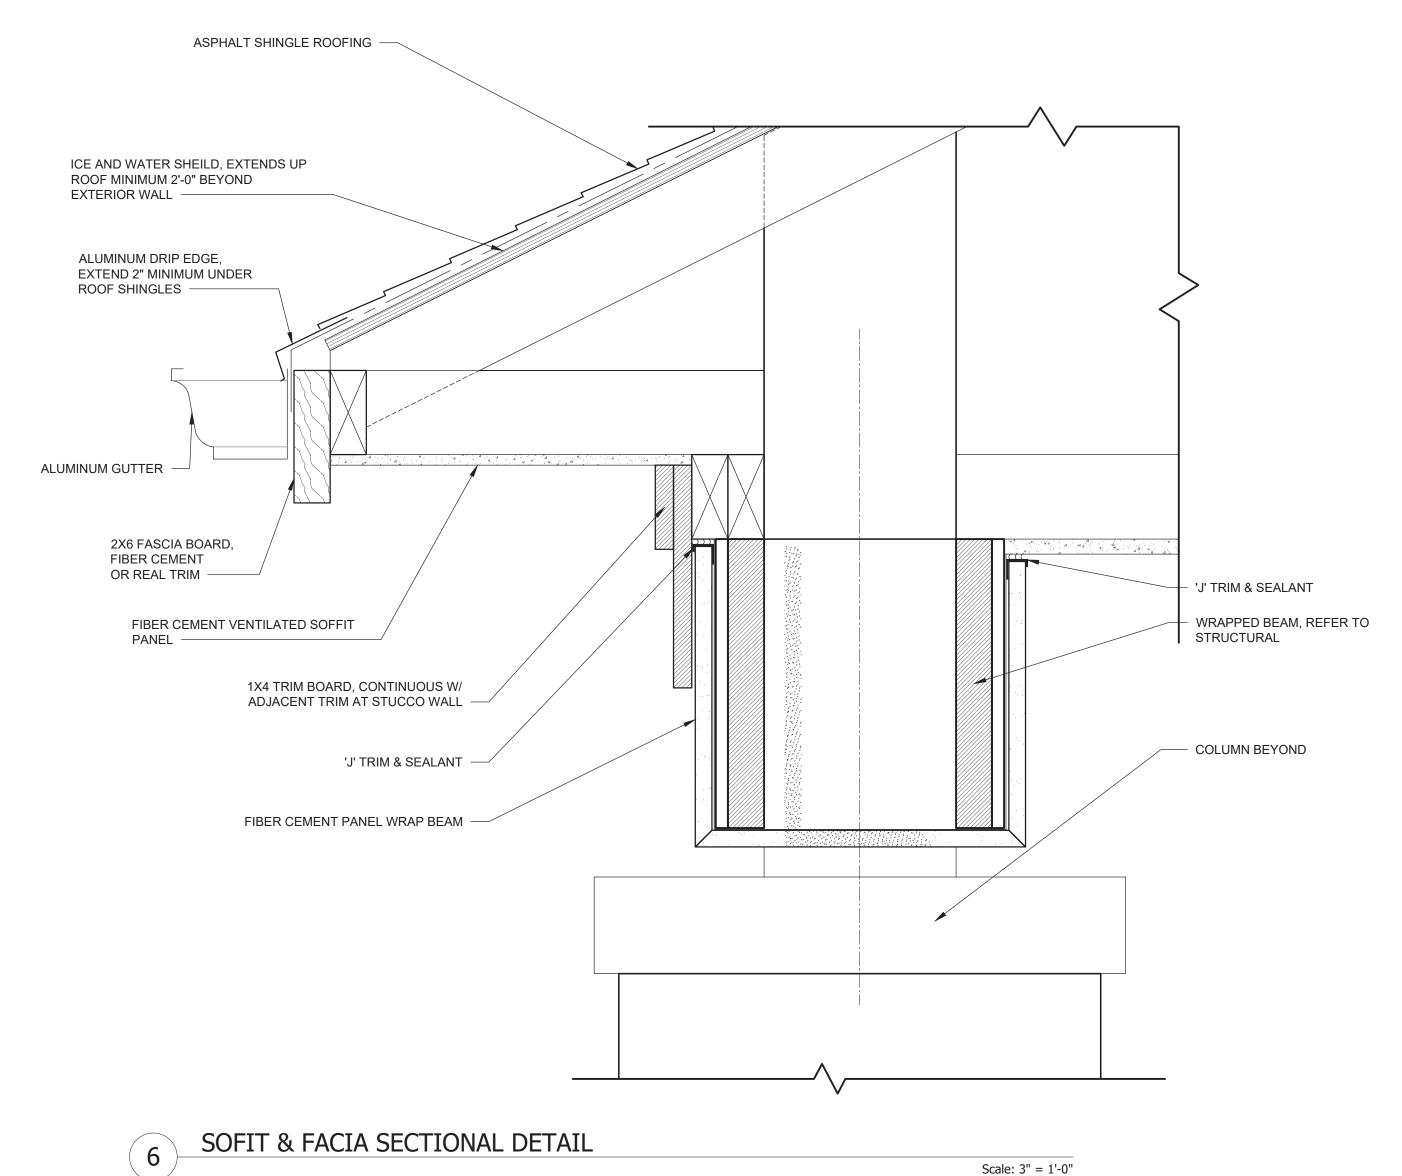

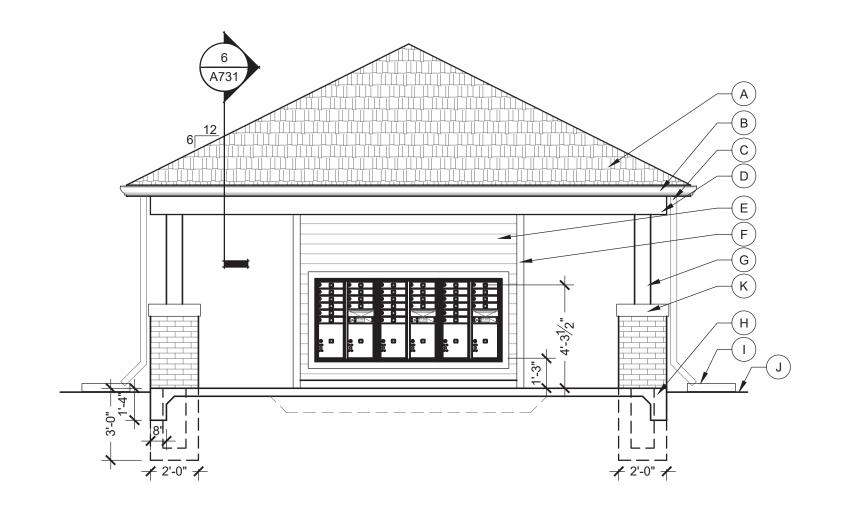

4 SIDE ELEVATION (LEFT)

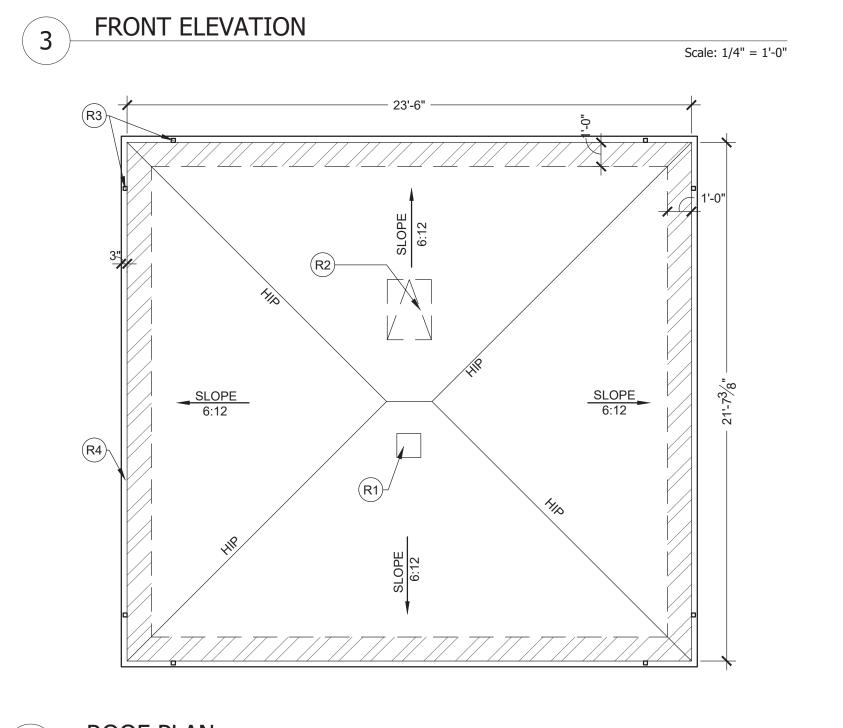

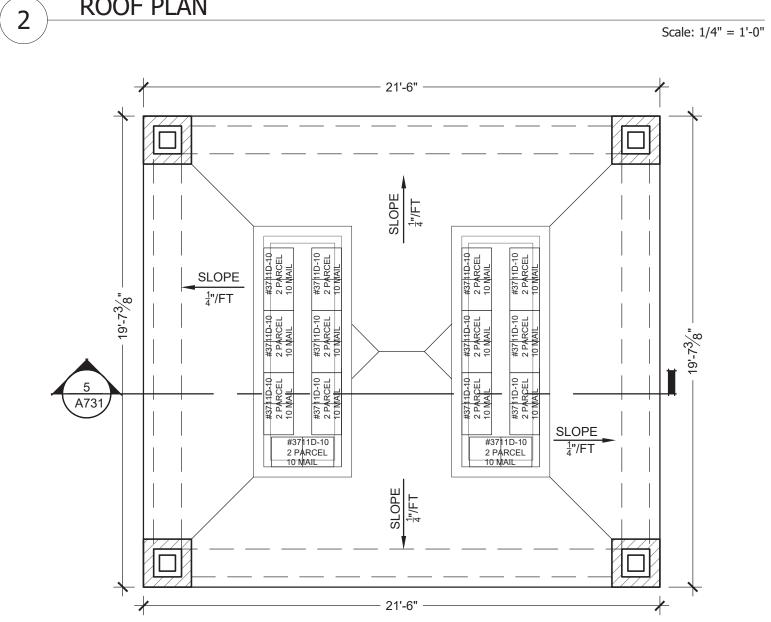

Scale: 1/4" = 1'-0"

**GENERAL FLOOR PLAN NOTES:** 

A. SEE TYPICAL PLAN SHEETS FOR GENERAL NOTES.

## **GENERAL ELEVATION NOTES:**

A. SEE TYPICAL ELEVATION SHEETS FOR GENERAL NOTES.

## 3225 S. HOYT AVENUE MUNCIE, IN 47302

A. DIMENSIONAL ASPHALT SHINGLES

B. ALUMINUM GUTTER C. ALUMINUM DOWNSPOUT

D. 2X10 BEAM EACH SIDE OF POST THRU BOLTED W/ (3)  $^1_2$  DIAMETER BOLTS AT EACH POST.

**ELEVATION KEYED NOTES:** 

E. FIBER CEMENT SIDING F. FIBER CEMENT TRIM

G. 8"X8" REAL POST, SMOOTH CEDAR

H. 4" CONC. SLAB W/ 6X6X10 W.W.F. ON 4" COMPACTED FILL I. SPLASH BLOCK.

J. GRADE

K. PRECAST CONCRETE CAP STONES. L. END LIST.

## **→**1 SECTION KEYED NOTES:

1. CLASS A FIBERGLASS SHINGLES ON 5LB. FELT PAPER ON 1/2" OSB

SHTG. ON PRE-ENGINEERED ROOF TRUSS @ 24" O.C. 2. ROOF TRUSS TIE DOWNS CLIPS.

3. ALUMINUM GUTTER W/DRIP. 4. PERFORATED VINYL SOFFIT AT PERIMETER.

5. ALUMINUM DOWNSPOUT, BEYOND.

6. 2x10 CEDAR BEAM EACH SIDE OF POST THRU BOLTED W/(3), 1/2"\DIAMETER BOLTS AT EACH POST, PROVIDE INTERMEDIATE BLOCKING PROJECT TITLE

7. 14"X14" RS CEDAR POST. 8. PRESSURE TREATED  $\frac{3}{4}$ " OSB W/2X BLOCKING AS REQ'D.

9. PRESSURE TREATED 2x6 @ 16" O.C. W/ 7/16" OSB AND BUILDING WRAP. 10. GRADE

11.4"CONC. SLAB W/ 6X6X10 W.W.F. ON 4" COMPACTED FILL.

 $12.\frac{1}{2}$ " DIA. ANCHOR BOLTS @48"O.C. 12" MAX. FROM ENDS.

13.1'-6" DIAMETER CONC. PIER. 14.6"X 6" RS CEDAR POST.

Scale: 1/4" = 1'-0"

15.2X6 CEDAR (SOFFIT) FLUSH WITH BOTTOM OF BEAMS.

## **RX ROOF PLAN KEYED NOTES:**

(R1) ROOF VENT, 144 SQ. INCHES FREE AREA, MIN.

(R2) ATTIC ACCESS W/LOCK

R4 ALUMINUM GUTTER W/ DRIP

(R3) DOWNSPOUT LOCATION

KENNSINGTON WAY MCCORDSVILLE, IN 46055

765-282-3778

2056 N. ALABAMA ST

INDIANAPOLIS, IN 46202

BILLY@R3BARCHITECTURE.COM

574-850-2270

PROGRESS

PRINT

## **EXTERIOR MATERIAL LEGEND**

COMPOSITION ROOF

STANDING SEAM METAL ROOF

BRICK VENEER

FIBER CEMENT SIDING

REVISIONS MARK DESCRIPTION

(NOT ALL RATING LINE TYPES ARE NECESSARILY USED IN THIS PROJECT

LOAD BEARING WALL OVERLAY REFER TO STRUCTURAL DRAWINGS FOR LOCATIONS. 30 MINUTE RATED "FIRE PARTITION". AT CORRIDORS.

1 HR RATED "FIRE PARTITION". WALL EXTENDS FROM RATED ASSEMBLY TO RATED ASSEMBLY.

SPECIFIC ASSEMBLY REQUIREMENTS.

ELEMENTS IN ACCORDANCE WITH TABLE 601.

1 HR RATED "FIRE BARRIER". WALL EXTENDS THROUGH INTERSECTING ASSEMBLIES. 2 HR RATED "FIRE BARRIER". WALL MAIL KIOSK DETAILS EXTENDS THROUGH INTERSECTING ASSEMBLIES. 2 HR RATED "FIRE WALL" CONTINUOUS PARCEL BOXES

WITHOUT INTERRUPTION. SEE STRUCTURAL FOR ALL SHEAR WALL LOCATIONS. SEE WALL ASSEMBLY ON G030 AND G040 SERIES SHEETS FOR

RATED WALLS INSIDE UNITS ARE FIRE RATED DUE TO CONSTRUCTION TYPE OF BUILDING AND FIRE RATING REQUIRED FOR CERTAIN

SHEET NUMBER

140 MAIL BOXES, 28

DRAWN BY: BP

CHECKED BY: BP

SHEET TITLE