OPERATING AUTHORITIES & AREA UTILITIES

VICINITY MAP

NO SCALE

5759 W. Broadway

317-335 -3604

Mark Witsman

McCordsville, IN 46055

CITIZENS ENERGY GROUP 2150 Dr. Martin Luther King Jr St Indianapolis, IN 46200 317-927-4684 Richard Miller, Jr.

16000 Allisonville Road Noblesville, Indiana 46061 317-776-5532 Sandra Casey

ELECTRIC INDIANAPOLIS POWER & LIGHT COMPANY 317-261-5203 Rhonda Williams

FIRE DEPARTMENT MCCORDSVILLE FIRE STATION 7580 Form Street McCordsville, IN 46055 317-335-2268 Attn.: Tom Alexander

240 N. Meridian St., Room 1791 Indianapolis, IN 46204 317-265-3050 Matt Spindler

2243 E. Main St. Greenfield, IN 46140 317-323-2074

POLICE McCORDSVILLE POLICE DEPT. 6280 West CR 800 North McCordsville, IN 46055 317-335-2812

Eric Meyer

CABLE TELEVISION
COMCAST CABLEVISION 5330 East 65th Street Indianapolis, IN 46220 317-774-3384 Matt Stringer

3030 Roosevelt Ave

317-632-9077

Jason Kirkman

Indianapolis, IN 46218

Indianapolis, IN 46202

Attn.: Brad Hostetler

Fortville, IN 46040

Dr. Shane Robbins

317-927-4351

WATER CITIZENS ENERGY GROUP - WATER

2150 Dr. Martin Luther King, Jr. Street

SCHOOL DISTRICT MT. VERNON COMM. SCH. CORP.

1806 West State Road 234


CWA Authority, Inc.

SHEET INDEX		
SHEET NO	DESCRIPTION	
C100	TITLE SHEET	
C101	OVERALL PLAN	
C102	EXISTING TOPOGRAPHY	
C107-C109	SIDEWALK STREET LIGHT, AND SIGN PLAN	
C110-C113	GRADING AND DRAINAGE PLAN	
C114	AMENITY PLAN	
C115-C117	OVERFLOW PLAN	
C118-C120	SSD PLAN	
C200-C203	STREET PLAN & PROFILE	
C220-C223	ENTRANCE & INTERSECTION DETAILS	
C300-C302	SANITARY SEWER PLAN	
C303-C306	SANITARY SEWER PLAN & PROFILES	
C310-C315	STORM SEWER PLAN & PROFILES	
C320-C322	WATER MAIN PLAN (CITIZENS WATER)	
C323-C324	OFF-SITE WATER MAIN PLAN (CITIZENS WATER)	
C400-C404	INITIAL EROSION CONTROL PLAN	
C410-C413	FINAL EROSION CONTROL PLAN	
C420	STORM WATER POLLUTION PREVENTION PLAN (SWPPP)	
C500	EROSION CONTROL DETAILS	
C503-C504	STORM WATER DETAILS	
C525	CITIZENS WATER DETAILS	
L1	LANDSCAPING PLAN (By Others)	
1-3	PLAT	
1-10	TOWN OF McCORDSVILLE STANDARDS	

RIVENDELL - SECTION 1

SECTION 18, TOWNSHIP 18N, RANGE 6E, VERNON TOWNSHIP, HANCOCK COUNTY, 96TH & CR N 400 WEST **ZONED: PUD**

> PLANS PREPARED FOR: PREMIER LAND COMPANY II, LLC 11691 FALL CREEK ROAD, SUITE 210 FORTVILLE, INDIANA 46040 317-501-9172 CONTACT: RICHARD HENDERSON

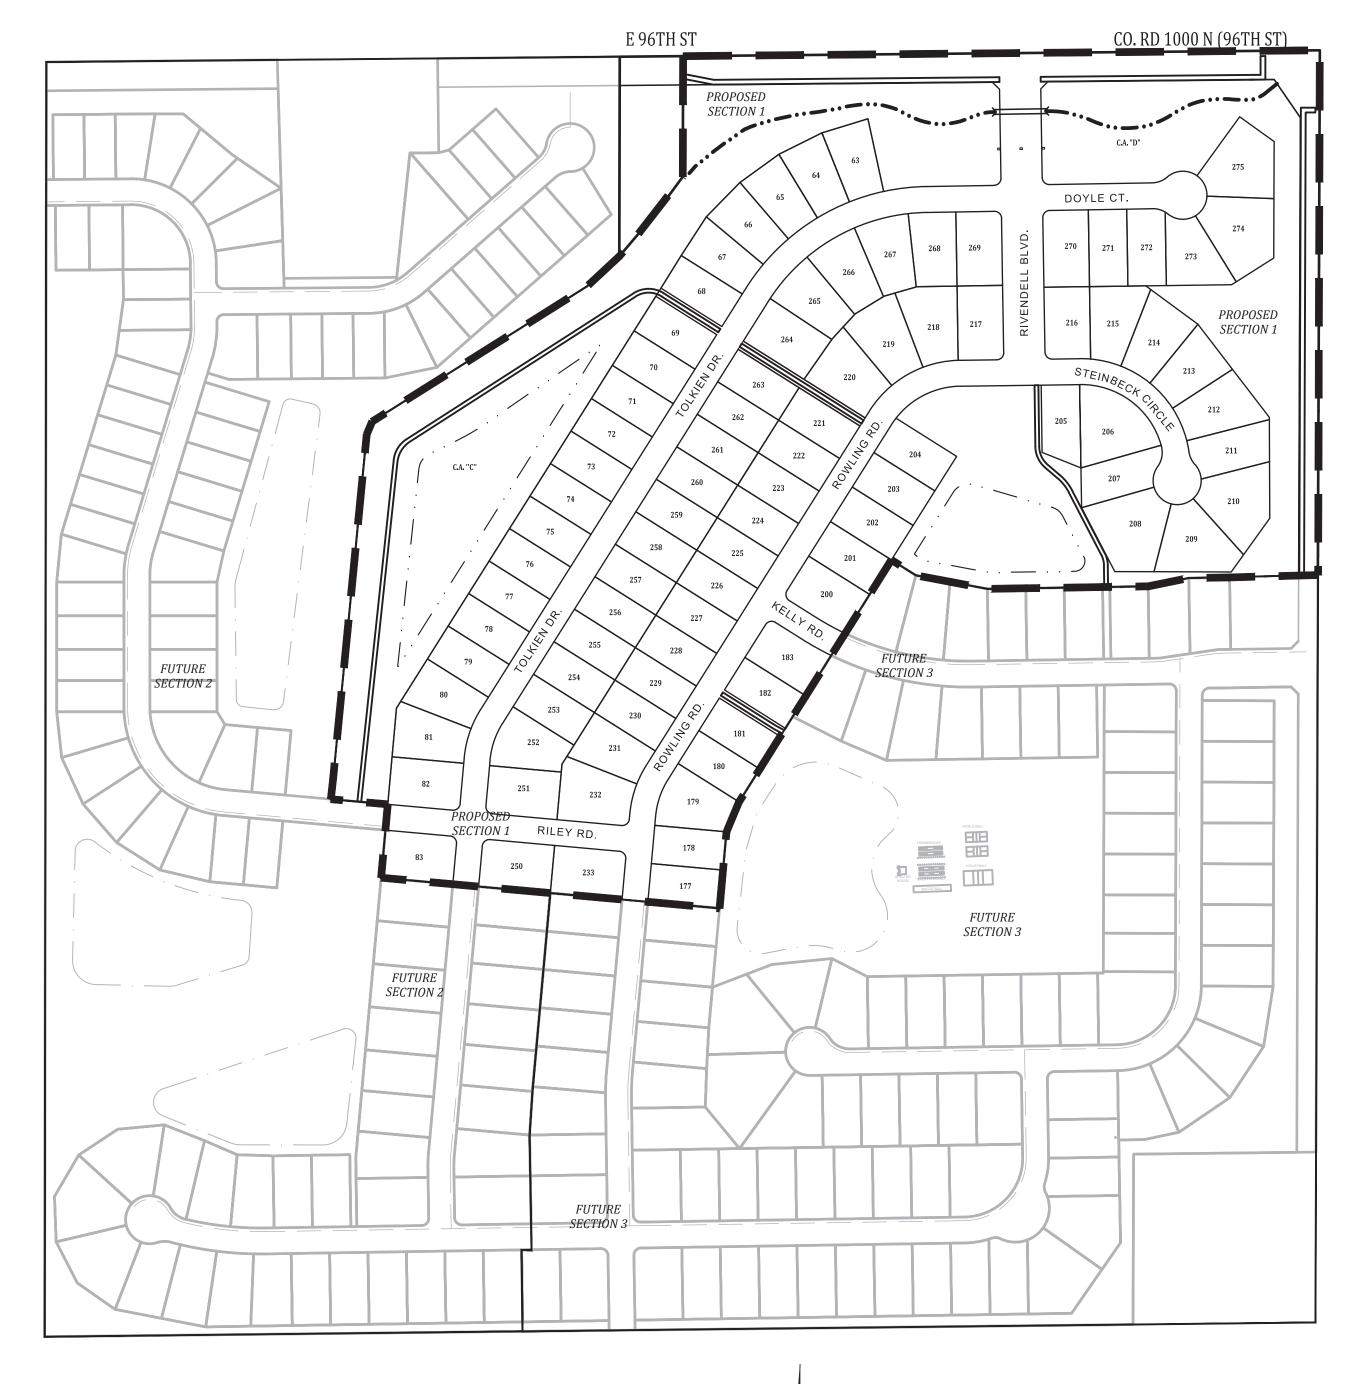

SITE MAP 1"=200'

	REVISIONS	
NUMBER	DESCRIPTION	DATE
1	PER TOWN OF MCCORDSVILLE TECH COMMENTS	9-9-22
	<u> </u>	

SECTION 1 STREET NAME CHART

STREET	NAME	STREET LENGTH		
А	RIVENDELL BLVD	665.4'		
В	TOLKIEN ROAD	2353.0'		
С	ROWLING ROAD	1946.2'		
D	RILEY ROAD	177.1'		
Ē	DICKENS LANE	531.0'		
F	DOYLE COURT	335.4'		
	075111050110115	407.01		



LOCATION MAP NO SCALE

PROJECT SUMMARY

TOTAL AREA OF SECTION 1: 56.21 ACRES ± NUMBER OF LOTS: TOTAL AREA OF LOTS: 27.82 ACRES ± NUMBER OF COMMON AREAS: TOTAL AREA OF COMMON AREAS: 17.17 ACRES ± TOTAL LENGTH OF STREETS: 5664.82 L.F. OR 1.07 MILES TOTAL AREA OF DEDICATED RIGHT-OF-WAY: 10.20 ACRES ±

CONSTRUCTION DOCUMENTS

PROJECT MANAGER:


THESE PLANS ARE NOT TO BE CONSIDERED FINAL OR TO BE UTILIZED FOR CONSTRUCTION UNLESS SIGNED AND DATED BY THE APPROPRIATE BANNING ENGINEERING PROJECT MANAGER.

THESE PLANS ARE NOT INTENDED TO BE REPRESENTED AS A RETRACEMENT OR ORIGINAL BOUNDARY SURVEY, A ROUTE SURVEY, OR A SURVEYOR LOCATION REPORT.

PLANS PREPARED BY:



853 COLUMBIA ROAD, SUITE #101 PLAINFIELD, IN 46168 BUS: (317) 707-3700, FAX: (317) 707-3800 E-MAIL: Banning@BanningEngineering.com WEB: www.BanningEngineering.com CONTACT: LANCE FERRELL EMAIL: LFERRELL@BANNING-ENG.COM

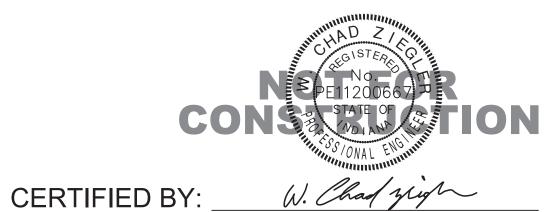

08-19-2022 Project No: 21270P-S1 Sheet No:

C100


Part of the Northeast Quarter of Section 18, Township 17 North, Range 6 East of the Second Principal Meridian in Hancock County, Indiana, being a part of that 155.296-acre tract of land shown on the plat of an ALTA/NSPS Land Title Survey of said tract certified by Jonathan D. Polson, PS #LS21500011 as Banning Engineering project number 21270 (all references to monuments and course herein are as shown on said plat of survey) described as follows:

BEGINNING at a Harrison Monument marking the Northeast corner of said Northeast Quarter of Section 18; thence South 00 degrees 12 minutes 50 seconds West along the east line of said Northeast Quarter 1093.14 feet to a mag nail with washer stamped "Banning Eng Firm #0060"; thence South 88 degrees 26 minutes 48 seconds West 183.94 feet to a 5/8 inch rebar with cap stamped "Banning Eng Firm #0060" (hereinafter referred to as capped rebar); thence South 89 degrees 06 minutes 14 seconds West 85.00 feet to a capped rebar; thence South 78 degrees 26 minutes 37 seconds West 86.49 feet to a capped rebar; thence South 89 degrees 06 minutes 14 seconds West 335.00 feet to a capped rebar; thence North 79 degrees 17 minutes 42 seconds West 151.59 feet to a capped rebar; thence North 57 degrees 47 minutes 57 seconds West 60.23 feet to a capped rebar; thence South 32 degrees 12 minutes 03 seconds West 595.74 feet to a capped rebar; thence South 22 degrees 42 minutes 45 seconds West 67.57 feet to a capped rebar; thence South 05 degrees 10 minutes 04 seconds West 160.00 feet to a capped rebar; thence North 84 degrees 49 minutes 56 seconds West 708.00 feet to a capped rebar; thence North 05 degrees 10 minutes 04 seconds East 153.50 feet to a capped rebar; thence North 84 degrees 49 minutes 56 seconds West 118.99 feet to the center of Stansbury Ditch, (the following Seven (7) calls are along the centerline thereof); 1) thence North 06 degrees 20 minutes 38 seconds East 43.35 feet; 2) thence North 05 degrees 34 minutes 10 seconds East 720.11 feet; 3) thence North 22 degrees 58 minutes 22 seconds East 29.36 feet; 4) thence North 57 degrees 49 minutes 40 seconds East 528.60 feet; 5) thence North 47 degrees 06 minutes 03 seconds East 91.82 feet; 6) thence North 40 degrees 19 minutes 14 seconds East 117.79 feet; 7) thence North 36 degrees 23 minutes 04 seconds East 94.69 feet; thence North 00 degrees 08 minutes 15 seconds East 251.16 feet to a mag nail with washer stamped "Banning Eng Firm #0060" on the north line of said Northeast Quarter; thence North 89 degrees 28 minutes 25 seconds East 1,326.55 feet to the POINT OF BEGINNING, containing 55.191 acres, more or less.

STREET NAME CHART

NAME
RIVENDELL BLVD
TOLKIEN ROAD
ROWLING ROAD
KELLY ROAD
RILEY ROAD
DOYLE COURT
STEINBECK CIRCLE



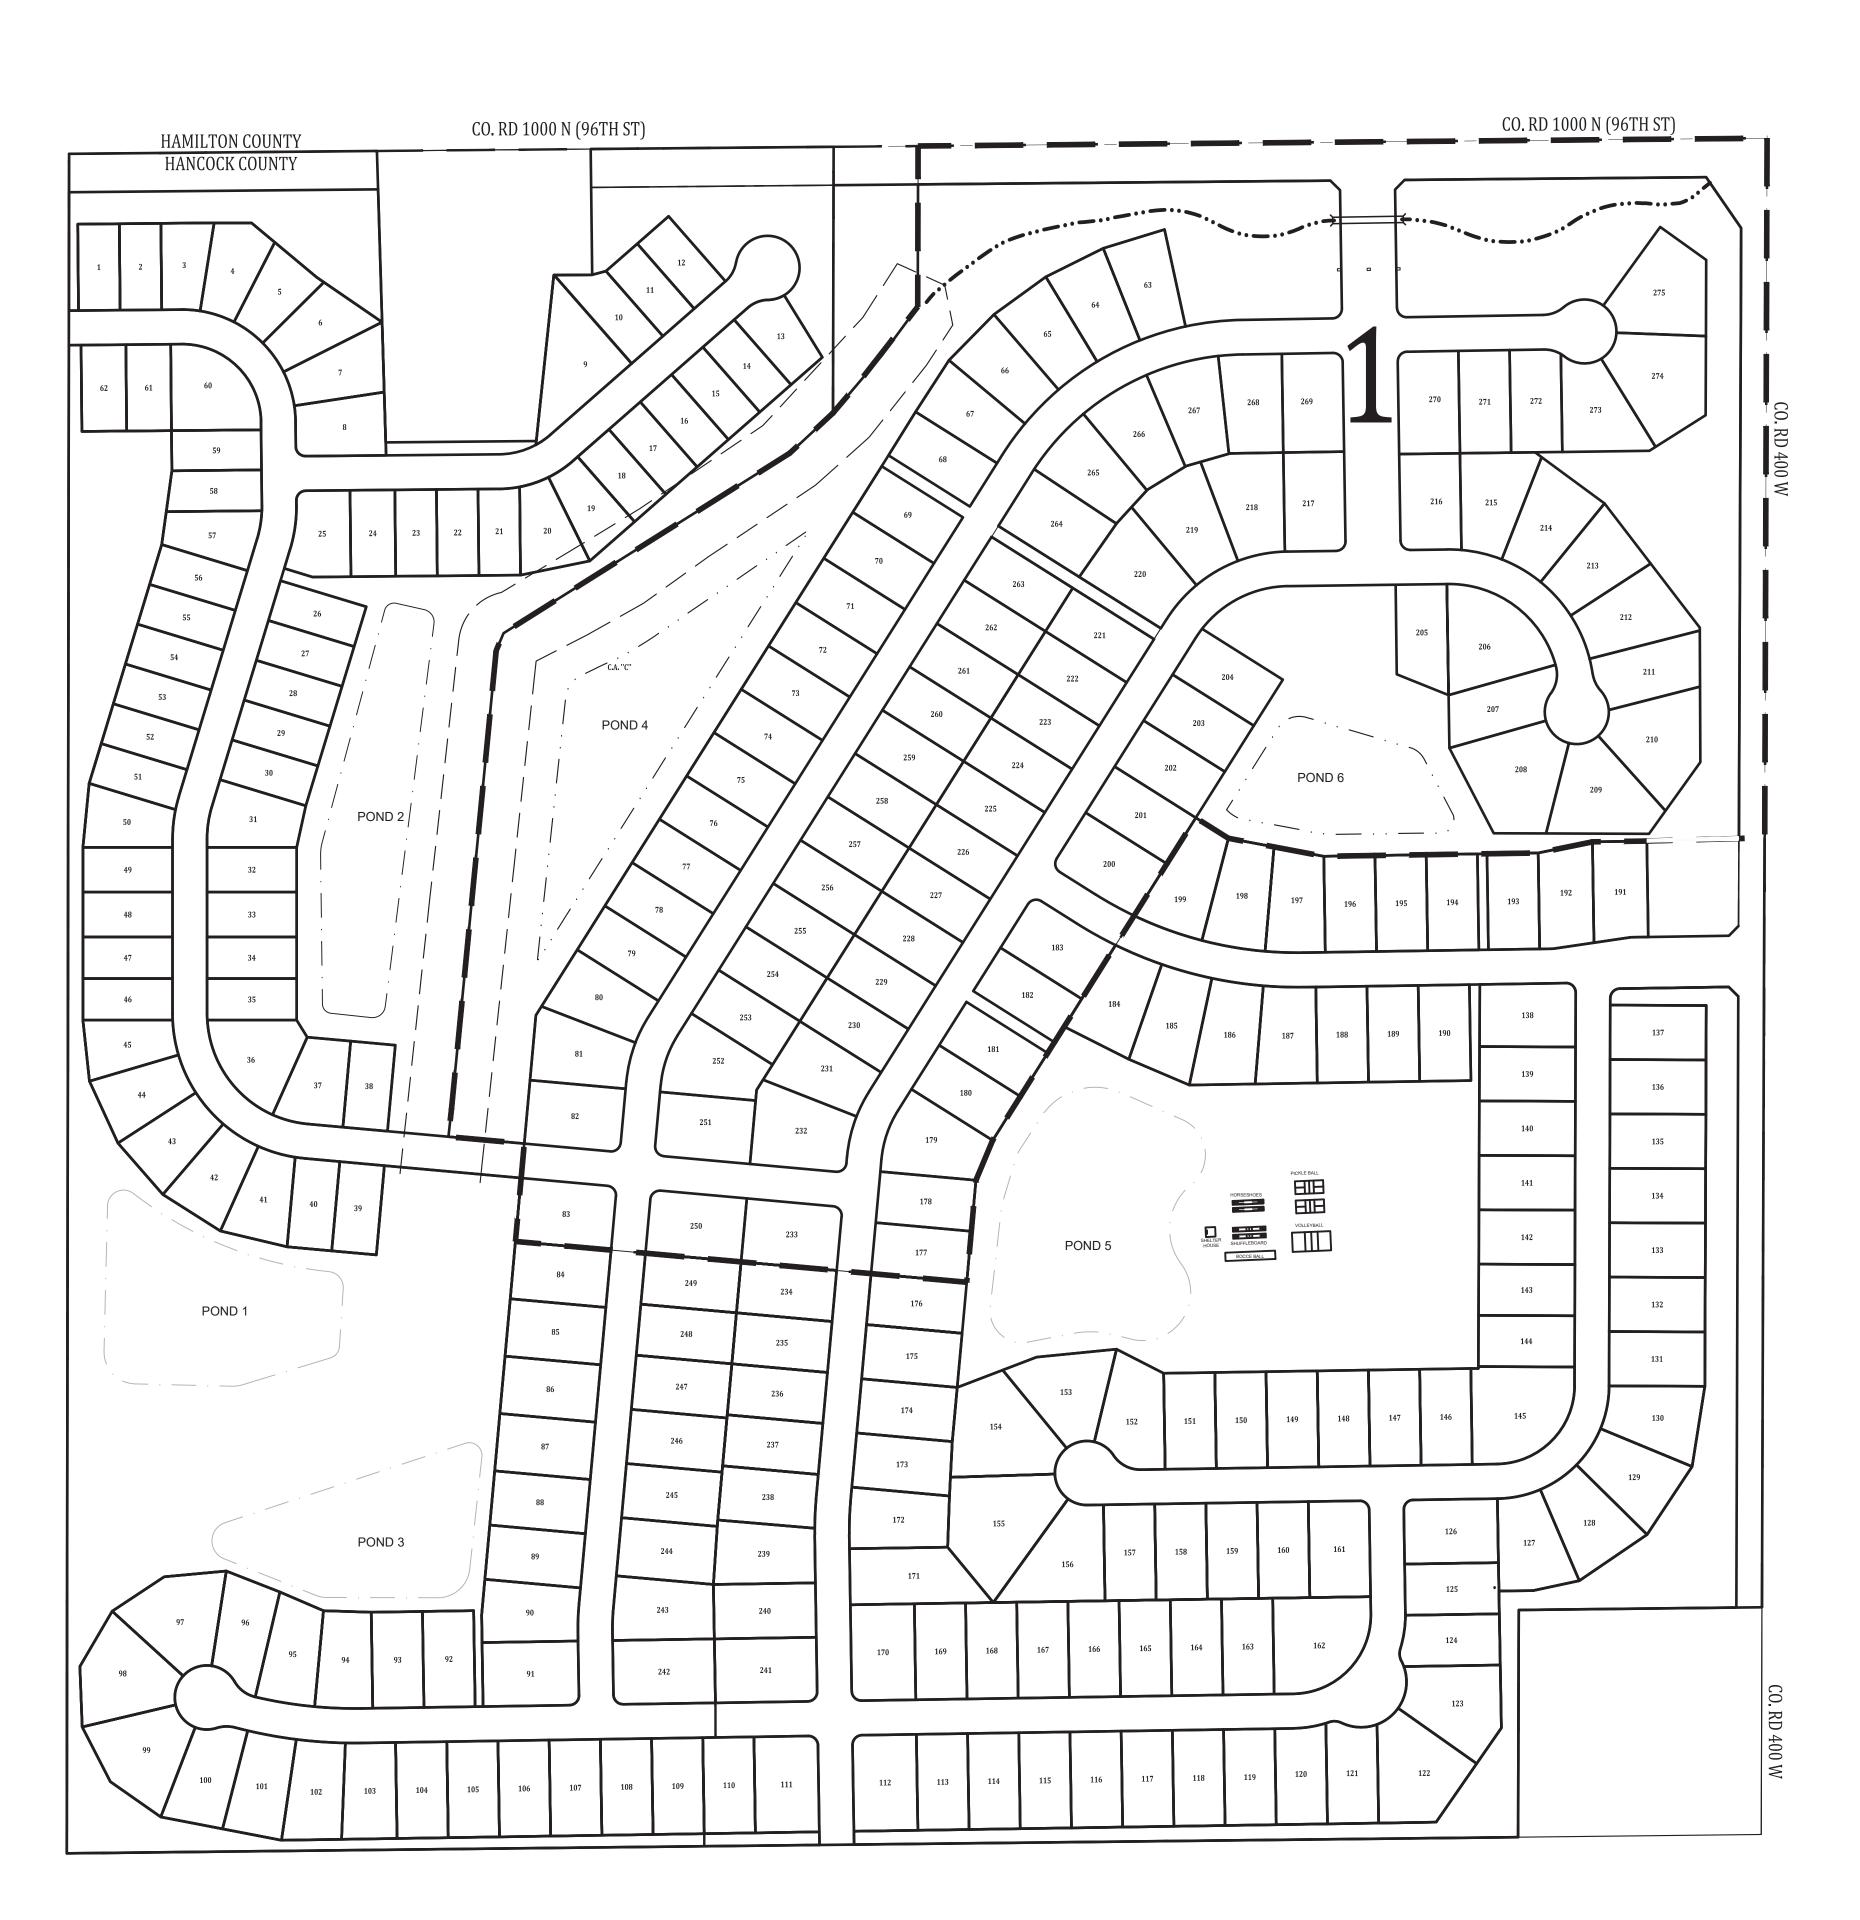



231/21270/Enginescing/Cadd/Sheet Files/21270—S1/21270 S1 All dwg Sen 09 2022 — 1:225


C10

CORDSVILLE
P., HANCOCK

RIVENDELL - SEC TOWN OF MCCO VERNON TWP., I

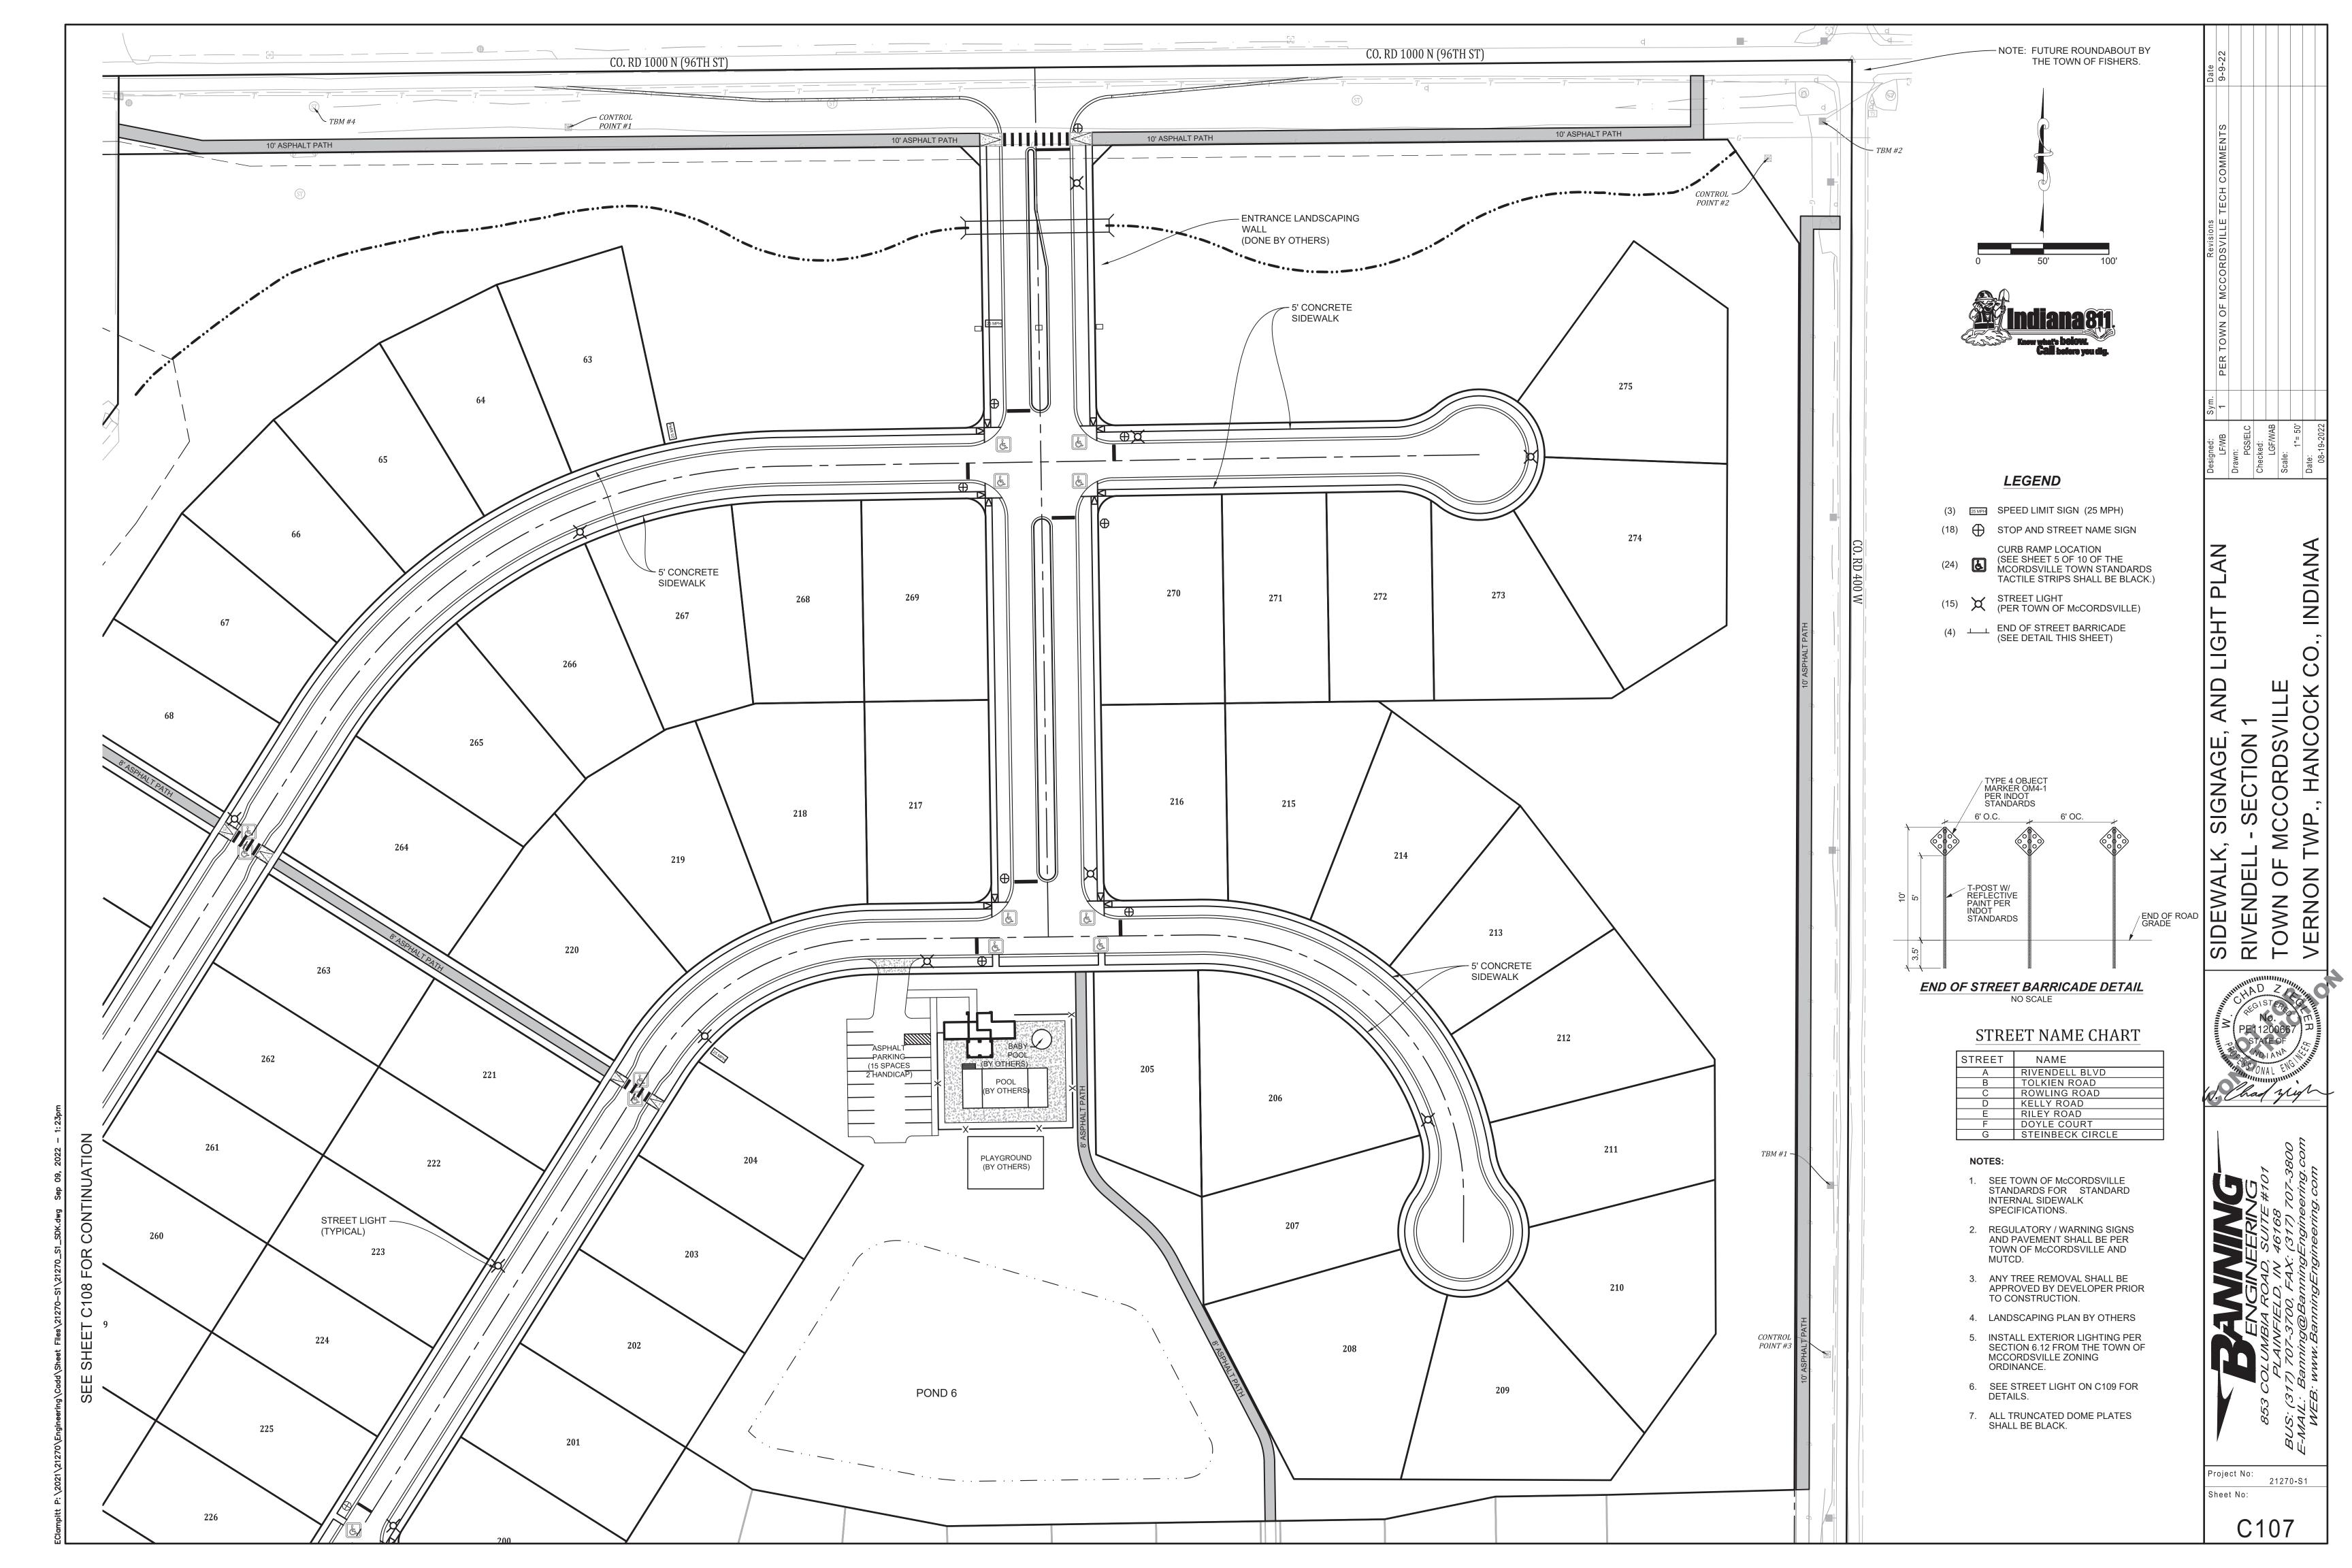

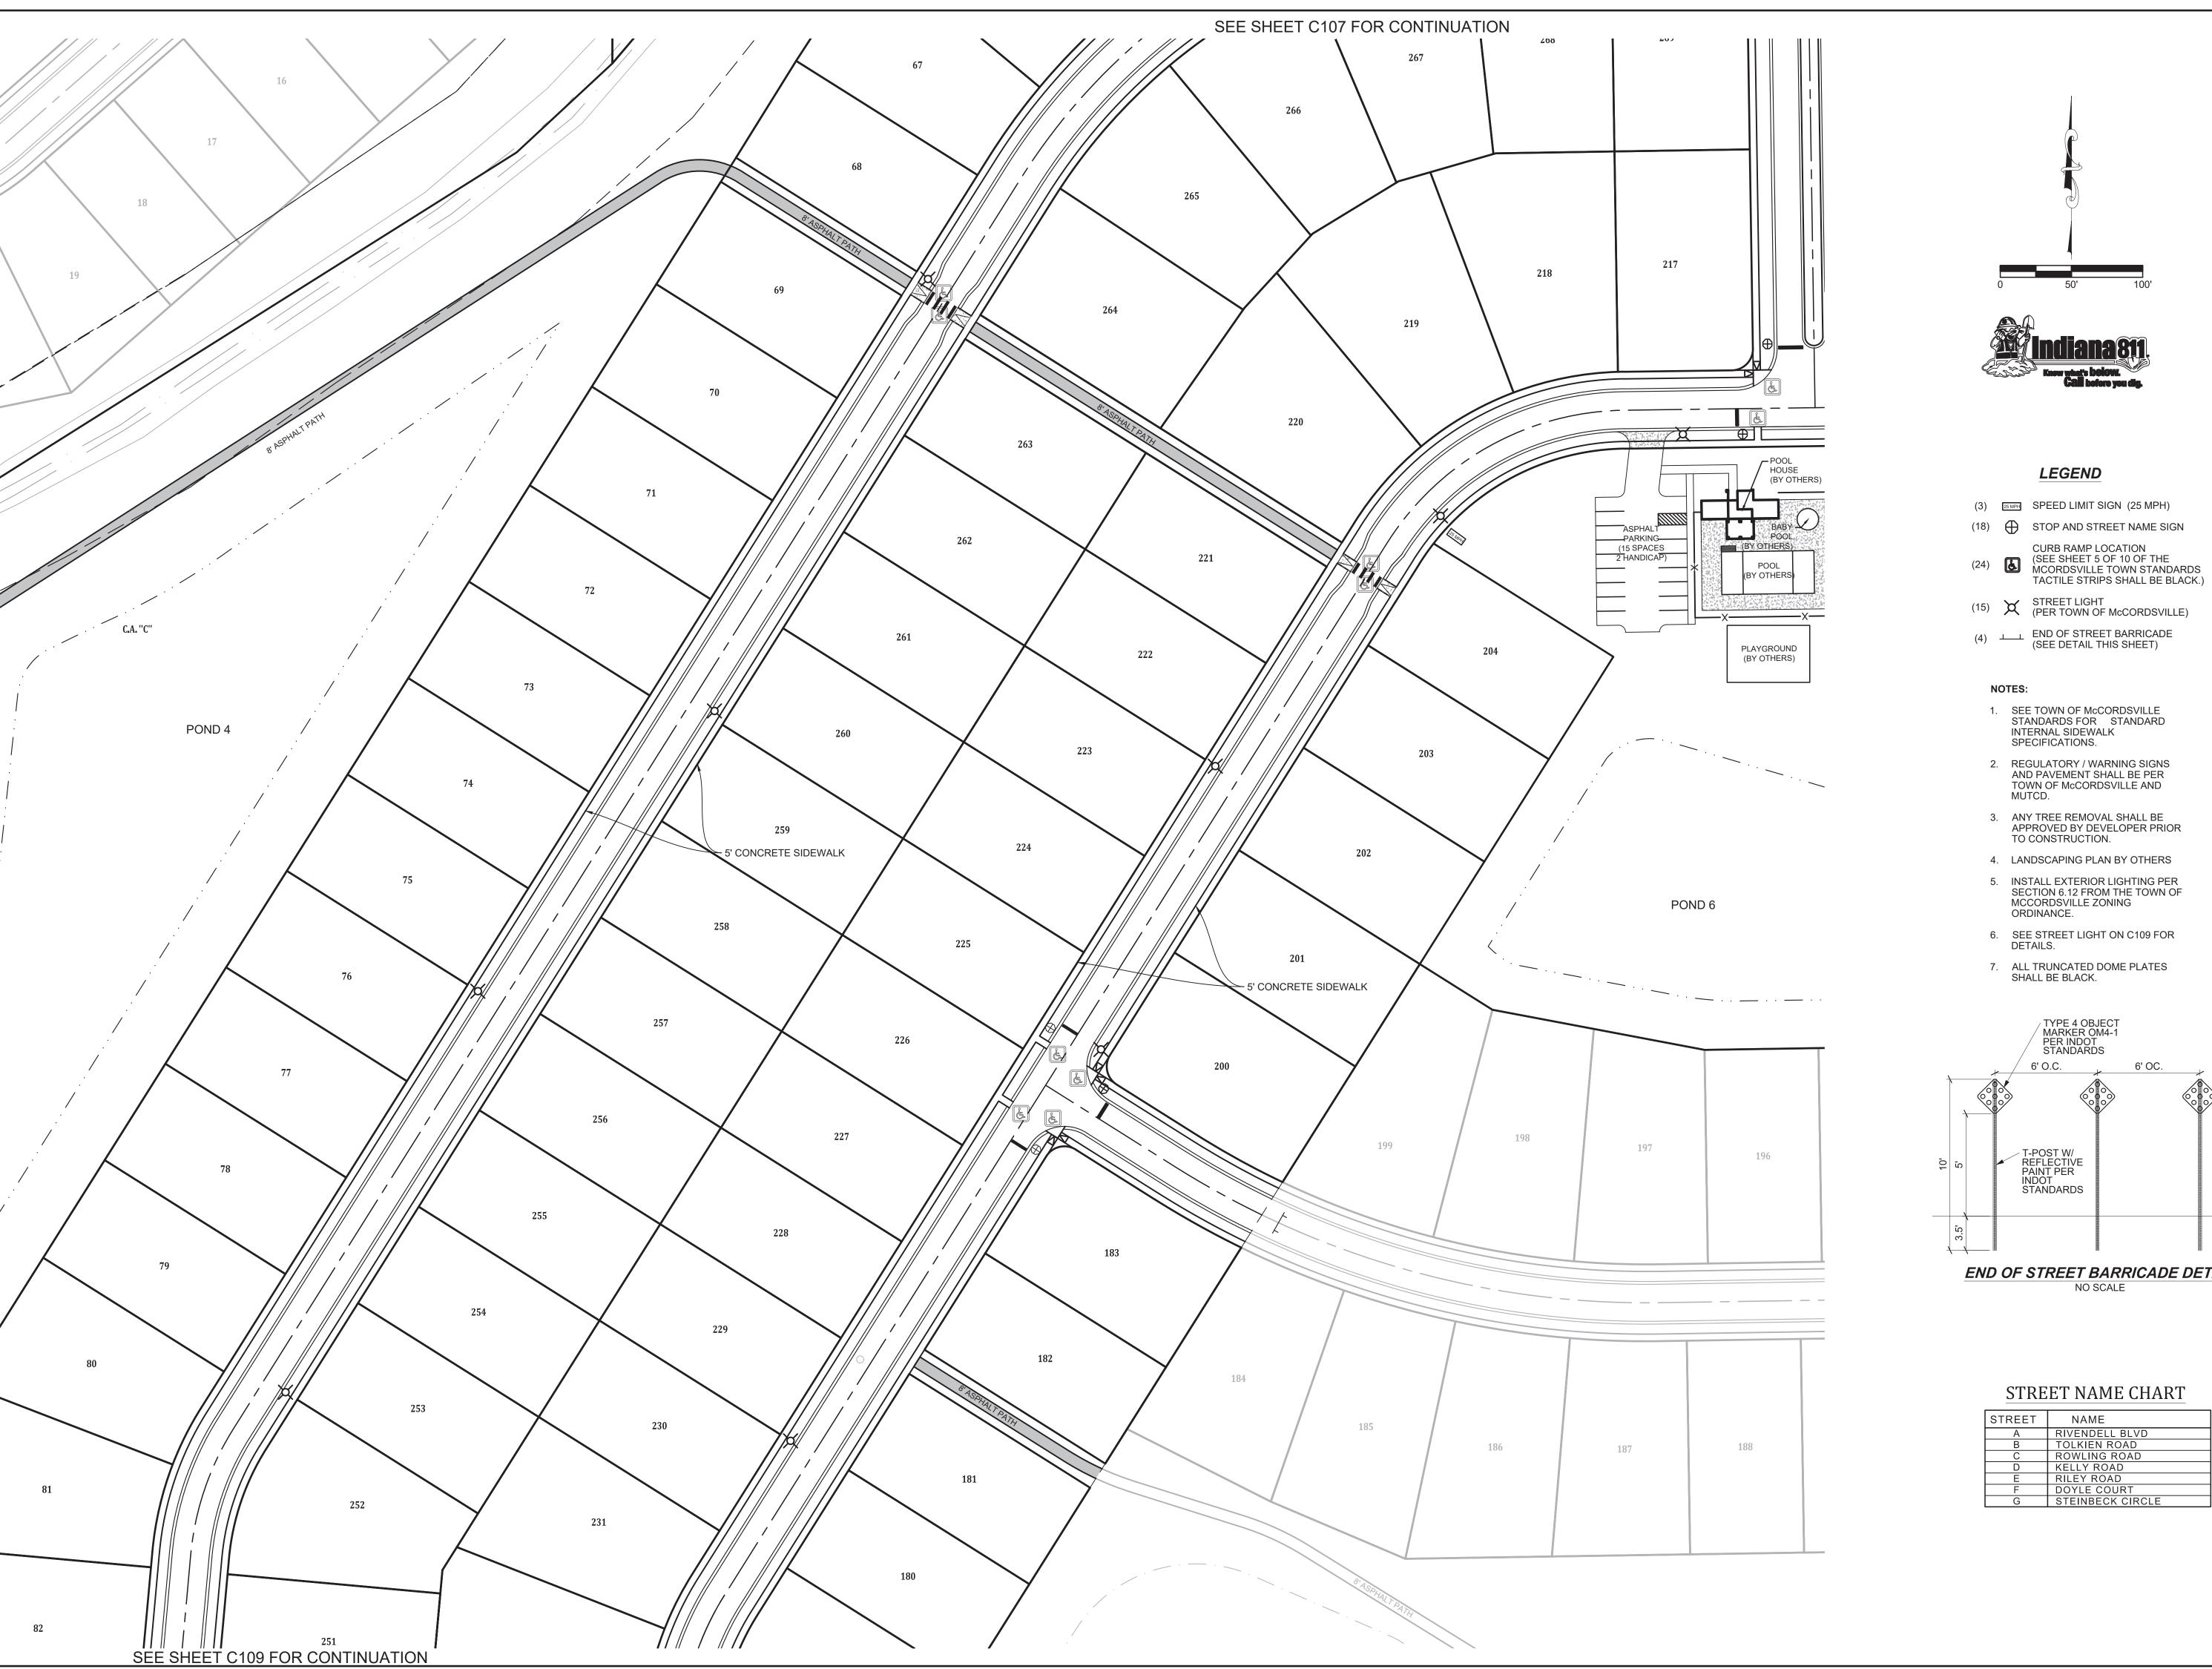


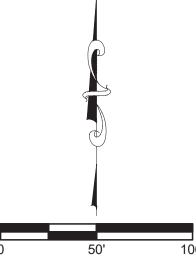



- (3) SPEED LIMIT SIGN (25 MPH)
- (18) STOP AND STREET NAME SIGN

- SEE TOWN OF McCORDSVILLE STANDARDS FOR STANDARD INTERNAL SIDEWALK SPECIFICATIONS.
- 2. REGULATORY / WARNING SIGNS AND PAVEMENT SHALL BE PER TOWN OF McCORDSVILLE AND MUTCD.
- 3. ANY TREE REMOVAL SHALL BE APPROVED BY DEVELOPER PRIOR
- 4. LANDSCAPING PLAN BY OTHERS
- INSTALL EXTERIOR LIGHTING PER SECTION 6.12 FROM THE TOWN OF MCCORDSVILLE ZONING ORDINANCE.
- 6. SEE STREET LIGHT ON C109 FOR DETAILS.

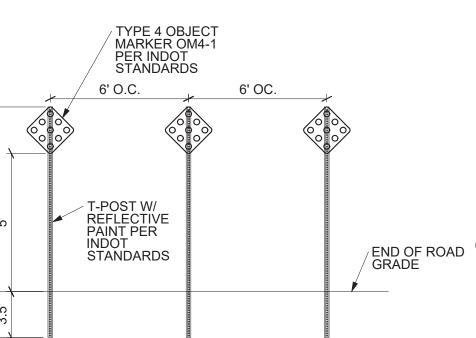

END OF STREET BARRICADE DETAIL
NO SCALE


STREET NAME CHART


STREET	NAME				
Α	RIVENDELL BLVD				
В	TOLKIEN ROAD				
С	ROWLING ROAD				
D	KELLY ROAD				
Е	RILEY ROAD				
F	DOYLE COURT				
G	STEINBECK CIRCLE				

SIDEWALK, SIGNAGE, AND I
RIVENDELL - SECTION 1
TOWN OF MCCORDSVILLE
VERNON TWP., HANCOCK C

21270**-**S1

C108

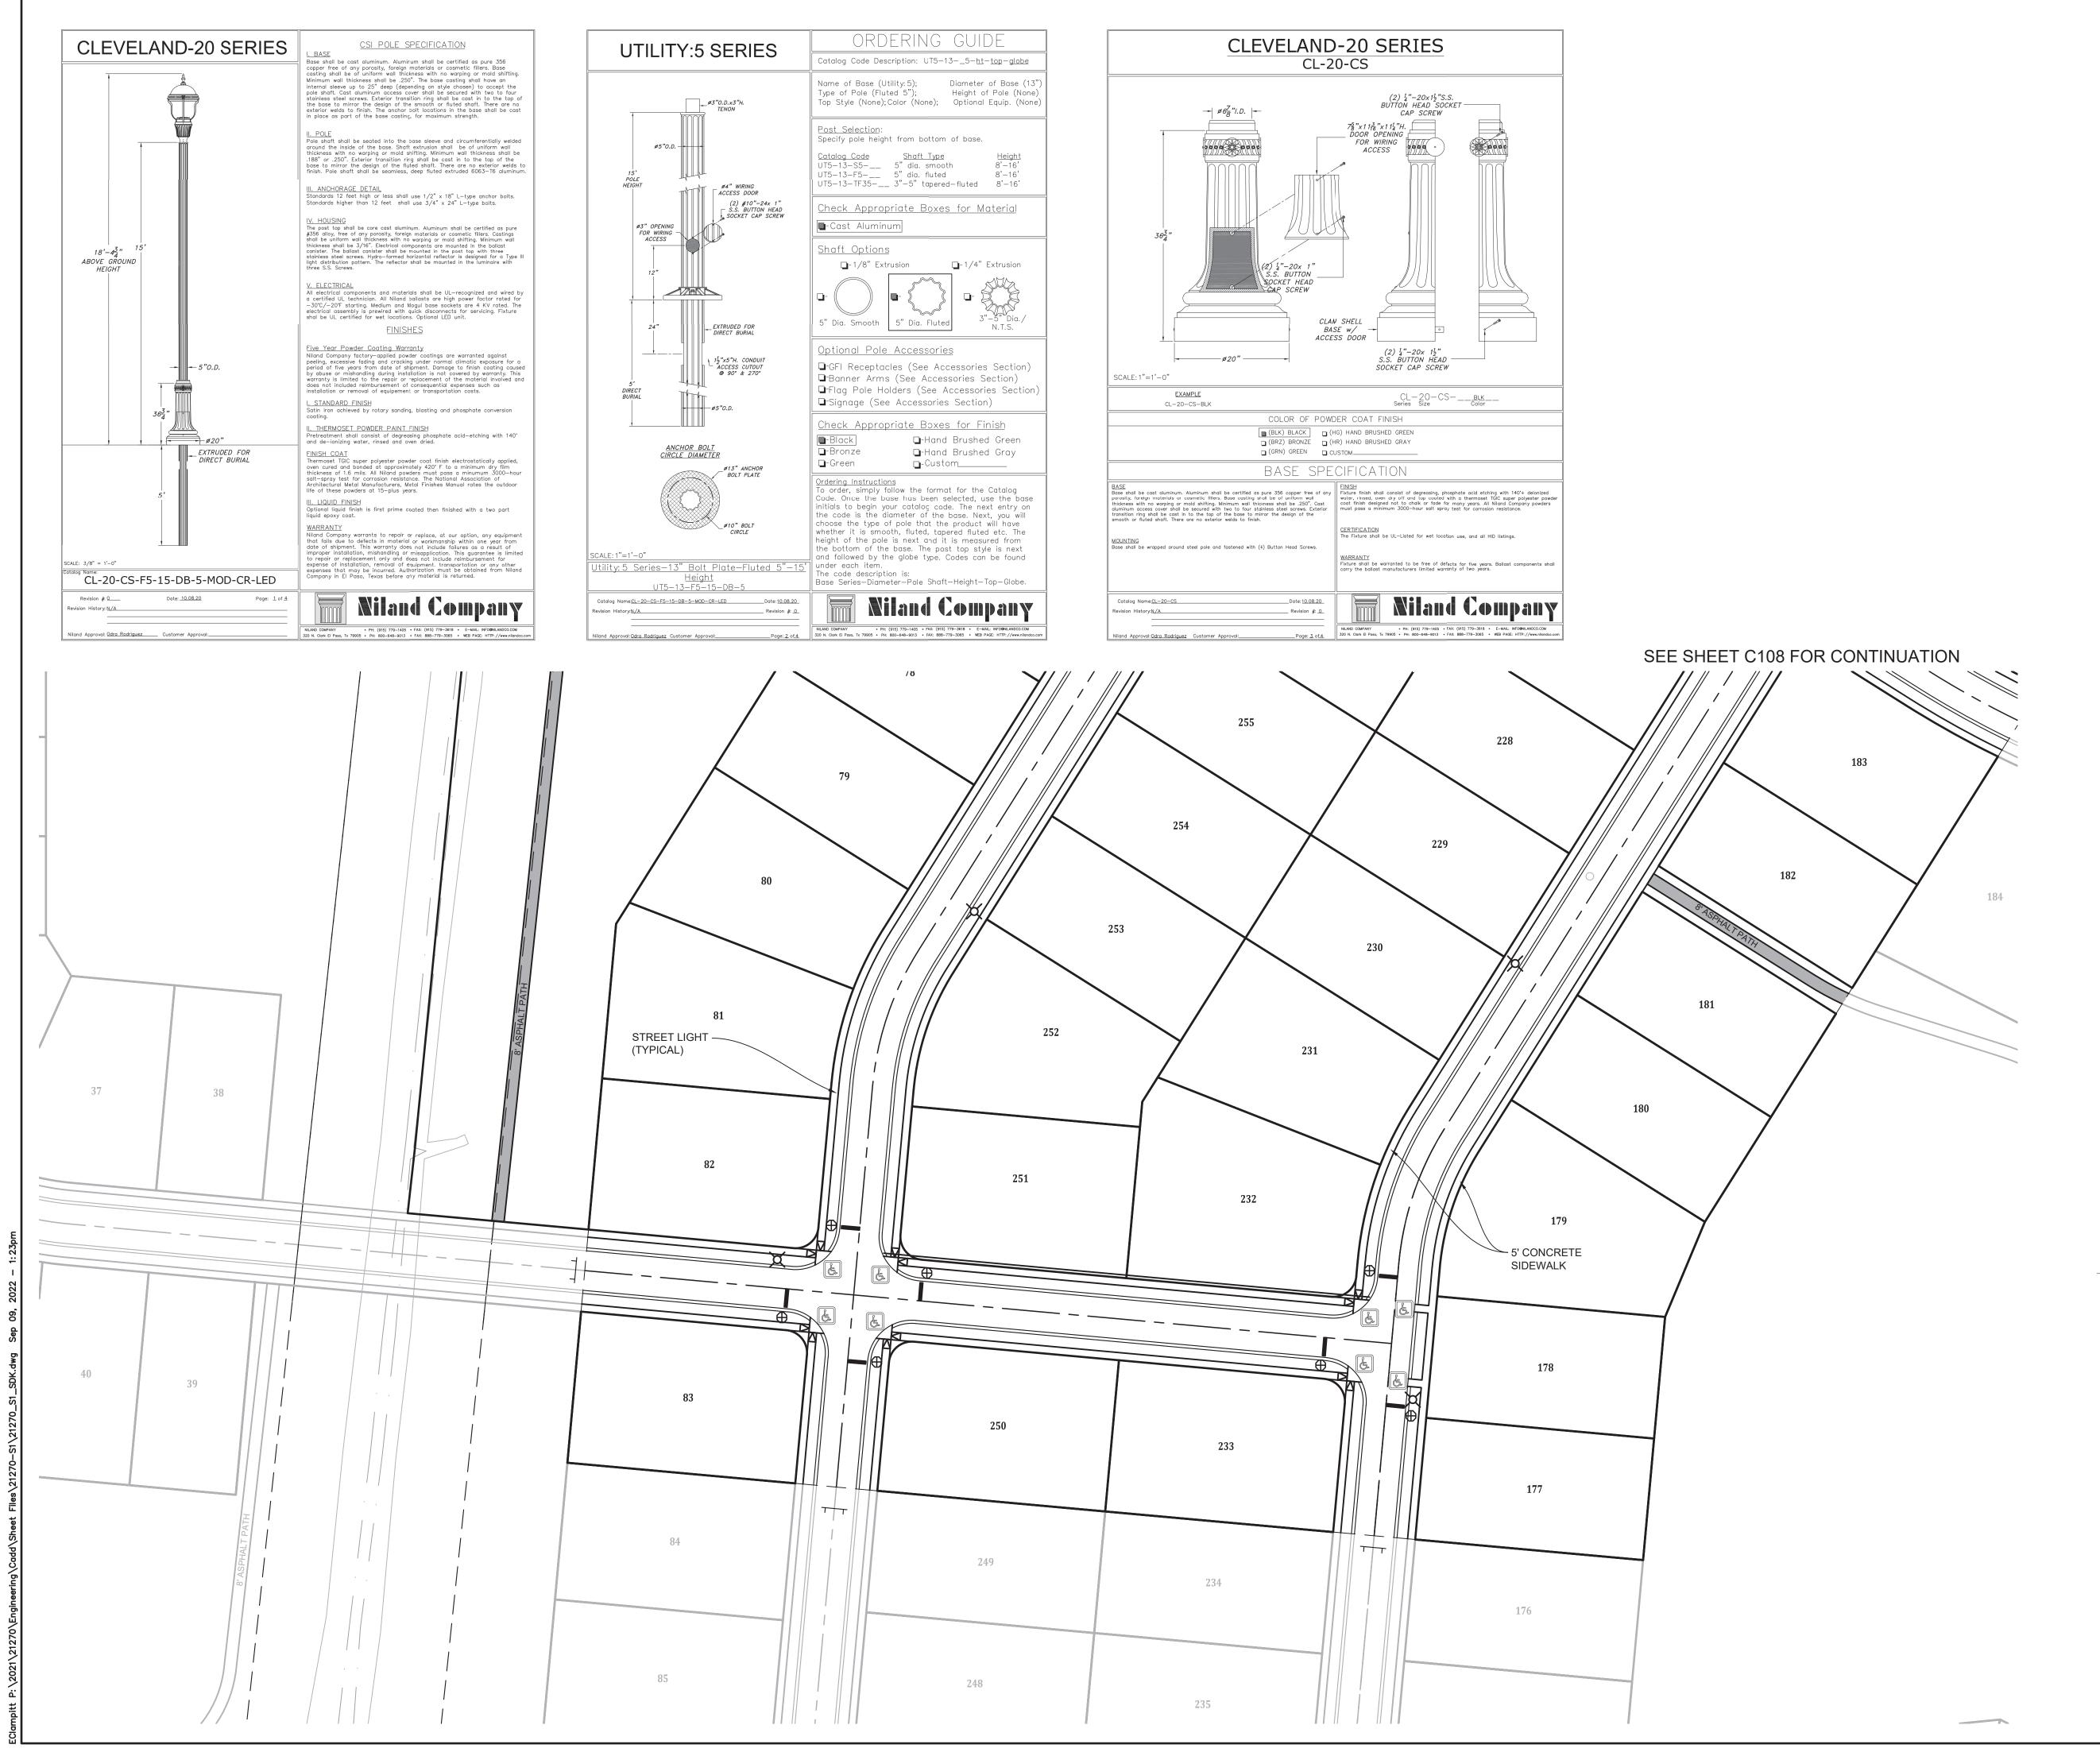

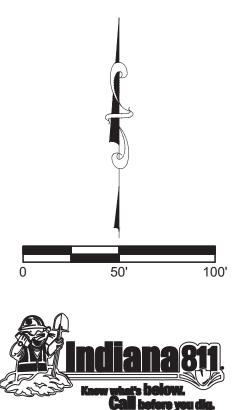

LEGEND

(3) SPEED LIMIT SIGN (25 MPH)

(18) STOP AND STREET NAME SIGN


(24) CURB RAMP LOCATION
(SEE SHEET 5 OF 10 OF THE
MCORDSVILLE TOWN STANDARDS
TACTILE STRIPS SHALL BE BLACK.)

(15) STREET LIGHT (PER TOWN OF McCORDSVILLE)

(4) LIND OF STREET BARRICADE (SEE DETAIL THIS SHEET)

NOTES:

- SEE TOWN OF McCORDSVILLE STANDARDS FOR STANDARD INTERNAL SIDEWALK SPECIFICATIONS.
- REGULATORY / WARNING SIGNS AND PAVEMENT SHALL BE PER TOWN OF McCORDSVILLE AND MUTCD.
- 3. ANY TREE REMOVAL SHALL BE APPROVED BY DEVELOPER PRIOR TO CONSTRUCTION.
- 4. LANDSCAPING PLAN BY OTHERS
- INSTALL EXTERIOR LIGHTING PER SECTION 6.12 FROM THE TOWN OF MCCORDSVILLE ZONING ORDINANCE.
- SEE STREET LIGHT ON C109 FOR DETAILS.
- 7. ALL TRUNCATED DOMES SHALL BE BLACK.

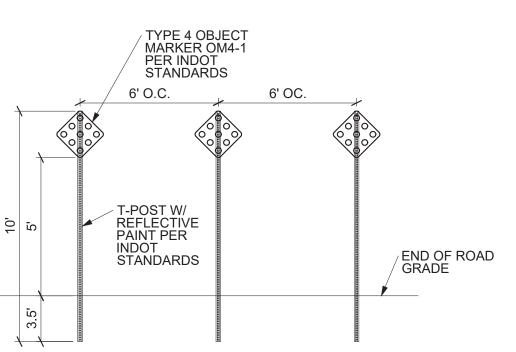

END OF STREET BARRICADE DETAIL
NO SCALE

STREET NAME CHART

STREET	NAME
А	RIVENDELL BLVD
В	TOLKIEN ROAD
С	ROWLING ROAD
D	KELLY ROAD
Е	RILEY ROAD
F	DOYLE COURT
G	STEINBECK CIRCLE

 Designed:
 Sym.
 Revisions

 LFWB
 1
 PER TOWN OF MCCORDSVILLE TECH CC

 Drawn:
 PGS/ELC
 Checked:

 Checked:
 LGFWAB
 Checked:

 LGFWAB
 Scale:
 Checked:

 1"= 50"
 Date:


SIDEWALK, SIGNAGE, AND LIGHT
RIVENDELL - SECTION 1
TOWN OF MCCORDSVILLE
VERNON TWP., HANCOCK CO., IN

PE11200667 D STATE OF STATE OF

ENGINEERING
853 COLUMBIA ROAD, SUITE #101
PLAINFIELD, IN 46168
US: (317) 707-3700, FAX: (317) 707-38

eet No:

C109

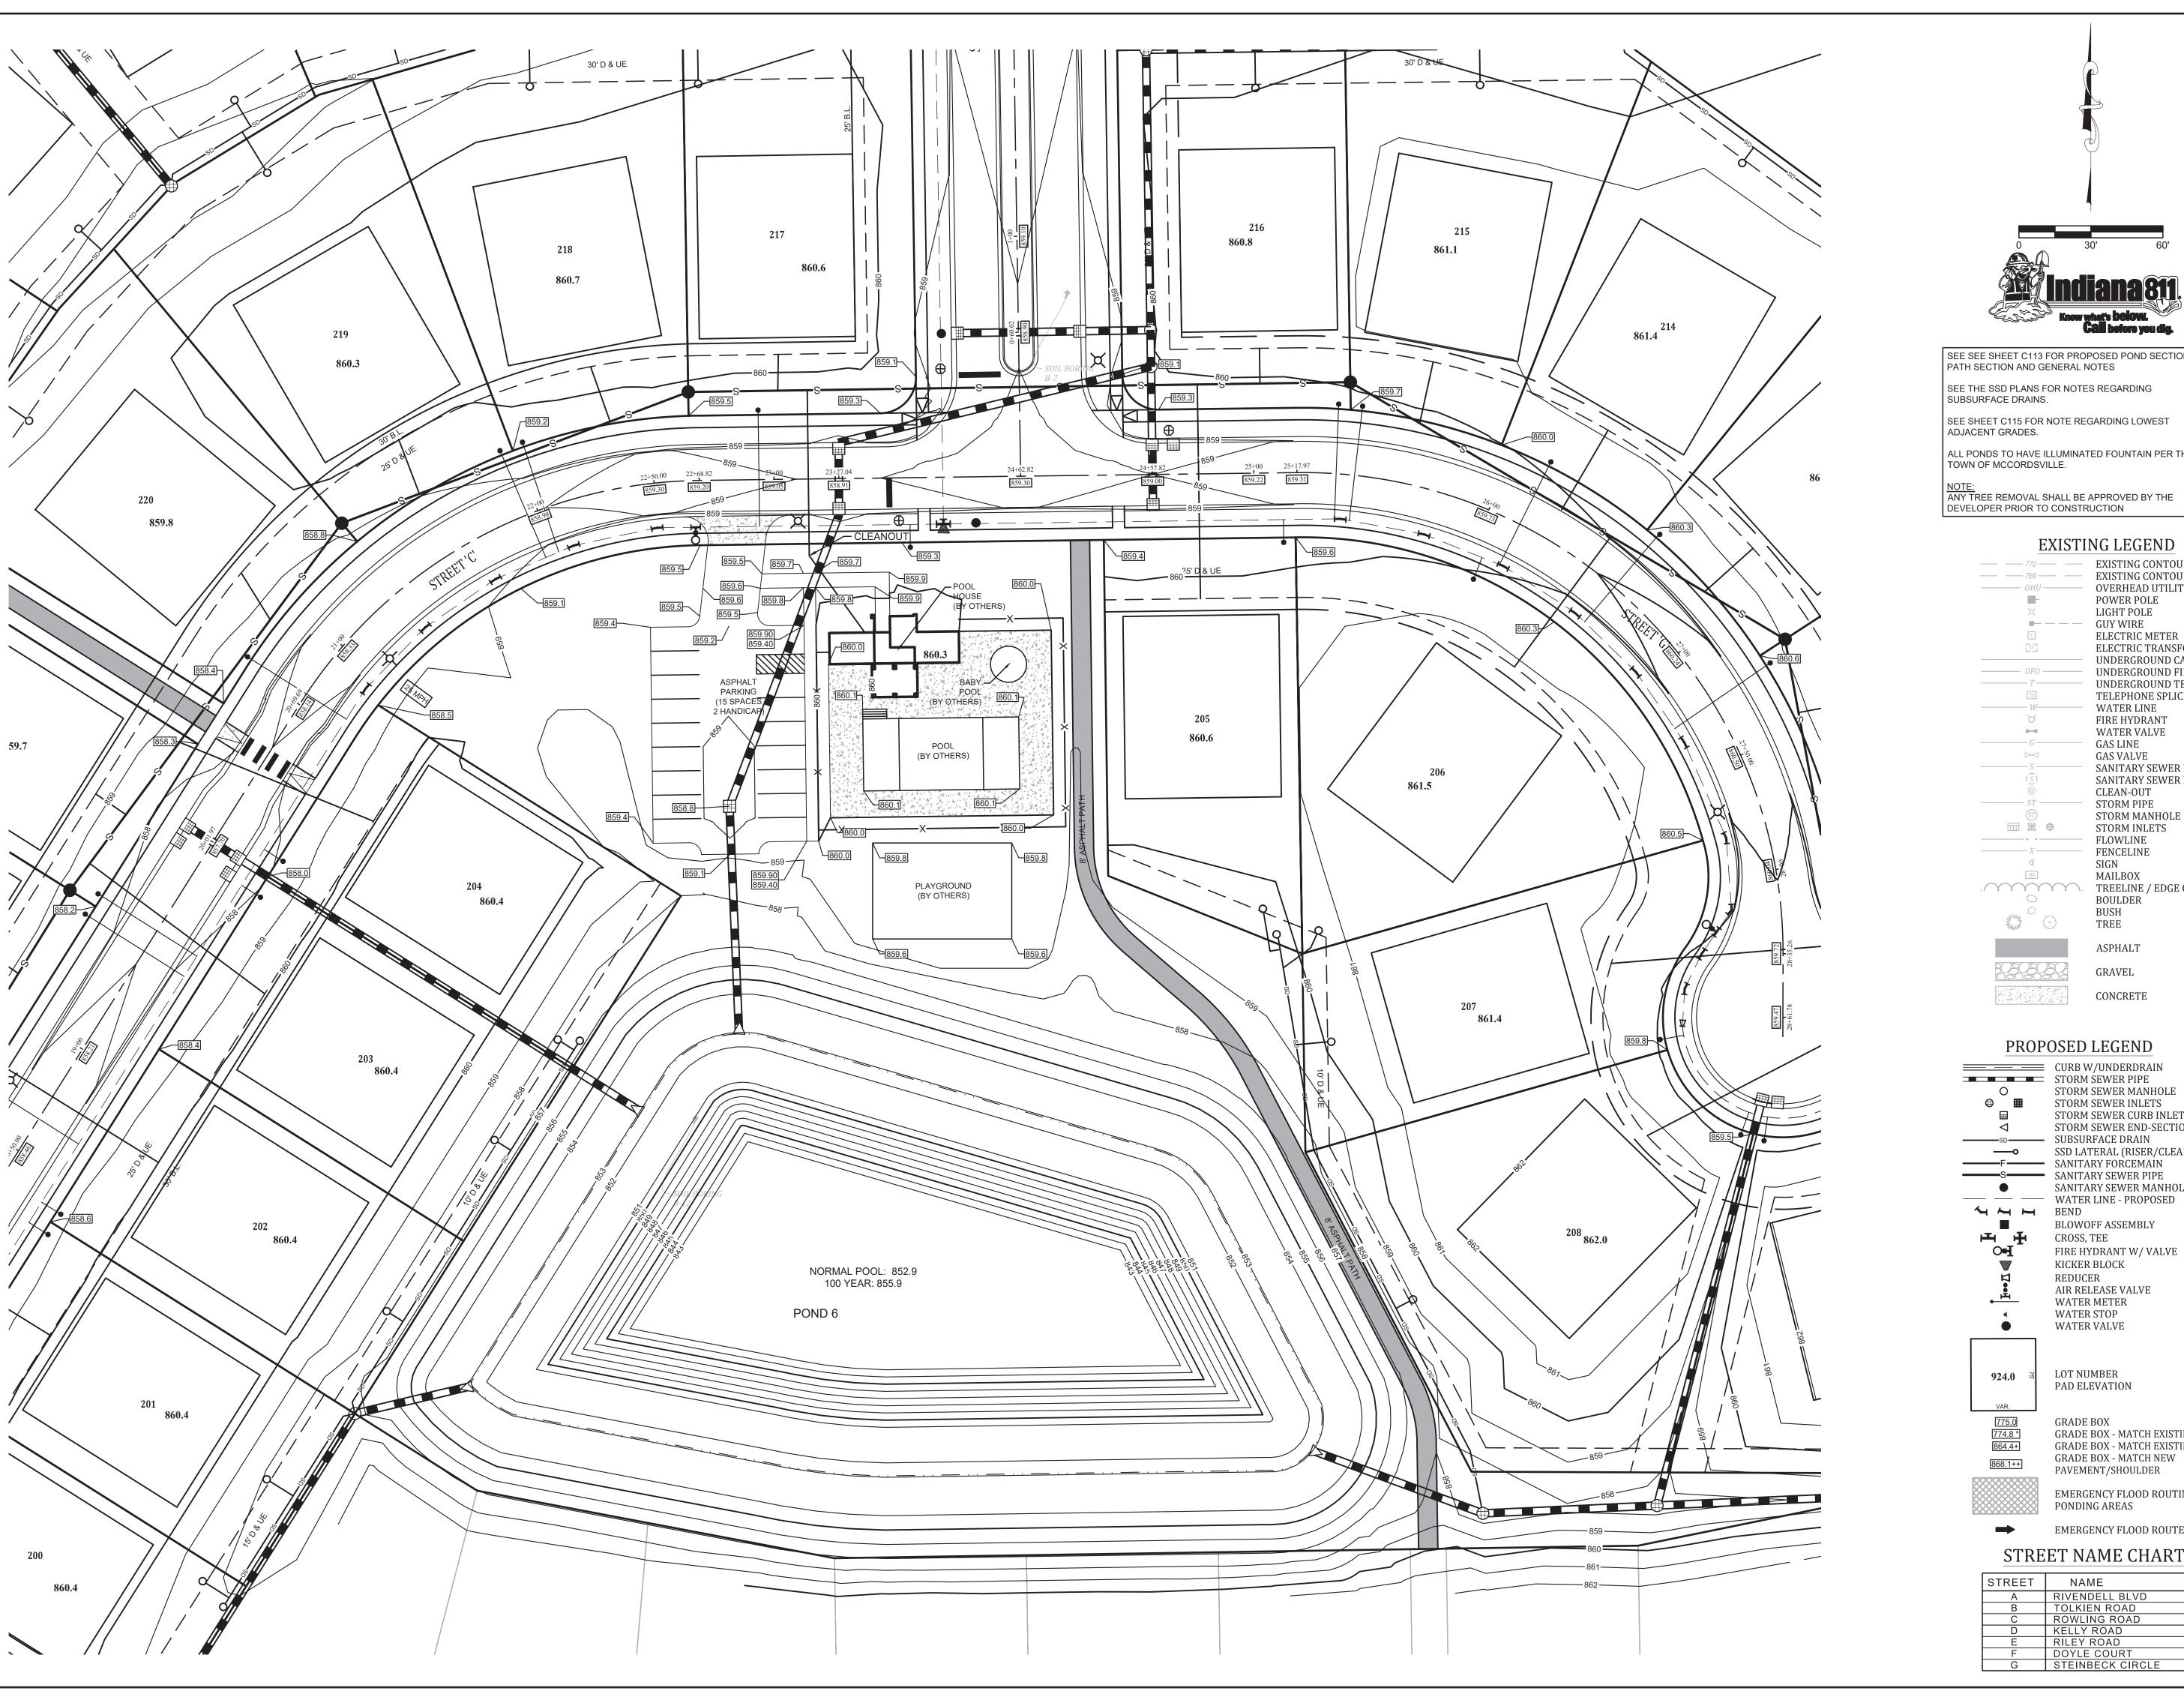



SEE SEE SHEET C113 FOR PROPOSED POND SECTIONS, PATH SECTION AND GENERAL NOTES

ALL PONDS TO HAVE ILLUMINATED FOUNTAIN PER THE TOWN OF MCCORDSVILLE.

EXISTING LEGEND

——————————————————————————————————————	EXISTING CONTOUR: MAJOR
<i>769</i>	EXISTING CONTOUR: MINOR
OHU	OVERHEAD UTILITY LINES
III -	POWER POLE
×	LIGHT POLE
•	GUY WIRE
E	ELECTRIC METER
ET	ELECTRIC TRANSFORMER
	UNDERGROUND CABLE TV
UFO	UNDERGROUND FIBER OPTIC
	UNDERGROUND TELEPHONE
TS	TELEPHONE SPLICE BOX
	WATER LINE
abla	FIRE HYDRANT
	WATER VALVE
<i>G</i>	GAS LINE
	GAS VALVE
	SANITARY SEWER LINE
(<u>S</u>)	SANITARY SEWER MANHOLE
	CLEAN-OUT
ST	STORM PIPE
ST	STORM MANHOLE
Ⅲ Ⅲ ●	STORM INLETS
• • •	FLOWLINE
X	FENCELINE
q	SIGN
MB	MAILBOX
.~~~	TREELINE / EDGE OF WOODS
	BOULDER
WW.	BUSH
English (c)	TREE

ASPHALT

GRAVEL

CONCRETE

	CURB W/UNDERDRAIN
	STORM SEWER PIPE
0	STORM SEWER MANHOLE
₩ ##	STORM SEWER INLETS
	STORM SEWER CURB INLET
◁	STORM SEWER END-SECTION
SD	SUBSURFACE DRAIN
	SSD LATERAL (RISER/CLEAN (
——F——	SANITARY FORCEMAIN
s	SANITARY SEWER PIPE
	SANITARY SEWER MANHOLE
	WATER LINE - PROPOSED
444	BEND
	BLOWOFF ASSEMBLY
平 千	CROSS, TEE

W/UNDERDRAIN I SEWER PIPE SEWER MANHOLE SEWER INLETS I SEWER CURB INLET I SEWER END-SECTION RFACE DRAIN TERAL (RISER/CLEAN OUTS) ARY FORCEMAIN ARY SEWER PIPE

R LINE - PROPOSED CROSS, TEE

OFF ASSEMBLY FIRE HYDRANT W/ VALVE KICKER BLOCK REDUCER AIR RELEASE VALVE

WATER VALVE

LOT NUMBER PAD ELEVATION

WATER METER

WATER STOP

GRADE BOX GRADE BOX - MATCH EXISTING GRADE BOX - MATCH EXISTING PAVEMENT GRADE BOX - MATCH NEW PAVEMENT/SHOULDER




EMERGENCY FLOOD ROUTING PONDING AREAS

STREET NAME CHART

STREET WINE CHIRC			
STREET	NAME		
Α	RIVENDELL BLVD		
В	TOLKIEN ROAD		
С	ROWLING ROAD		
D	KELLY ROAD		
Е	RILEY ROAD		
F	DOYLE COURT		
G	STEINBECK CIRCLE		

CORDSVILLE HANCOCK = MCCC TWP., AMENITY PI RIVENDELL . TOWN OF M VERNON TV

Project No: 21270-S1 Sheet No:

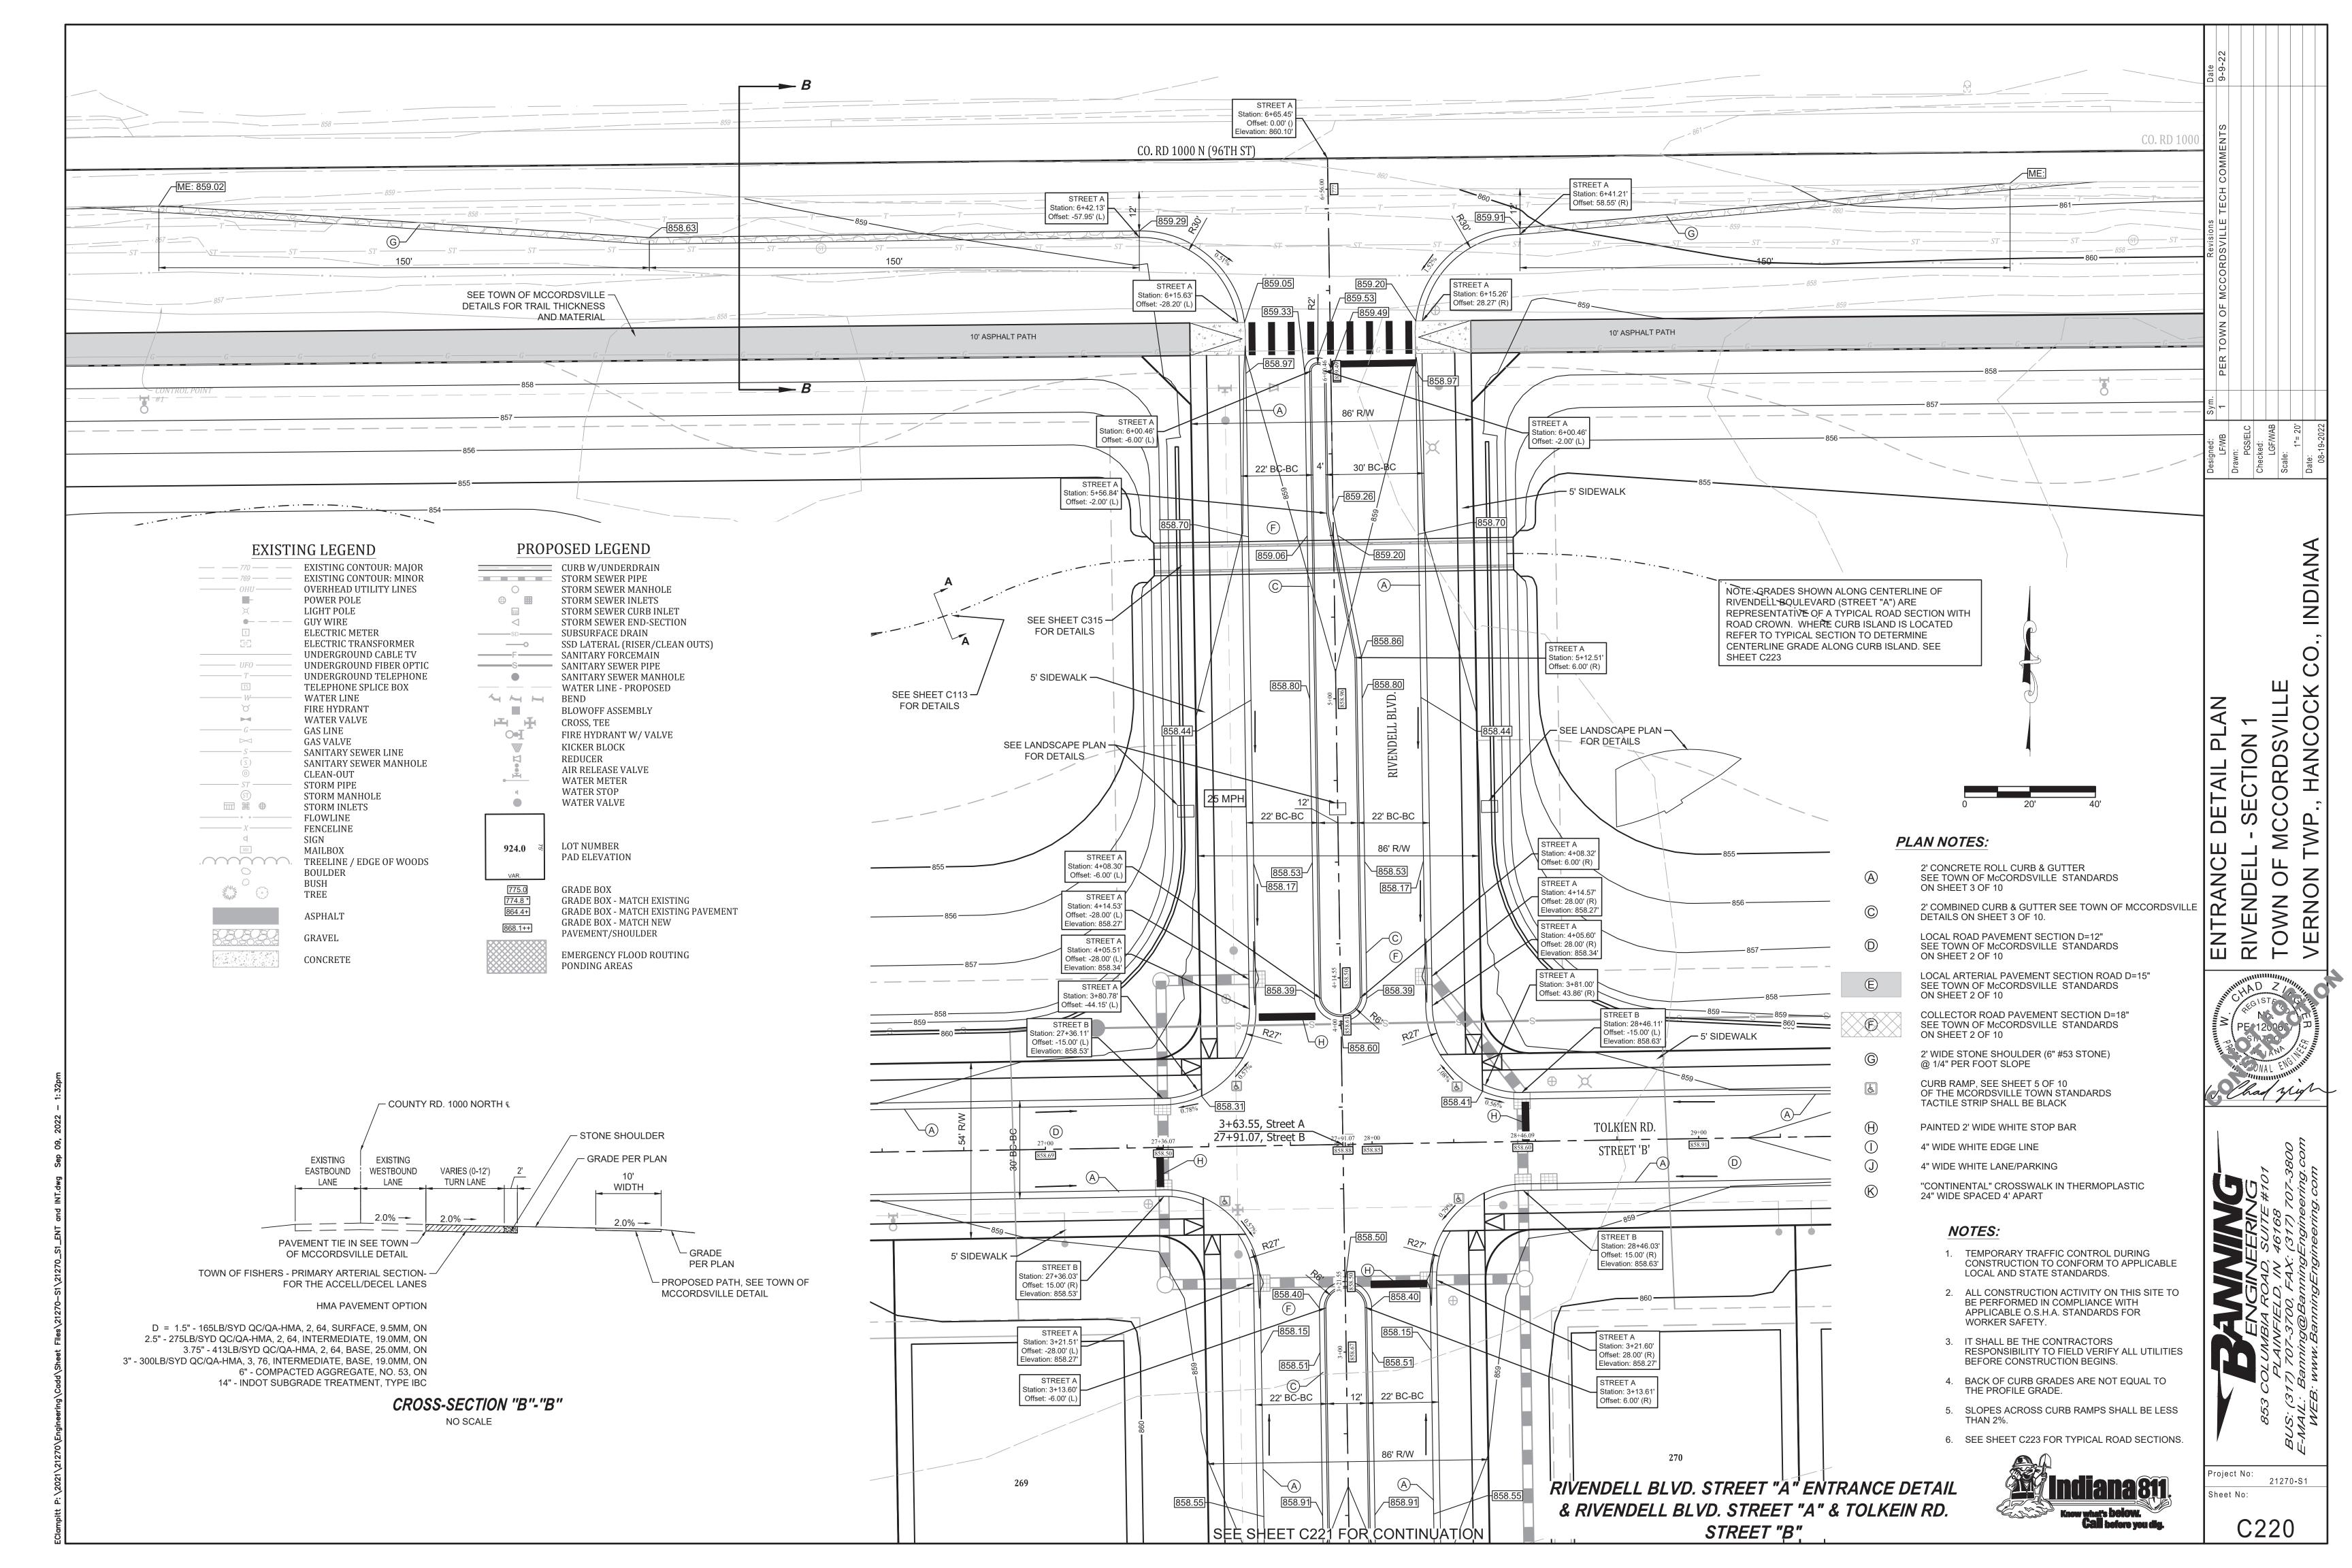

& RIVENDELL BLVD. STREET "A" & ROWLING RD. STREET "C" INTERSECTION DETAIL

PROPOSED LEGEND

STORM SEWER MANHOLE

SANITARY SEWER MANHOLE

WATER LINE - PROPOSED

FIRE HYDRANT W/ VALVE

BLOWOFF ASSEMBLY

AIR RELEASE VALVE

CROSS, TEE

REDUCER

KICKER BLOCK

WATER METER WATER STOP

WATER VALVE

LOT NUMBER

GRADE BOX

PAD ELEVATION

GRADE BOX - MATCH EXISTING

EMERGENCY FLOOD ROUTING

EMERGENCY FLOOD ROUTE

GRADE BOX - MATCH NEW

PAVEMENT/SHOULDER

PONDING AREAS

GRADE BOX - MATCH EXISTING PAVEMENT

STORM SEWER INLETS STORM SEWER CURB INLET STORM SEWER END-SECTION

STORM SEWER PIPE

———F——— SANITARY FORCEMAIN SANITARY SEWER PIPE

444

924.0

NOTE: GRADES SHOWN ALONG CENTERLINE OF RIVENDELL BOULEVARD (STREET "A") ARE REPRESENTATIVE OF A TYPICAL ROAD SECTION WITH ROAD CROWN. WHERE CURB ISLAND IS LOCATED REFER TO TYPICAL SECTION TO DETERMINE CENTERLINE GRADE ALONG CURB ISLAND.

EVICTING I ECEND

EXISTING LEGEND					
<i>770</i>	EXISTING CONTOUR: MAJOR				
<i>769</i>	EXISTING CONTOUR: MINOR				
OHU	OVERHEAD UTILITY LINES				
III-	POWER POLE				
×	LIGHT POLE				
•	GUY WIRE				
E	ELECTRIC METER				
ET	ELECTRIC TRANSFORMER				
	UNDERGROUND CABLE TV				
UFO	UNDERGROUND FIBER OPTIC				
	UNDERGROUND TELEPHONE				
TS	TELEPHONE SPLICE BOX				
	WATER LINE				
X	FIRE HYDRANT				
M	WATER VALVE				
——— G ———	GAS LINE				
	GAS VALVE				
	SANITARY SEWER LINE				
(<u>S</u>)	SANITARY SEWER MANHOLE				
	CLEAN-OUT				
ST	STORM PIPE				
(ST)	STORM MANHOLE				
□ ●	STORM INLETS				
• • •	FLOWLINE				
X	FENCELINE				
q [MB]	SIGN				
NID.	MAILBOX				
./ 1 1 1 1 1 1 1 1 .	TREELINE / EDGE OF WOODS				
	BOULDER				
AMA (C)	BUSH TREE				
ZYWW C	TREE				
	ASPHALT				

CONCRETE

PLAN NOTES:

A	2' CONCRETE ROLL CURB & GUTTER SEE TOWN OF McCORDSVILLE STANDARDS ON SHEET 3 OF 10
©	2' COMBINED CURB & GUTTER SEE TOWN OF MCCORDSVILLI DETAILS ON SHEET 3 OF 10.
(D)	LOCAL ROAD PAVEMENT SECTION D=12" SEE TOWN OF McCORDSVILLE STANDARDS

LOCAL ARTERIAL PAVEMENT SECTION ROAD D=15" SEE TOWN OF McCORDSVILLE STANDARDS ON SHEET 2 OF 10 COLLECTOR ROAD PAVEMENT SECTION D=18"

ON SHEET 2 OF 10

SEE TOWN OF McCORDSVILLE STANDARDS ON SHEET 2 OF 10 2' WIDE STONE SHOULDER (6" #53 STONE) @ 1/4" PER FOOT SLOPE

CURB RAMP, SEE SHEET 5 OF 10 OF THE MCORDSVILLE TOWN STANDARDS TACTILE STRIP SHALL BE BLACK

PAINTED 2' WIDE WHITE STOP BAR 4" WIDE WHITE EDGE LINE


> 4" WIDE WHITE LANE/PARKING "CONTINENTAL" CROSSWALK IN THERMOPLASTIC 24" WIDE SPACED 4' APART

NOTES:


- TEMPORARY TRAFFIC CONTROL DURING CONSTRUCTION TO CONFORM TO APPLICABLE LOCAL AND STATE STANDARDS.
- 3. IT SHALL BE THE CONTRACTORS RESPONSIBILITY TO FIELD VERIFY ALL UTILITIES BEFORE CONSTRUCTION BEGINS.
- 4. BACK OF CURB GRADES ARE NOT EQUAL TO THE PROFILE GRADE.
- 5. SLOPES ACROSS CURB RAMPS SHALL BE LESS

2. ALL CONSTRUCTION ACTIVITY ON THIS SITE TO BE PERFORMED IN COMPLIANCE WITH APPLICABLE O.S.H.A. STANDARDS FOR WORKER SAFETY.

6. SEE SHEET C223 FOR TYPICAL ROAD SECTIONS.

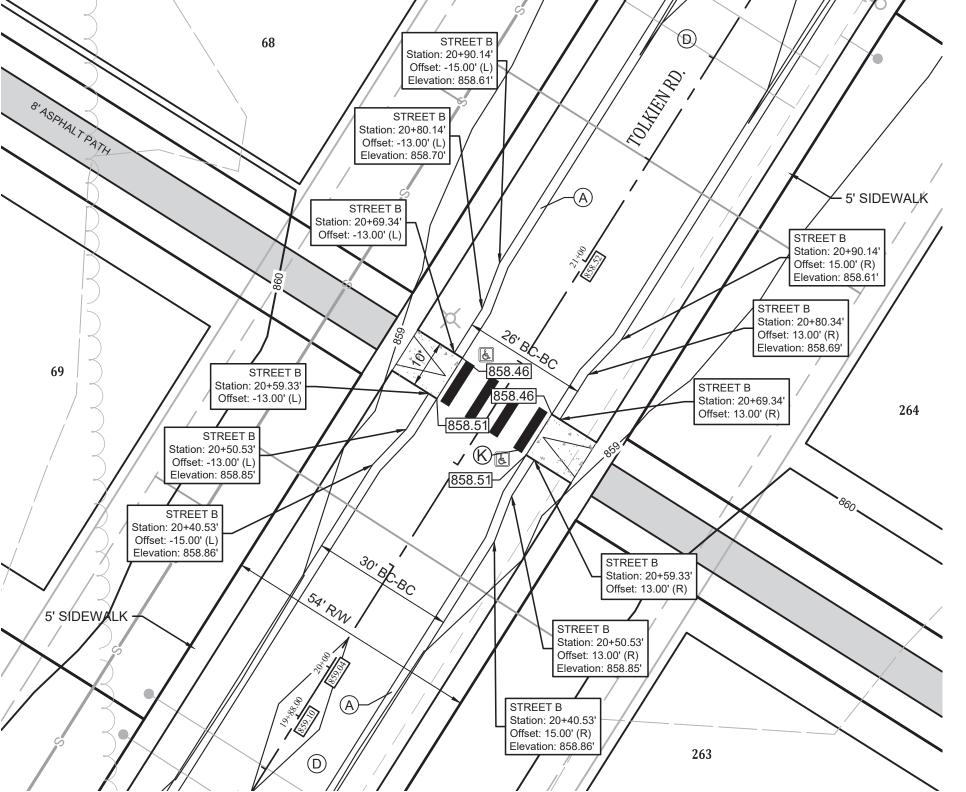

TOLKIEN RD. STREET "A" DECELERATION OFFSET

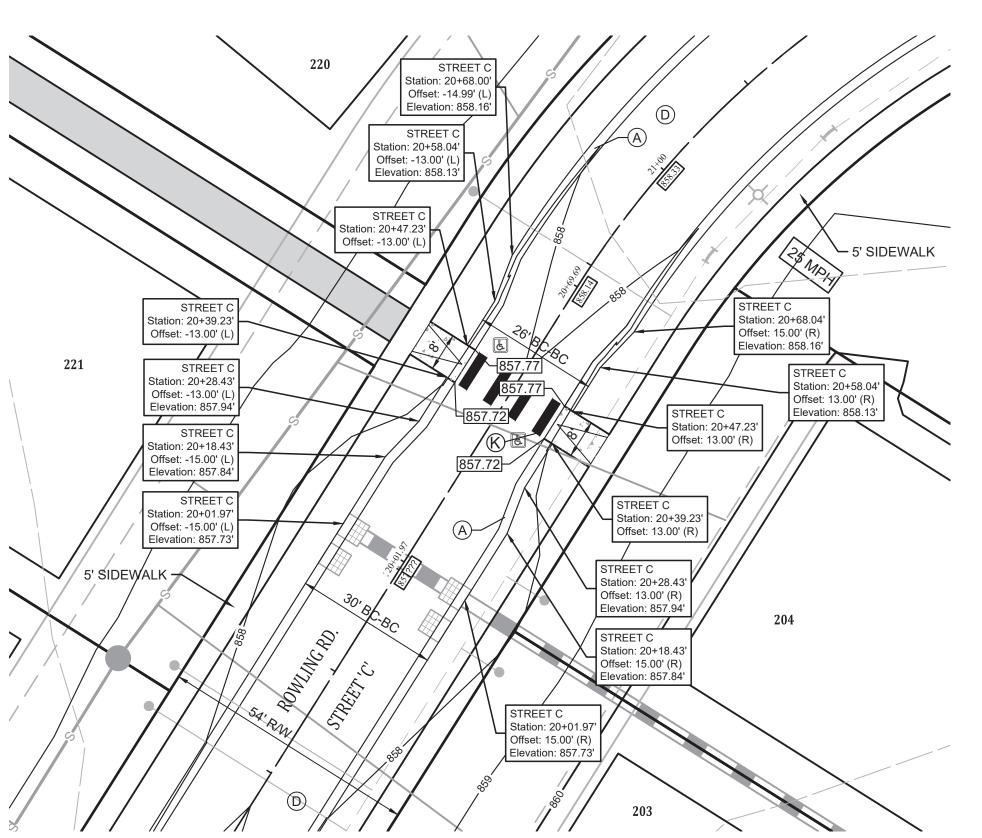

ROWLING RD. STREET "C" DECELERATION OFFSET




21270-S1

ORDSVILLE

- MCCC TWP.,

ENTRANCE
RIVENDELL
TOWN OF M
VERNON TV

HANCOCK

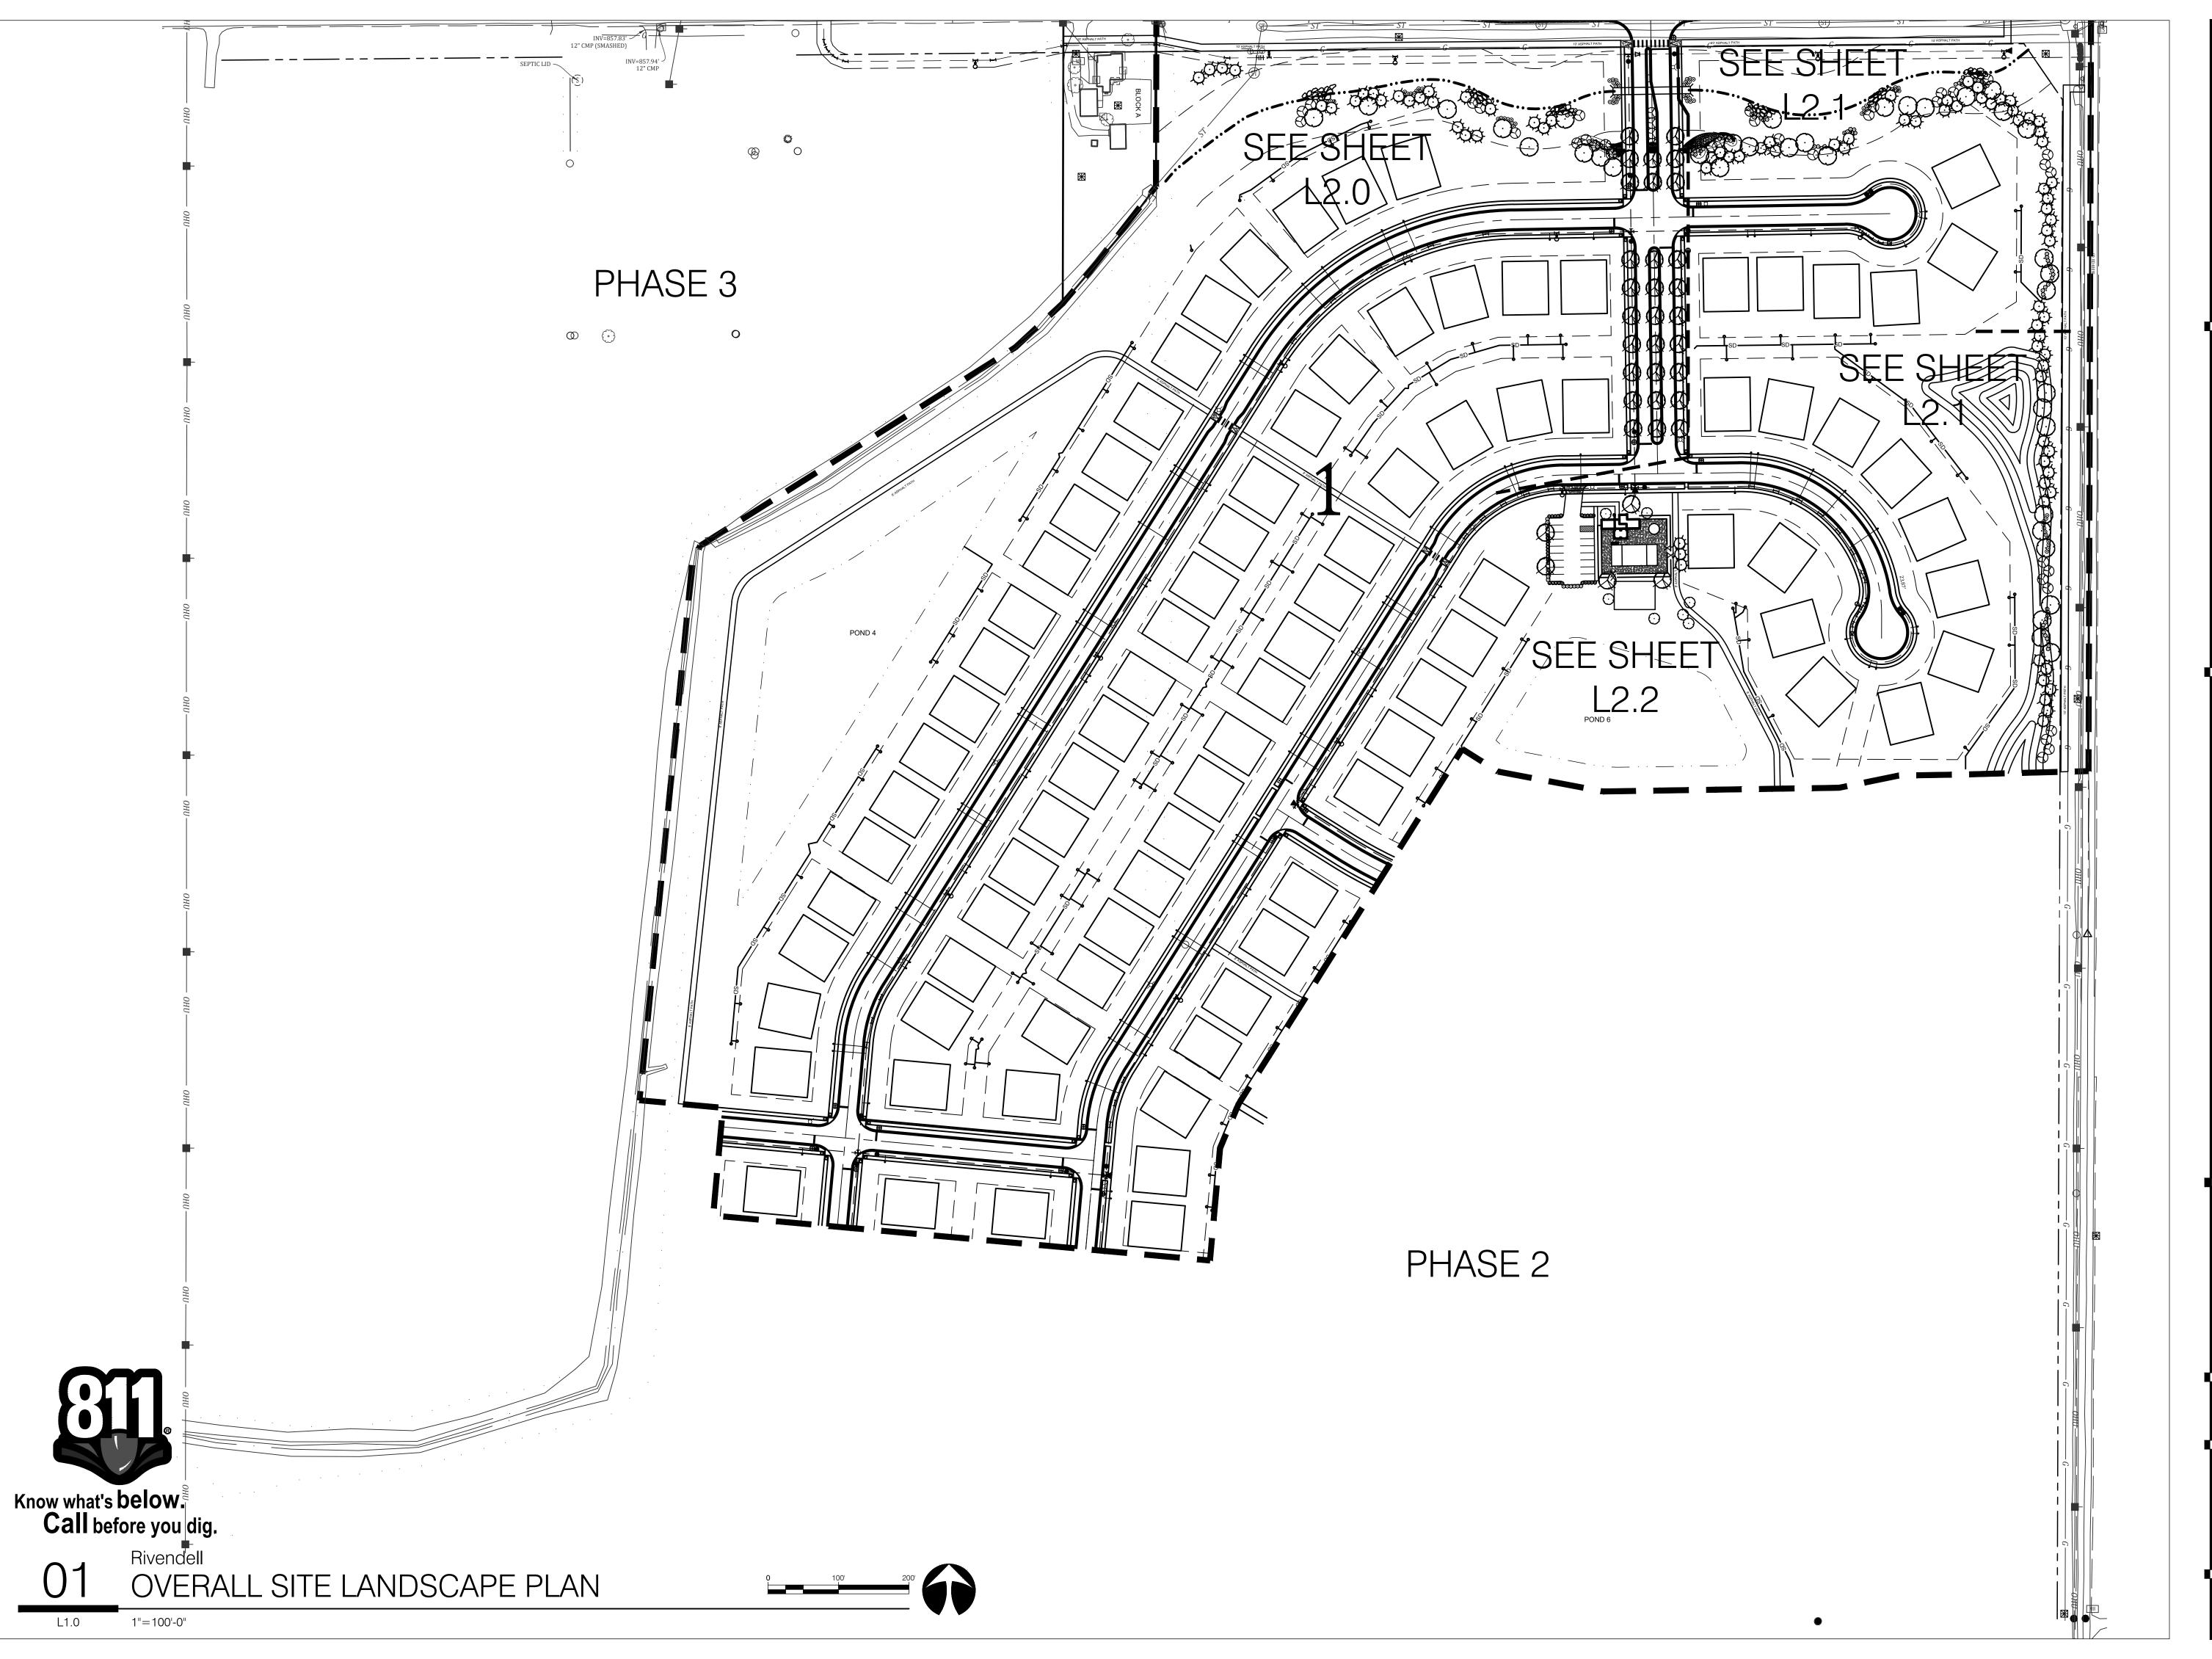

PP

design group, llc

landscape
architecture

+

planning
professionals

317.258.5229

jlapp@lappdesigngroup.com

Consultants

Project Info Rivendell

McCordsville, IN

OKLINIKA RICHINA RICHI

Drawing Scope

OVERALL SITE
LANDSCAPE PLAN
Drawing Info

 Drawn:
 JML

 Checked:
 JML


 Date:
 03/25/2022

 Project No:
 21540

 Revision:
 09/09/2022

Sheet No.

L1.0

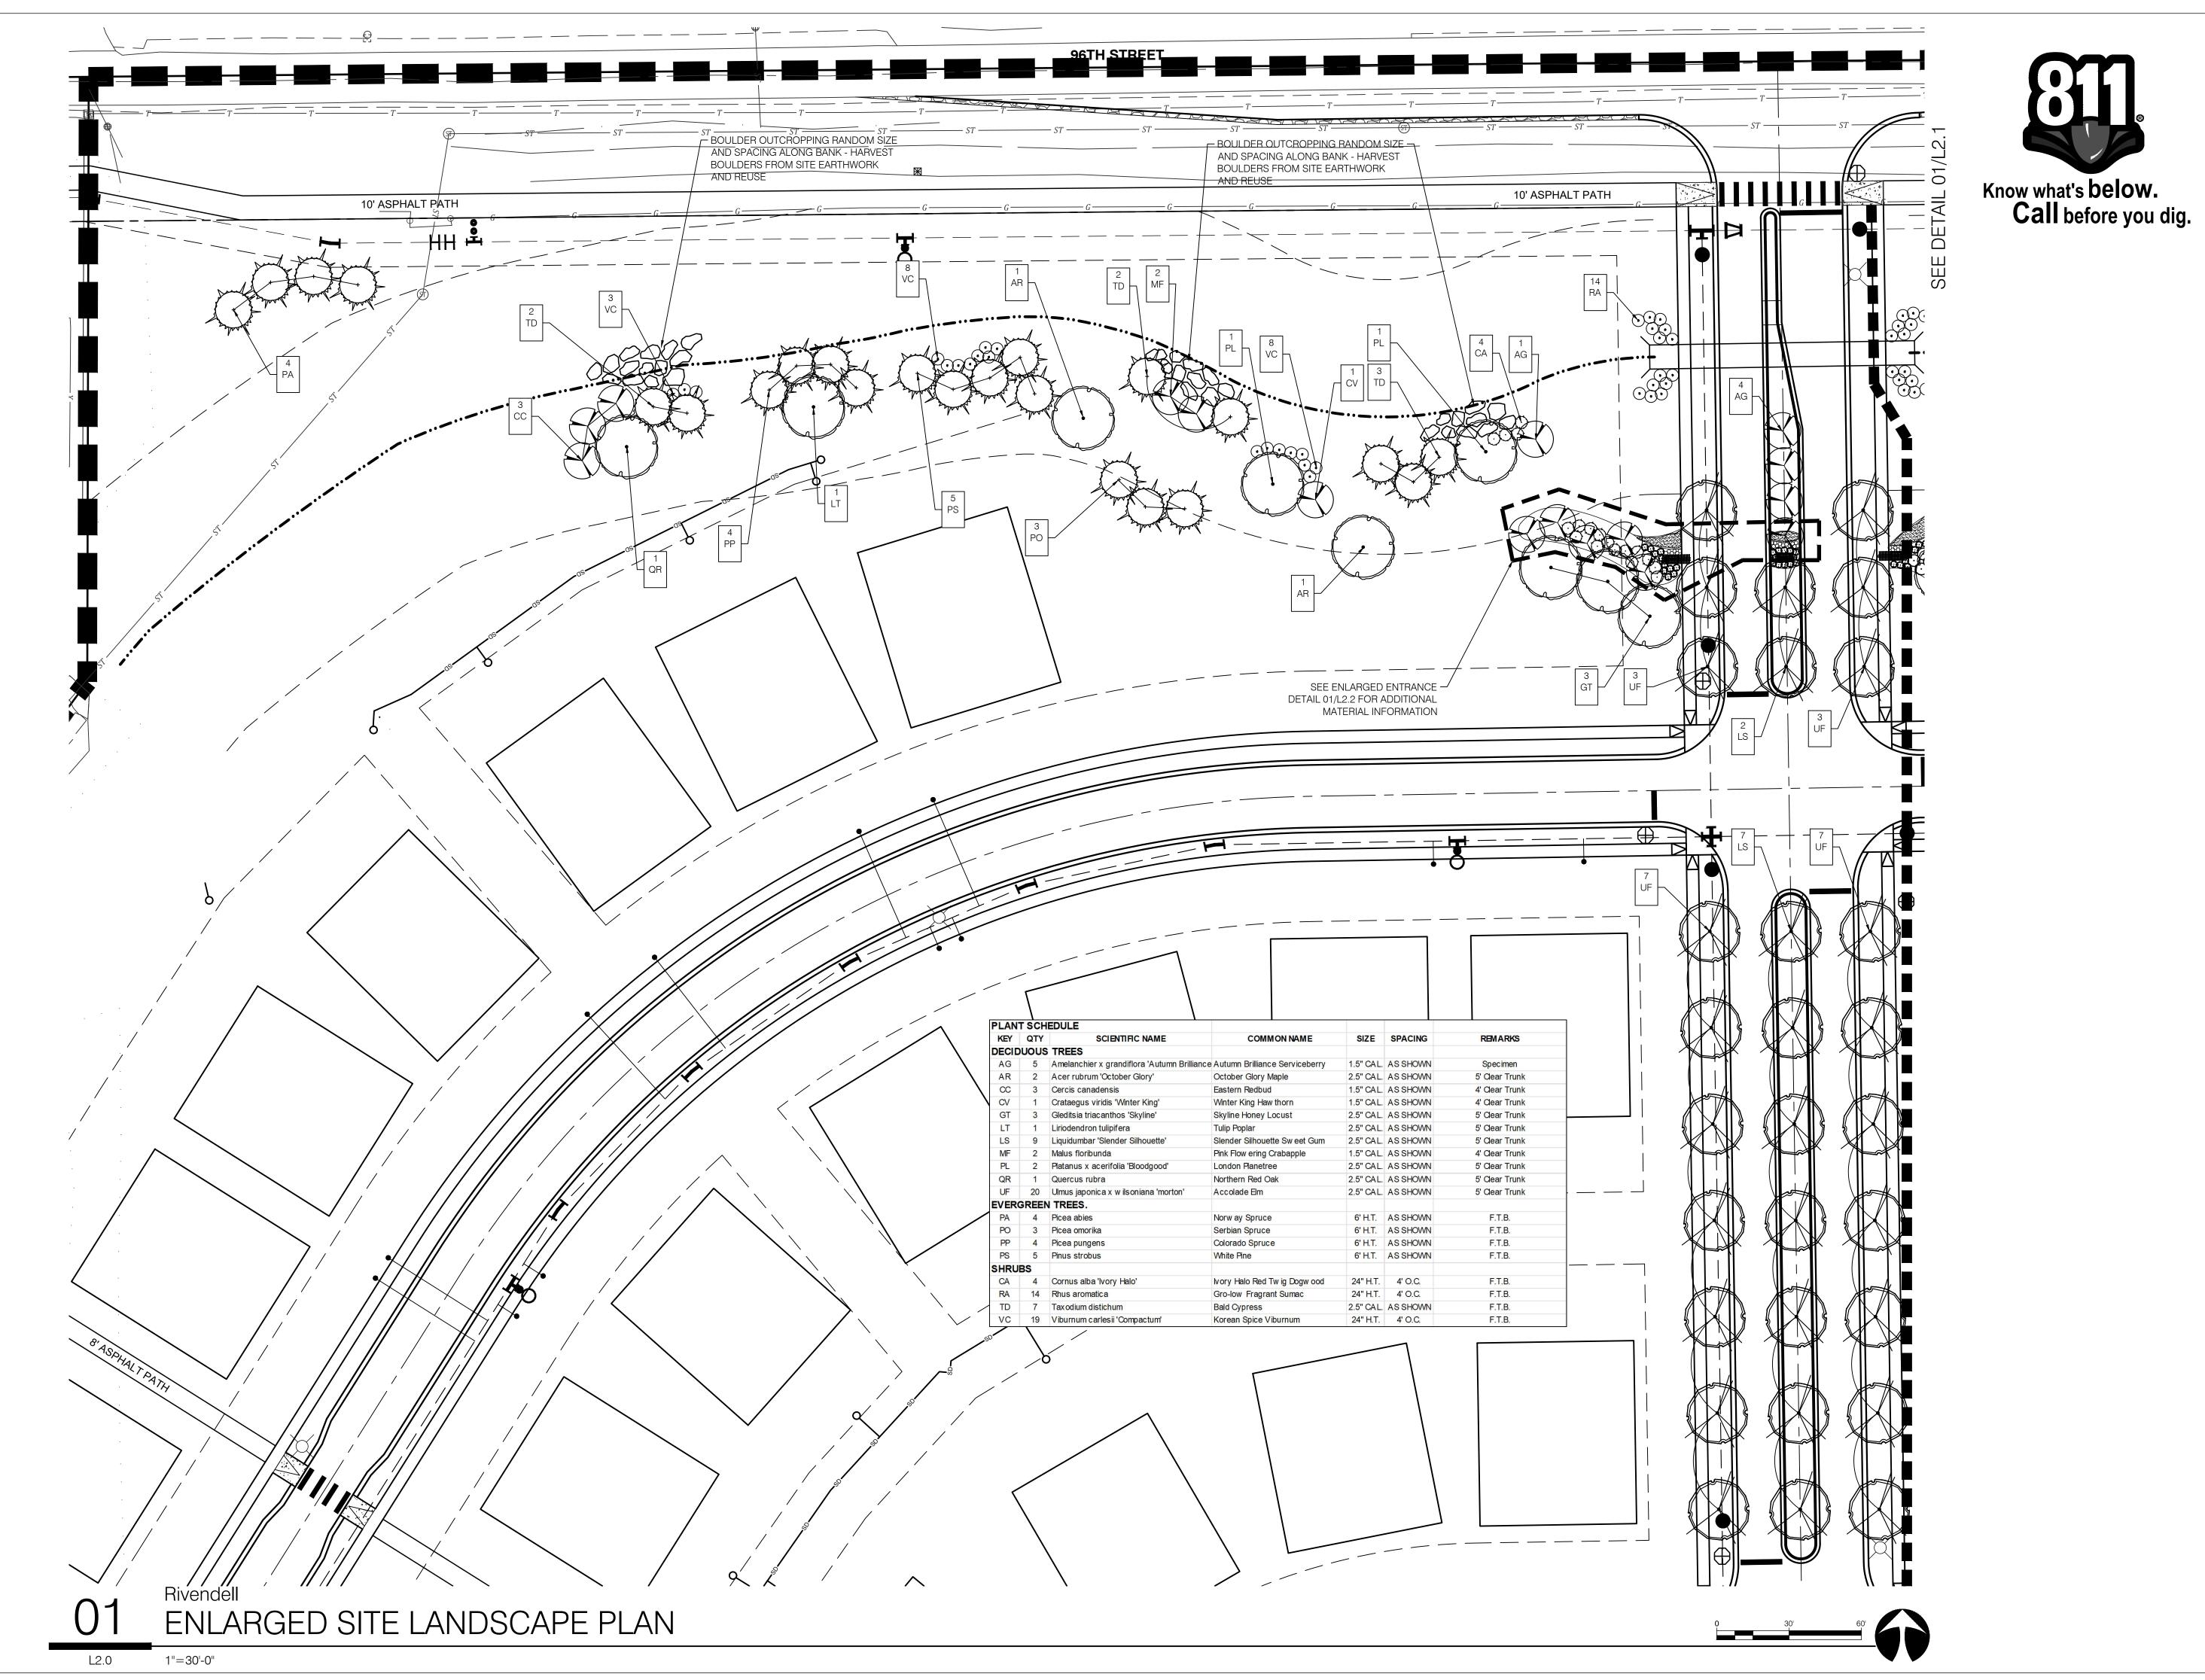



Rivendell

McCordsville, IN

Consultants

Seal Seal

Drawing Scope

ENLARGED
LANDSCAPE PLANS
Drawing Info

Drawn: ______ JML
Checked: _____ JML

 Checked:
 JM


 Date:
 03/25/2022

 Project No:
 21540

 Revision:
 09/09/2022

Sheet No.

L2.0

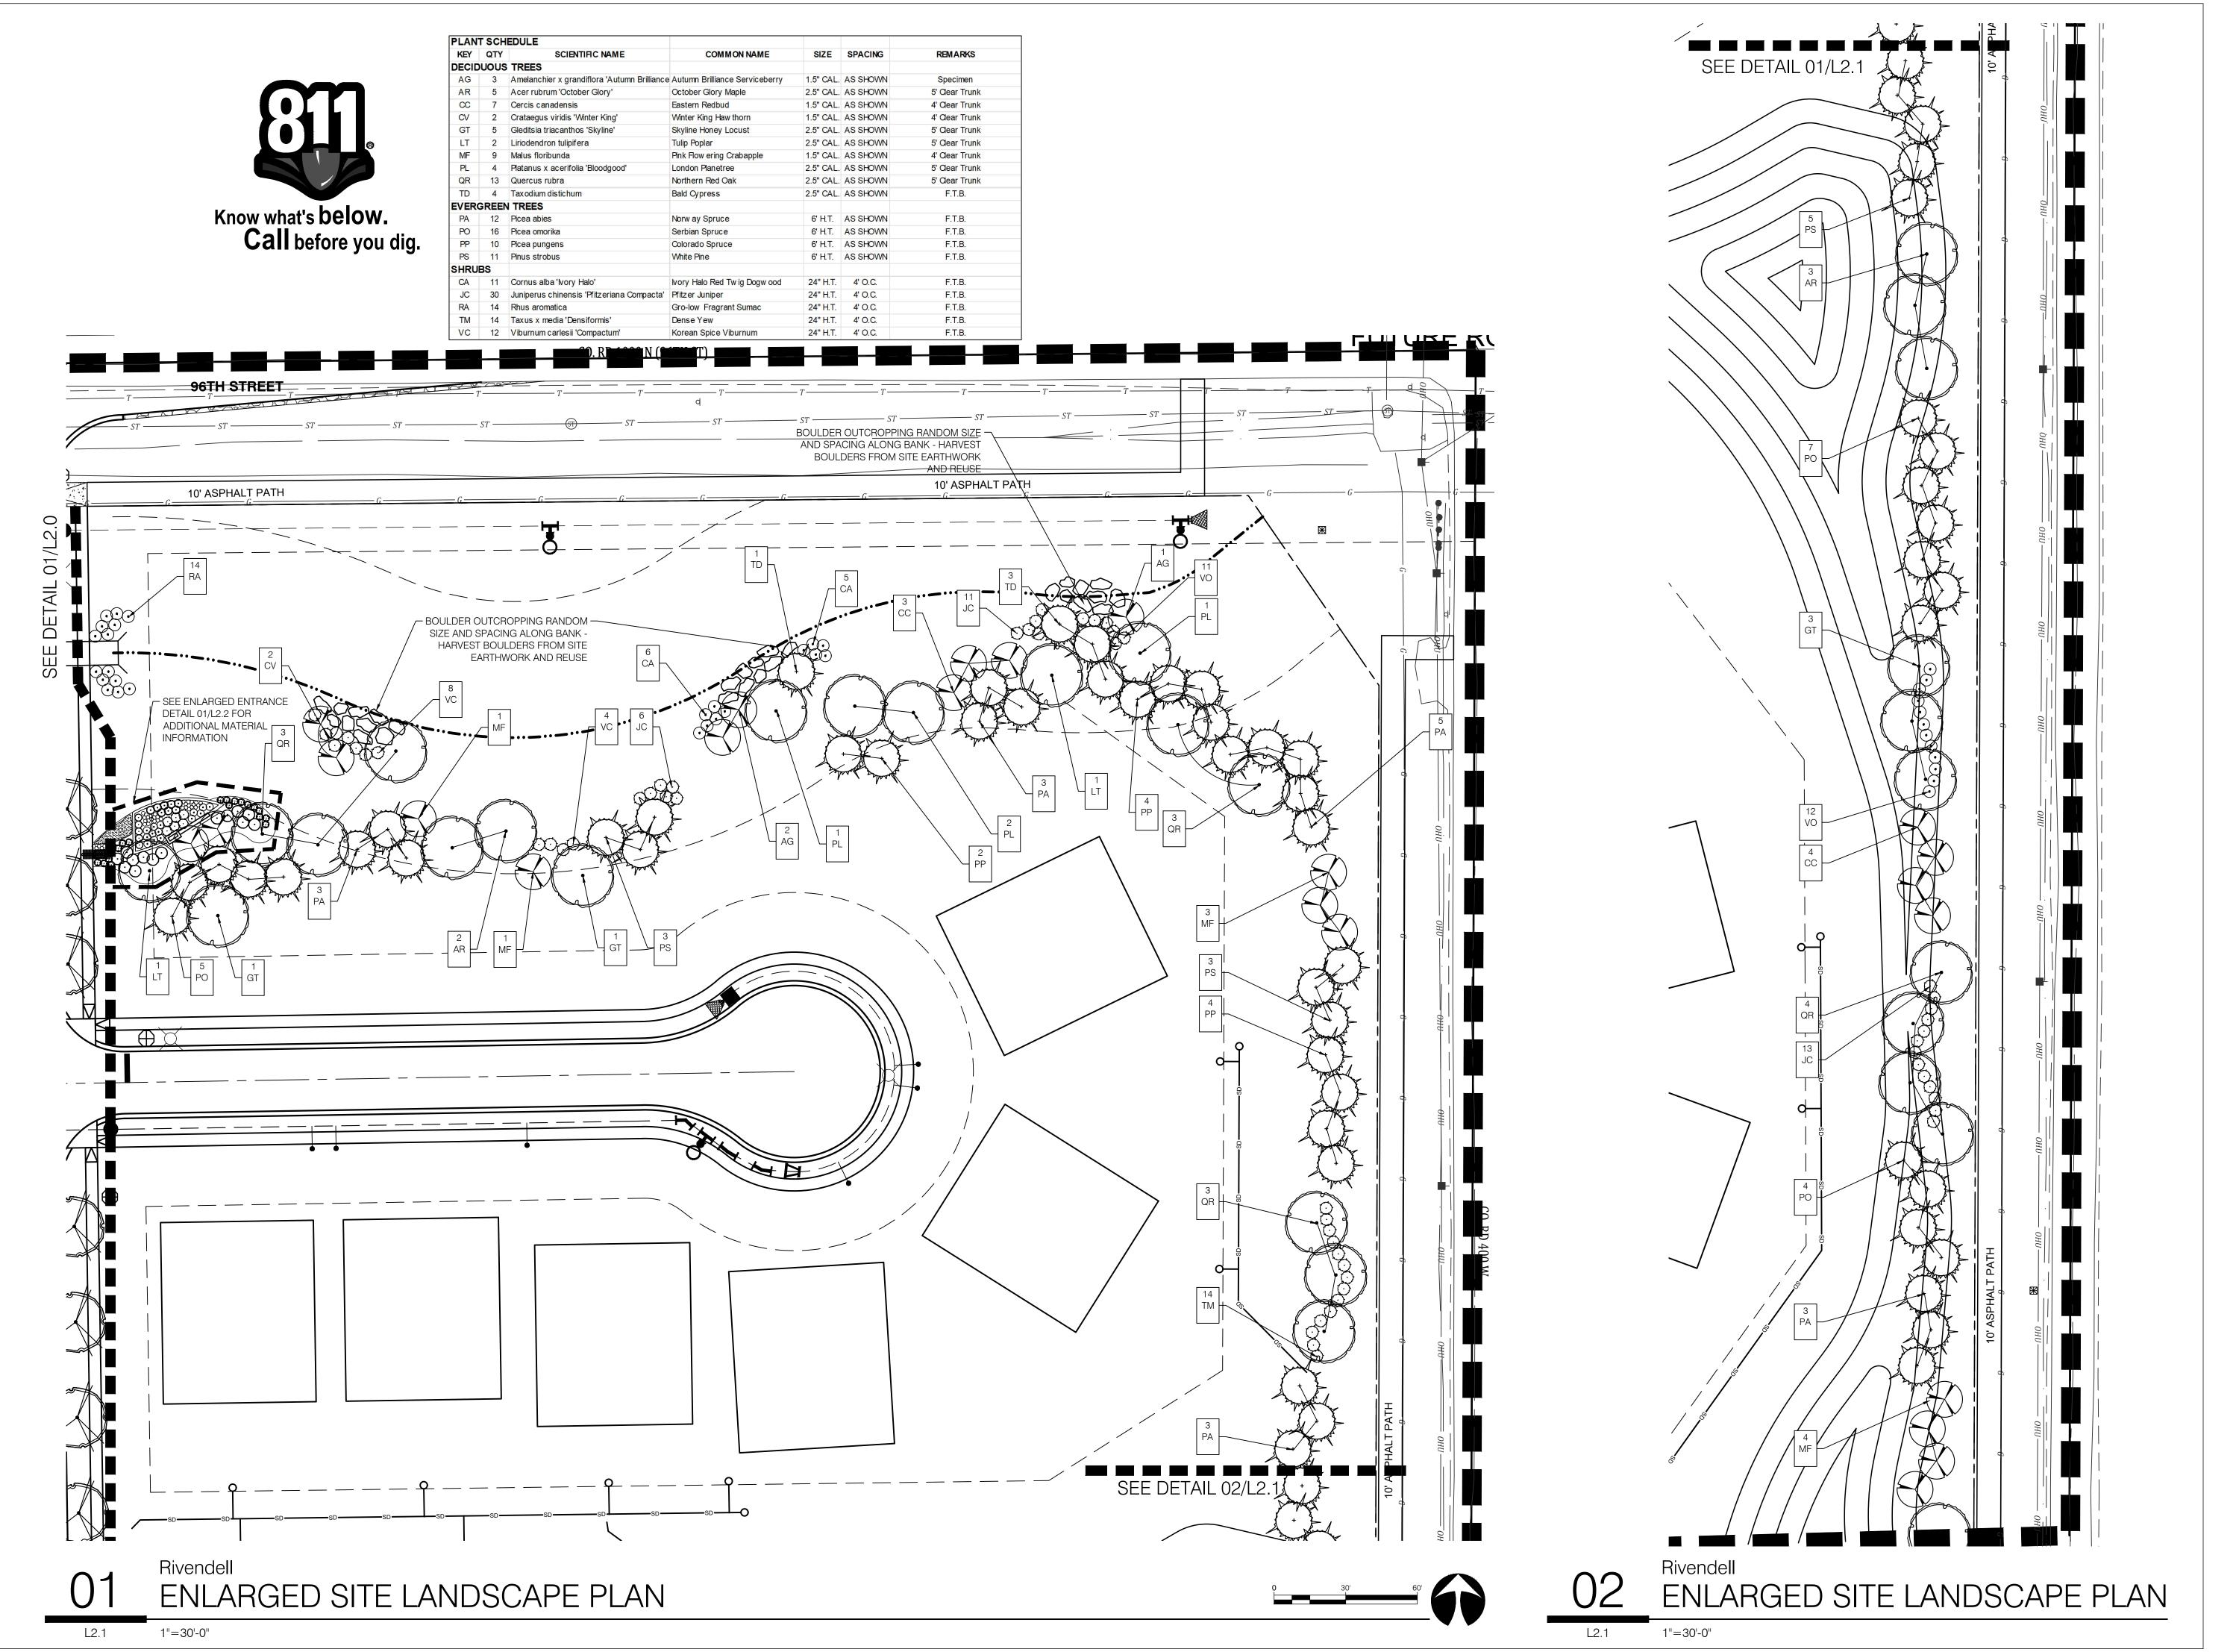

landscape architecture planning professionals 317.258.5229 jlapp@lappdesigngroup.com Consultants Project Info Rivendell McCordsville, IN

Drawing Scope


 Checked:
 JML

 Date:
 03/25/2022

 Project No:
 21540


 Revision:
 09/09/2022

L2.1

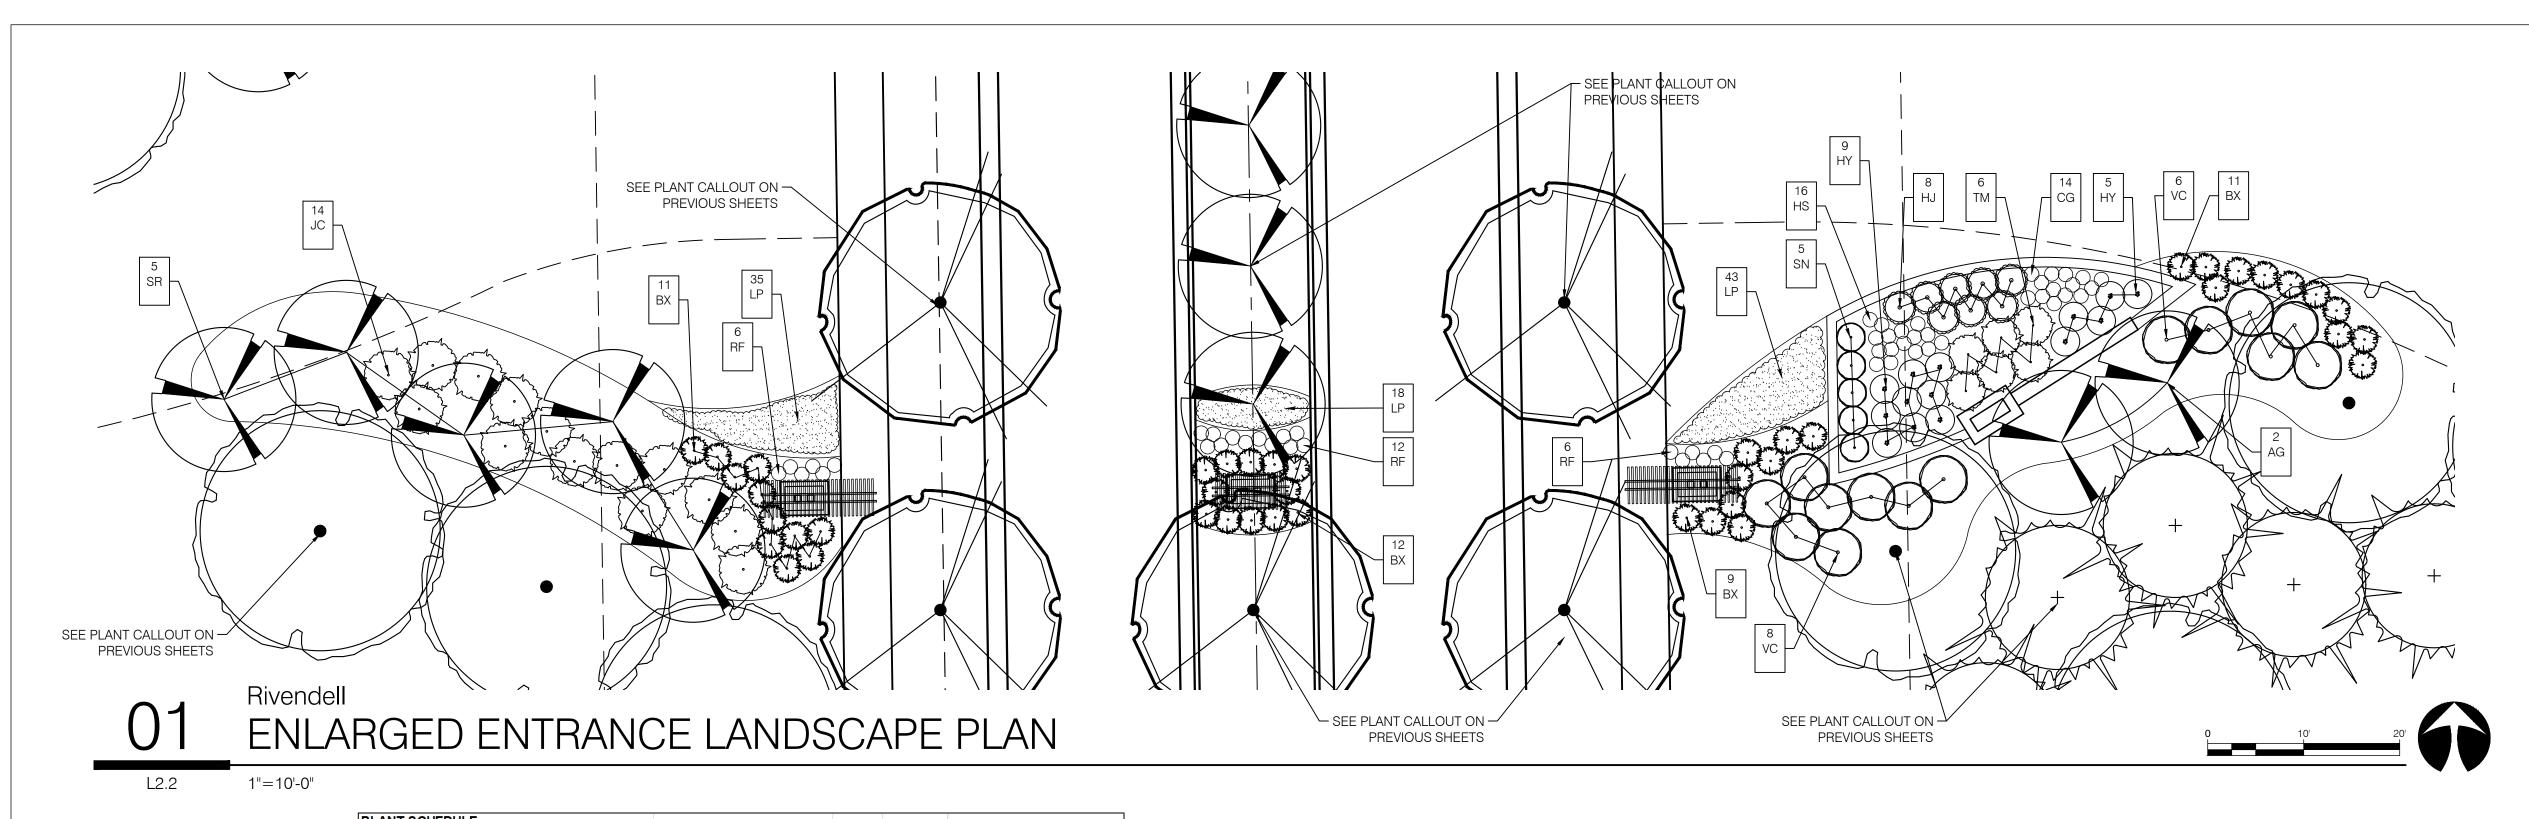



PLAN'	TSCH	EDULE				
KEY	QTY	SCIENTIFIC NAME	COMMONNAME	SIZE	SPACING	REMARKS
DECID	UOUS	TREES				
AG	3	Amelanchier x grandiflora 'Autumn Brilliance	Autumn Brilliance Serviceberry	1.5" CAL.	AS SHOWN	4' Clear Trunk
AR	1	Acer rubrum 'October Glory'	October Glory Maple	2.5" CAL.	AS SHOWN	5' Clear Trunk
CC	3	Cercis canadensis	Eastern Redbud	1.5" CAL.	AS SHOWN	4' Clear Trunk
CV	1	Crataegus viridis 'Winter King'	Winter King Haw thorn	1.5" CAL.	AS SHOWN	4' Clear Trunk
GT	1	Gleditsia triacanthos 'Skyline'	Skyline Honey Locust	2.5" CAL.	AS SHOWN	5' Clear Trunk
PL	2	Platanus x acerifolia 'Bloodgood'	London Planetree	2.5" CAL.	AS SHOWN	5' Clear Trunk
SR	7	Syringa reticulata 'Ivory Silk'	Ivory Silk Tree Lilac	1.5" CAL.	AS SHOWN	4' Clear Trunk
UF	1	Umus 'Frontier'	Frontier ⊟m	2.5" CAL.	AS SHOWN	5' Clear Trunk
EVER	GREEN	TREES				
PA	3	Picea abies	Norw ay Spruce	6' H.T.	AS SHOWN	F.T.B.
SHRU	BS					
BX	43	Buxus microphylla 'Green Velvet'	Littleleaf Boxw ood	18" TALL	AS SHOWN	F.T.B.
HJ	8	Hypericum prolificum	Shrubby St. Johnsw ort	18" TALL	AS SHOWN	F.T.B.
HY	14	Hydrangea macrophylla 'Nikko Blue'	Big Leaf Nikko Blue Hydrangea	24" H.T.	4' O.C.	
JC	14	Juniperus chinensis 'Pfitzeriana Compacta'	Pfitzer Juniper	24" H.T.	4' O.C.	F.T.B.
SN	5	Spiraea japonica 'Neon Flash'	Neon Flash Spirea	18" TALL	AS SHOWN	F.T.B.
TM	36	Taxus x media 'Densiformis'	Dense Yew	18" TALL	AS SHOWN	F.T.B.
VC	28	Viburnum carlesii 'Compactum'	Korean Spice Viburnum	24" H.T.	4' O.C.	F.T.B.
GRAS	SES A	ND PERENNIALS				
CG	16	Carex glauca	Blue Sedge	1 GAL.	18" O.C.	
LP	96	Liriope muscarii 'Big Blue'	Big Blue Lilyturf	1/4" POT	18" O.C.	
HS	16	Hemerocallis x 'Happy Returns'	Happy Returns Daylilly	1 GAL.	18" O.C.	
RF	24	Rudbeckia fulgida 'Goldstrum'	Black-eyed Susan	1 GAL.	18" O.C.	

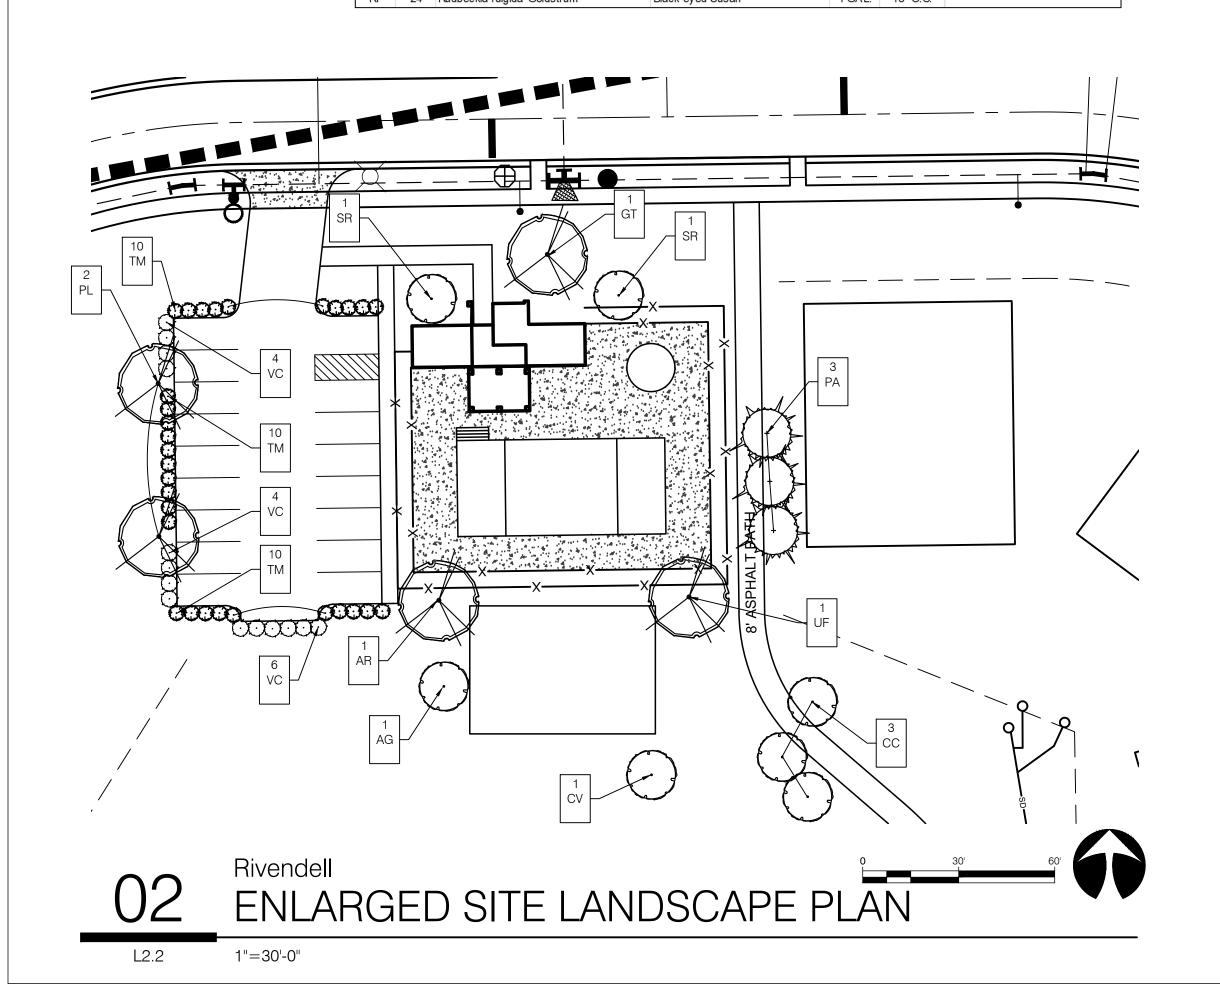



Rivendell

McCordsville, IN

Seal


Drawing Scope

ENLARGED
LANDSCAPE PLANS
Drawing Info

Drawn: JML
Checked: JML
Date: 03/25/2022
Project No: 21540

Sheet No.


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01

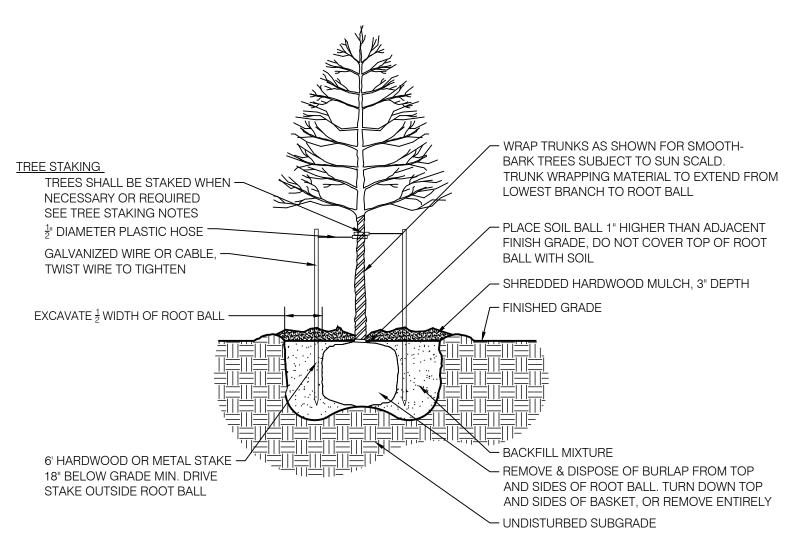DECIDUOUS TREE


PLANTING DETAIL - NOT TO SCALE



02

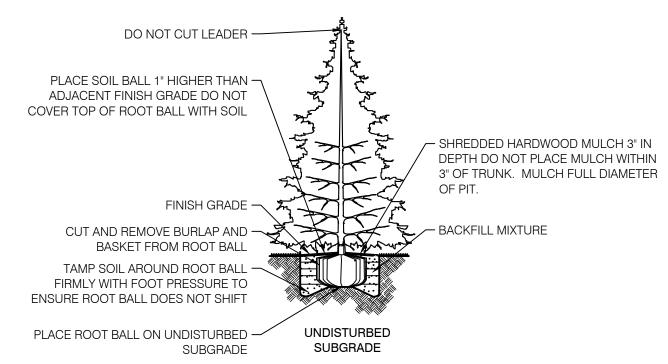EVERGREEN TREE

PLANTING DETAIL - NOT TO SCALE

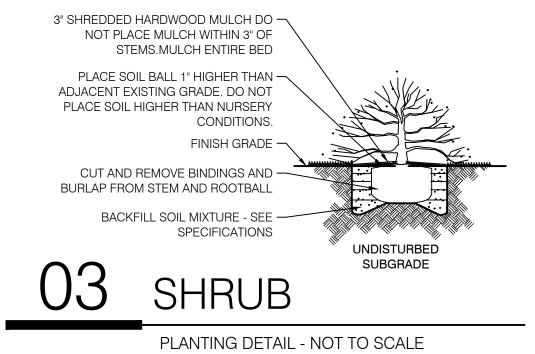



NOTES

GENERAL NOTES:

- 1. ALL UTILITIES SHALL BE LOCATED AND MARKED/FLAGGED PRIOR TO BEGINNING WORK. RELOCATE PLANTS FROM OVER OR UNDER UTILITIES. RELOCATION SHALL BE APPROVED BY OWNER AND/OR LANDSCAPE ARCHITECT PRIOR TO INSTALLATION.
- 2. <u>UTILITY LOCATION NOTE:</u> ALL LOCATIONS SHOWN ARE APPROXIMATE AND BASED ON INFORMATION SUPPLIED BY EITHER THE CIVIL ENGINEER, SURVEYOR, OWNER, AND/OR MEASURED IN THE FIELD. IF DISCREPANCIES ARE PRESENT, CONTRACTOR SHALL NOTIFY OWNER AND LANDSCAPE ARCHITECT IMMEDIATELY AND PRIOR TO BEGINNING WORK.
- 3. IN CASE OF DISCREPANCIES BETWEEN THE PLAN AND THE PLANT LIST, THE PLAN SHALL DICTATE.
- 4. LANDSCAPE CONTRACTOR IS RESPONSIBLE FOR ALL PREPARATION, MATERIALS, DELIVERY, INSTALLATION AND INITIAL MAINTENANCE FOR THE LANDSCAPE PORTION OF THE PROJECT AS SHOWN ON THE DRAWING AND AS DIRECTED BY THE OWNER'S REPRESENTATIVE. THE LANDSCAPE CONTRACTOR SHALL OBTAIN AND PAY FOR ALL PERMITS AND FEES THAT MAY BE REQUIRED FOR THEIR PORTION OF WORK.
- 5. PLANTS AND ALL OTHER MATERIALS TO BE STORED ON SITE WILL BE PLACED WHERE THEY WILL NOT CONFLICT W/ CONSTRUCTION OPERATIONS AND AS DIRECTED BY OWNER'S REPRESENTATIVE.
- 6. CLEAN UP ALL DEBRIS AND REMOVE FROM SITE, REPAIR ALL DAMAGED OR DISTURBED AREAS CAUSED BY LANDSCAPE WORK.
- TOPSOIL NOTE: TOPSOIL SHALL BE FRIABLE, NATURAL LOAM, SURFACE SOIL AND FREE OF SUBSOIL, CLAY LUMPS, BRUSH, WEEDS, LITTER, ROOTS, STUMPS, STONES, AGRICULTURAL AND DOMESTIC FERTILIZERS, CHEMICALS, HERBICIDES, AND OTHER EXTRANEOUS OR TOXIC MATTER HARMFUL TO PLANT GROWTH AND THE ENVIRONMENT. WASTE SOILS, BORROW, OR HEAVY CLAY BASED SOILS WILL NOT BE ACCEPTED. TOPSOIL SHALL HAVE A PH VALUE OF 6.0 TO 7.4 AND AN ORGANIC VALUE OF 3% TO 5%. SUBMIT SOIL SAMPLES, PH LEVELS, AND NPK ANALYSIS PRIOR TO DELIVERY TO SITE.

PLANTING NOTES:

- 1. REMOVE WEEDS, ORGANIC MATTER AND ROCKS LARGER THAN 1.5" FROM SOIL.
- 2. BACKFILL FOR TREE PLANTING SHALL BE 75% TOPSOIL AND 25% ORGANIC COMPOST. TOP LAYER OF BACKFILL SHALL BE 100% OF SURROUNDING TOPSOIL. A 5-10-5 ANALYSIS SLOW RELEASE FERTILIZER SHALL BE INCORPORATED INTO BACKFILL AT APPROVED RATES.
- 3. THE TOPS OF ALL TREE AND SHRUB ROOT BALLS TO BE PLACED A MAXIMUM OF ONE (1) INCH ABOVE FINAL GRADE. ALL TREES LOCATED OUTSIDE OF BEDS SHALL HAVE A MINIMUM SIX (6) FOOT DIAMETER NON-LIPPED SAUCER AROUND PLANTING PIT. ALL SAUCERS SHALL BE WEED AND GRASS FREE. AN APPROVED PRE-EMERGENT HERBICIDE SHALL BE APPLIED IN ALL PLANTING BEDS AT A RATE SPECIFIED BY MANUFACTURER FOR EACH PLANT VARIETY.
- 4. ALL TREE SAUCERS AND PLANTING BEDS SHALL RECEIVE MINIMUM OF THREE (3) INCHES GRADE A, SHREDDED HARDWOOD BARK MULCH. NO CYPRESS, WOOD CHIPS, ARTIFICIAL OR DYED MULCH ALLOWED.
- 5. NO SUBSTITUTIONS OF PLANT MATERIALS WILL BE ALLOWED. IF PLANTS ARE NOT AVAILABLE, THE CONTRACTOR SHALL NOTIFY LANDSCAPE ARCHITECT/
 OWNER'S REPRESENTATIVE IN WRITING. ALL PLANTS SHALL BE INSPECTED AND TAGGED WITH PROJECT I.D. AT NURSERY OR CONTRACTORS OPERATIONS
 PRIOR TO MOVING TO JOB SITE. PLANTS MAY BE INSPECTED AND APPROVED OR REJECTED ON THE JOB SITE BY LANDSCAPE ARCHITECT OR OWNER'S
 REPRESENTATIVE
- 6. THE OWNER, OWNER'S AGENT, OR THE LANDSCAPE ARCHITECT RESERVES THE RIGHT TO REJECT ANY AND ALL PLANT MATERIALS AT ANY TIME DURING THE COURSE OF THE PROJECT UNTIL PROJECT IS ACCEPTED BY THE OWNER.
- 7. LANDSCAPE CONTRACTOR SHALL LAYOUT AND STAKE ALL PLANT LOCATIONS AS SHOWN ON THE DRAWINGS PRIOR TO INSTALLATION. OWNER'S REPRESENTATIVE OR LANDSCAPE ARCHITECT SHALL INSPECT AND APPROVE PLANT LOCATIONS FOR ACCURACY AND COMPLIANCE WITH DESIGN INTENT
- 8. LANDSCAPE CONTRACTOR IS RESPONSIBLE FOR THE PLANTING OF SPECIFIED PLANTS AND MAINTAINING ALL PLANT MATERIALS IN AN ALIVE AND QUALITY CONDITION UNTIL ACCEPTANCE BY THE OWNER. THIS INCLUDES AS A MINIMUM: WATERING, WEEDING, INSECT AND DISEASE CONTROL, PRUNING OF DAMAGED OR UNSIGHTLY LIMBS, AND KEEPING PLANTS IN TRUE AND UPRIGHT POSITIONS.
- 9. CONTRACTOR SHALL GUARANTEE AND WARRANT ALL PLANT MATERIAL TO REMAIN ALIVE AND HEALTHY FOR ONE (1) YEAR FROM DATE OF ACCEPTANCE BY THE OWNER. ALL REPLACEMENTS SHALL BE PAID FOR BY THE CONTRACTOR AT NO ADDITIONAL COST TO THE OWNER. GUARANTEE/WARRANTY REPLACEMENTS SHALL BE AS DIRECTED BY THE OWNER UNTIL FINAL ACCEPTANCE OF THE PROJECT FOLLOWING THE GUARANTEE PERIOD.

SODDING AND PREPARATION:

- CONTRACTOR TO FINE GRADE AND PREPARE ALL SITE AREAS TO RECEIVE SOD. FINE GRADE SITE SMOOTH TO FINAL GRADING PLAN ELEVATIONS, FILL IN DEPRESSIONS, LOW SPOTS AND GRADE SMOOTH.
- 2. ALL SODDED LAWN AREAS WITHIN LIMIT LINES TO RECEIVE 6" TOPSOIL PRIOR TO SODDING OPERATIONS. ONCE TOPSOIL HAS BEEN PLACED, CONSTRUCTION ACTIVITY OF ANY KIND (EXCLUDING LANDSCAPING) SHALL NOT BE PERMITTED ON OR ACROSS ANY PLANTING AREA.
- 3. LAWNS SHALL BE SODDED FOLLOWING SCARIFYING, FINAL GRADING, FERTILIZING, AND RAKING. LAWN SHALL BE FERTILIZED W/ 12-12-12 ANALYSIS
- 4. WATER AND MAINTAIN GRASS UNTIL STAND IS ESTABLISHED AND READY FOR MOWING AT MINIMUM 4 INCH HEIGHT. CONTINUE TO WATER FOR A MINIMUM 30 DAYS OR UNTIL ACCEPTED BY OWNER
- 5. FOLLOWING SODDING OPERATIONS, CLEAN UP EXCESS MATERIALS, AND CLEAN ALL BARK MULCHED AND PAVED AREAS. ALL LAWNS SHALL BE GUARANTEED TO HAVE A FULL UNIFORM STAND OF ACCEPTABLE GRASS AT THE END OF THE ONE YEAR GUARANTEE PERIOD WITH NO BARE SPOTS COMPRISING MORE THAN 2% OF ANY LAWN AREA. ANY AREA SO NOTED WILL BE SODDED UNTIL AN ACCEPTABLE STAND OF GRASS IS ESTABLISHED.
- 6. ALL DISTURBED LAWN AREAS SHALL BE SODDED AS NOTED AND AS APPROVED BY OWNER'S REPRESENTATIVE AND LANDSCAPE ARCHITECT.

SEEDING AND PREPARATION:

- 1. CONTRACTOR TO FINE GRADE AND PREPARE ALL SITE AREAS TO RECEIVE SEED. MAKE SITE SMOOTH TO FINAL GRADING PLAN ELEVATIONS, FILL IN DEPRESSIONS, LOW SPOTS AND GRADE SMOOTH
- 2. ALL SEEDED LAWN AREAS WITHIN LIMIT LINES TO RECEIVE 6" TOPSOIL PRIOR TO SEEDING OPERATIONS. ONCE TOPSOIL HAS BEEN PLACED,
- CONSTRUCTION ACTIVITY OF ANY KIND (EXCLUDING LANDSCAPING) SHALL NOT BE PERMITTED ON OR ACROSS ANY PLANTING AREA.

 3. HYDROSEEDING IS ACCEPTABLE. APPLY WITH APPROVED EQUIPMENT DESIGNED FOR PROFESSIONAL HYDROSEEDING APPLICATIONS AT RECOMMENDED
- 4. PROVIDE FRESH, CLEAN NEW-CROP 'PREMIUM' GRADE SEED AND SEED MIXES AS FOLLOWS: (SUBMIT SEASONAL MIX ALTERNATIVE AS APPROPRIATE)
 40% KENTUCKY BLUEGRASS
 30% PERENNIAL RYE GRASS
 30% TURF TYPE TALL FESCUE
- 5. APPLY SEED AT RATE OF MINIMUM 175 POUNDS PER ACRE (4 LBS/1000SF).
- 6. SCARIFY SOIL TO DEPTH OF 3 INCHES PRIOR TO APPLICATION.

MINIMUM 30 DAYS OR UNTIL ACCEPTED BY OWNER.

- 7. LAWNS SHALL BE SEEDED FOLLOWING SCARIFYING, FINAL GRADING, FERTILIZING, AND RAKING. LAWN SHALL BE FERTILIZED W/ 12-12-12 ANALYSIS FERTILIZER AT A RATE OF 10 lbs./1000 s.f. APPLY SEED MIX AT SPECIFIED RATE, AND LIGHTLY RAKE INTO TOP 1/4 INCH OF SOIL.
- 8. MULCH SEEDED AREAS WITH STRAW MULCH AT RATE OF MINIMUM 1 1/2 TON PER ACRE (70 LBS/1000SF). CRIMP OR TACK STRAW MULCH TO REMAIN IN PLACE UNTIL COMPLETE GERMINATION OF SEED AND ESTABLISHED GROWTH. COORDINATE WITH EROSION CONTROL PLAN.
- 9. WATER AND MAINTAIN GRASS UNTIL STAND IS ESTABLISHED AND READY FOR MOWING AT MINIMUM 4 INCH HEIGHT. CONTINUE TO WATER FOR A
- 10. FOLLOWING SEEDING OPERATIONS, CLEAN UP EXCESS MATERIALS, AND CLEAN ALL BARK MULCHED AND PAVED AREAS.
- 11. FOLLOWING GERMINATION, APPLY HERBICIDE TO ALL GRASS GROWTH IN PLANT MULCH AREAS.
- 12. ALL LAWNS SHALL BE GUARANTEED TO HAVE A FULL UNIFORM STAND OF ACCEPTABLE GRASS AT THE END OF THE ONE YEAR GUARANTEE PERIOD WITH NO BARE SPOTS COMPRISING MORE THAN 2% OF ANY LAWN AREA. ANY AREA SO NOTED WILL BE RESEEDED OR SODDED UNTIL AN ACCEPTABLE STAND OF GRASS IS ESTABLISHED.
- 13. ALL DISTURBED LAWN AREAS SHALL BE SEEDED AS NOTED AND AS APPROVED BY OWNER'S REPRESENTATIVE AND LANDSCAPE ARCHITECT.

TREE STAKING NOTES:

- CONTRACTOR TO STAKE WHEN NECESSARY OR REQUIRED, SUCH AS WIND PRONE AREAS OR UNSTABLE SOILS. STAKES SHALL BE PLACED IN MULCHED AREAS TO ALLOW FOR MOWING ADJACENT TURF.
- STAKING SHOULD NOT BE USED TO COMPENSATE FOR DAMAGED OR WEAK TRUNKS OR ROOT BALLS, THESE TREES SHOULD BE REJECTED.
- 3. REMOVE ALL STAKING AS SOON AS THE TREE HAS GROWN SUFFICIENT ROOTS TO OVERCOME THE PROBLEM THAT REQUIRED THE TREE TO BE STAKED. STAKES SHALL BE REMOVED NO LATER THAN THE END OF THE FIRST GROWING SEASON AFTER PLANTING.
- 4. ASSURE THAT THE BEARING SURFACE OF THE PROTECTIVE COVERING OF THE WIRE OR CABLE AGAINST THE TREE TRUNK IS A MINIMUM OF 12 MM (0.5 IN.).
- 5. WIRES OR CABLE SIZES SHALL BE 14 to 12 GAUGE.
- 6. TIGHTEN WIRE OR CABLE ONLY ENOUGH TO KEEP FROM SLIPPING. ALLOW FOR SOME TRUNK MOVEMENT. PLASTIC HOSE TO BE LONG ENOUGH TO ACCOMMODATE 1.5" OF GROWTH AND BUFFER ALL BRANCHES FROM THE WIRE.
- 7. TUCK ANY LOOSE ENDS OF THE WIRE OR CABLE INTO THE WIRE WRAP SO THAT NO SHARP WIRE ENDS ARE EXPOSED.

PP

design group, llc

landscape
architecture

+

planning
professionals

317.258.5229


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Consultants

Project Info

Rivende

McCordsville, II

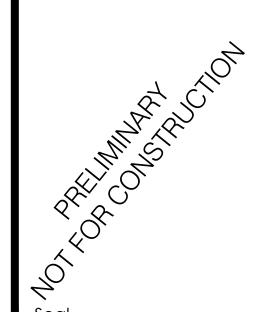

Drawing Scope

LANDSCAPE NOTES AND DETAILS Drawing Info

 Drawn:
 3

 Checked:
 3

 Date:
 03/25/20

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