


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 By: tamth

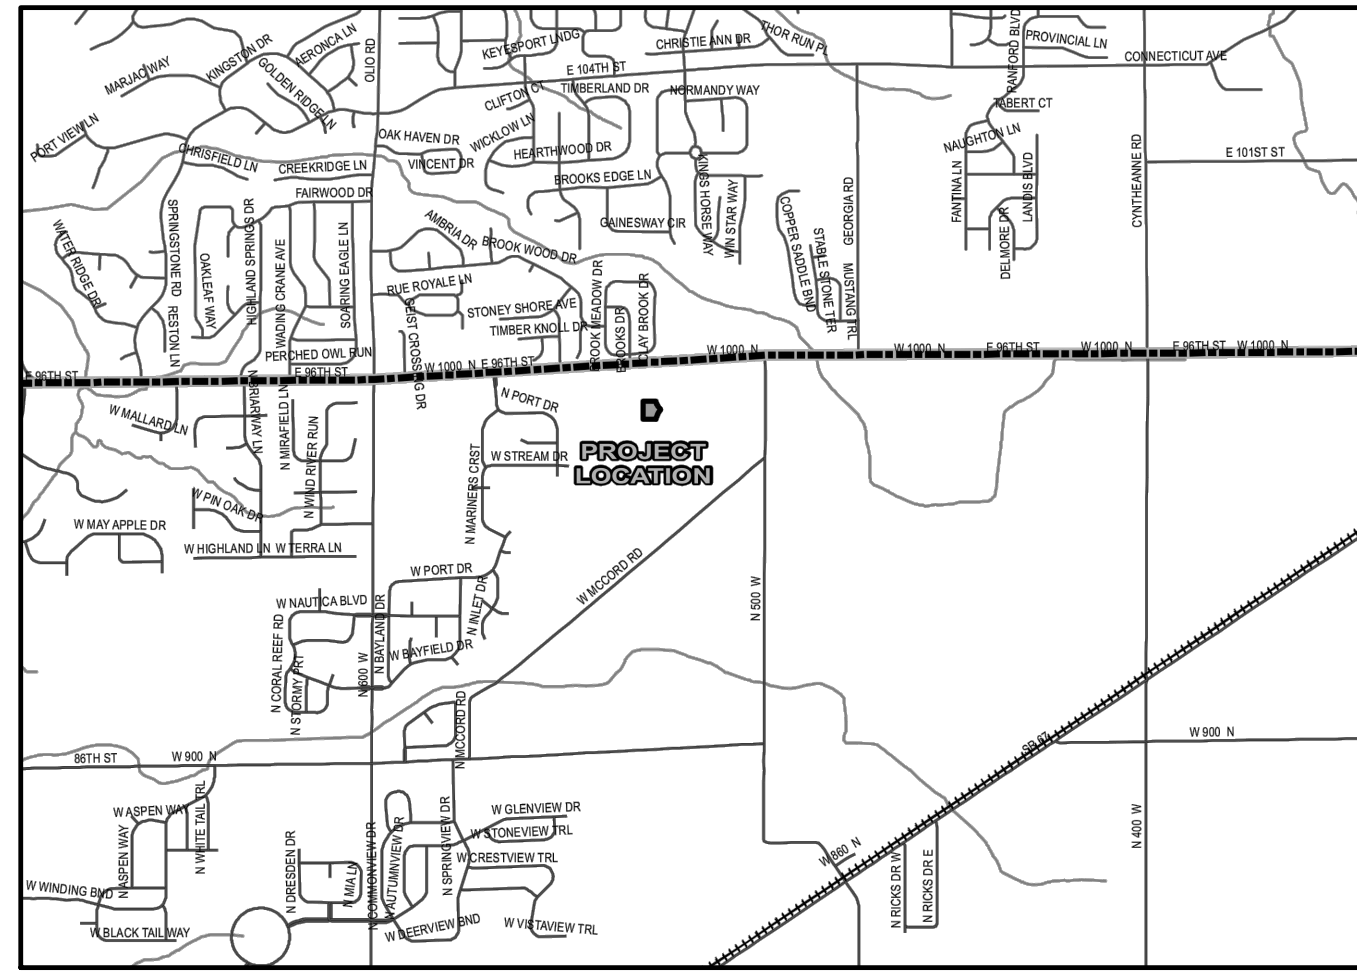


LOCATION MAP
SCALE 1" = 1,000 FEET

McCORD POINTE AMENITY AREA

Lennar Homes of Indiana, Inc.

DEVELOPER:
LENNAR HOMES OF INDIANA, INC.
BILL BRYANT
9025 NORTH RIVER ROAD, SUITE 100
INDIANAPOLIS, INDIANA 46240
(317) 450-4634

CIVIL ENGINEER and SURVEYOR:
HWC ENGINEERING
135 N. PENNSYLVANIA ST., SUITE 2800
INDIANAPOLIS, IN 46204
(317) 347-3663
keichhorn@hwcengineering.com

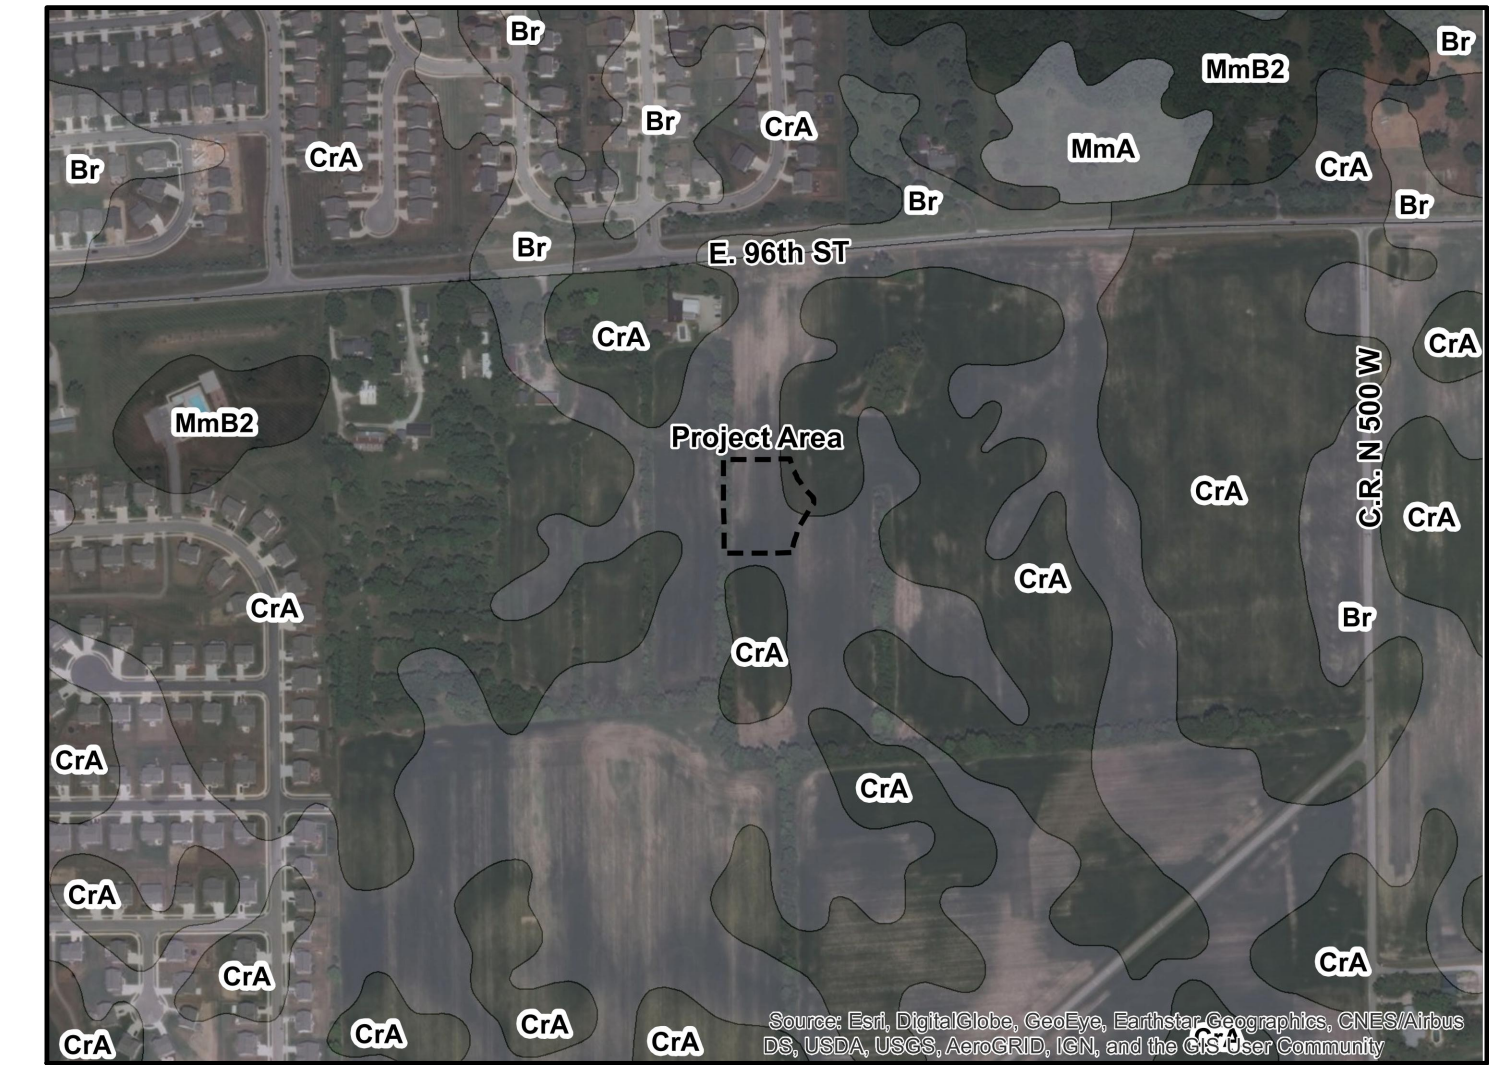

SOILS MAP
NOT TO SCALE

SOIL DESCRIPTIONS/LIMITATIONS


- Br - Brookston silty clay loam, 0 to 2 percent slopes.**
For the construction of local roads and streets, this soil is rated very limited due to a high potential for ponding, limited depth to a saturated zone (water table), high potential for frost action, moderate potential for shrink/swell action, and low strength. For the construction of homes, this soil is rated very limited due to a limited depth to a saturated zone (water table) and high potential for ponding. The potential for shrink/swell action is low however.
- CrA - Crosby silty loam, fine-loamy subsoil, 0 to 2 percent slopes.**
For the construction of local roads and streets, this soil is rated very limited due to a high potential for frost action, limited depth to a saturated zone (water table), and low strength. For the construction of homes, this soil is rated very limited due to a limited depth to a saturated zone (water table).

SHEET LIST TABLE

Sheet Title	Sheet Description
C1.0	COVER
C1.1	SITE IMPROVEMENTS PLAN
C1.2	GRADING PLAN
C1.3	PRE-CONSTRUCTION STORMWATER POLLUTION PREVENTION & DEMOLITION PLAN
C1.4	ACTIVE CONSTRUCTION STORMWATER POLLUTION PREVENTION PLAN
C1.5	POST CONSTRUCTION STORMWATER POLLUTION PREVENTION PLAN
C1.6	UTILITY PLAN
L1.0	LANDSCAPE PLAN
L1.1	LANDSCAPE DETAILS
C8.0	STORMWATER POLLUTION PREVENTION NOTES
C8.1-C8.4	STORMWATER POLLUTION PREVENTION DETAILS
C8.5	CONSTRUCTION DETAILS

McCORDSVILLE TOWN STANDARDS SHEET LIST TABLE

Sheet Title	Sheet Description
1	DIRECTIONS FOR USE & GENERAL NOTES
2	RIGHT-OF-WAY SECTIONS & PAVEMENT SPECIFICATIONS
3	RIGHT-OF-WAY DETAILS
4	UTILITY LOCATION GUIDELINES
5	DRIVE WAY & HANDICAP RAMP DETAILS
6	STORM SEWER STRUCTURE DETAILS
7	STORM SEWER BEDDING DETAILS AND GENERAL NOTES
8	SANITARY SEWER SPECIFICATIONS
9	SANITARY SEWER DETAILS
10	SANITARY SEWER LIFT STATION STANDARDS & GUIDELINES

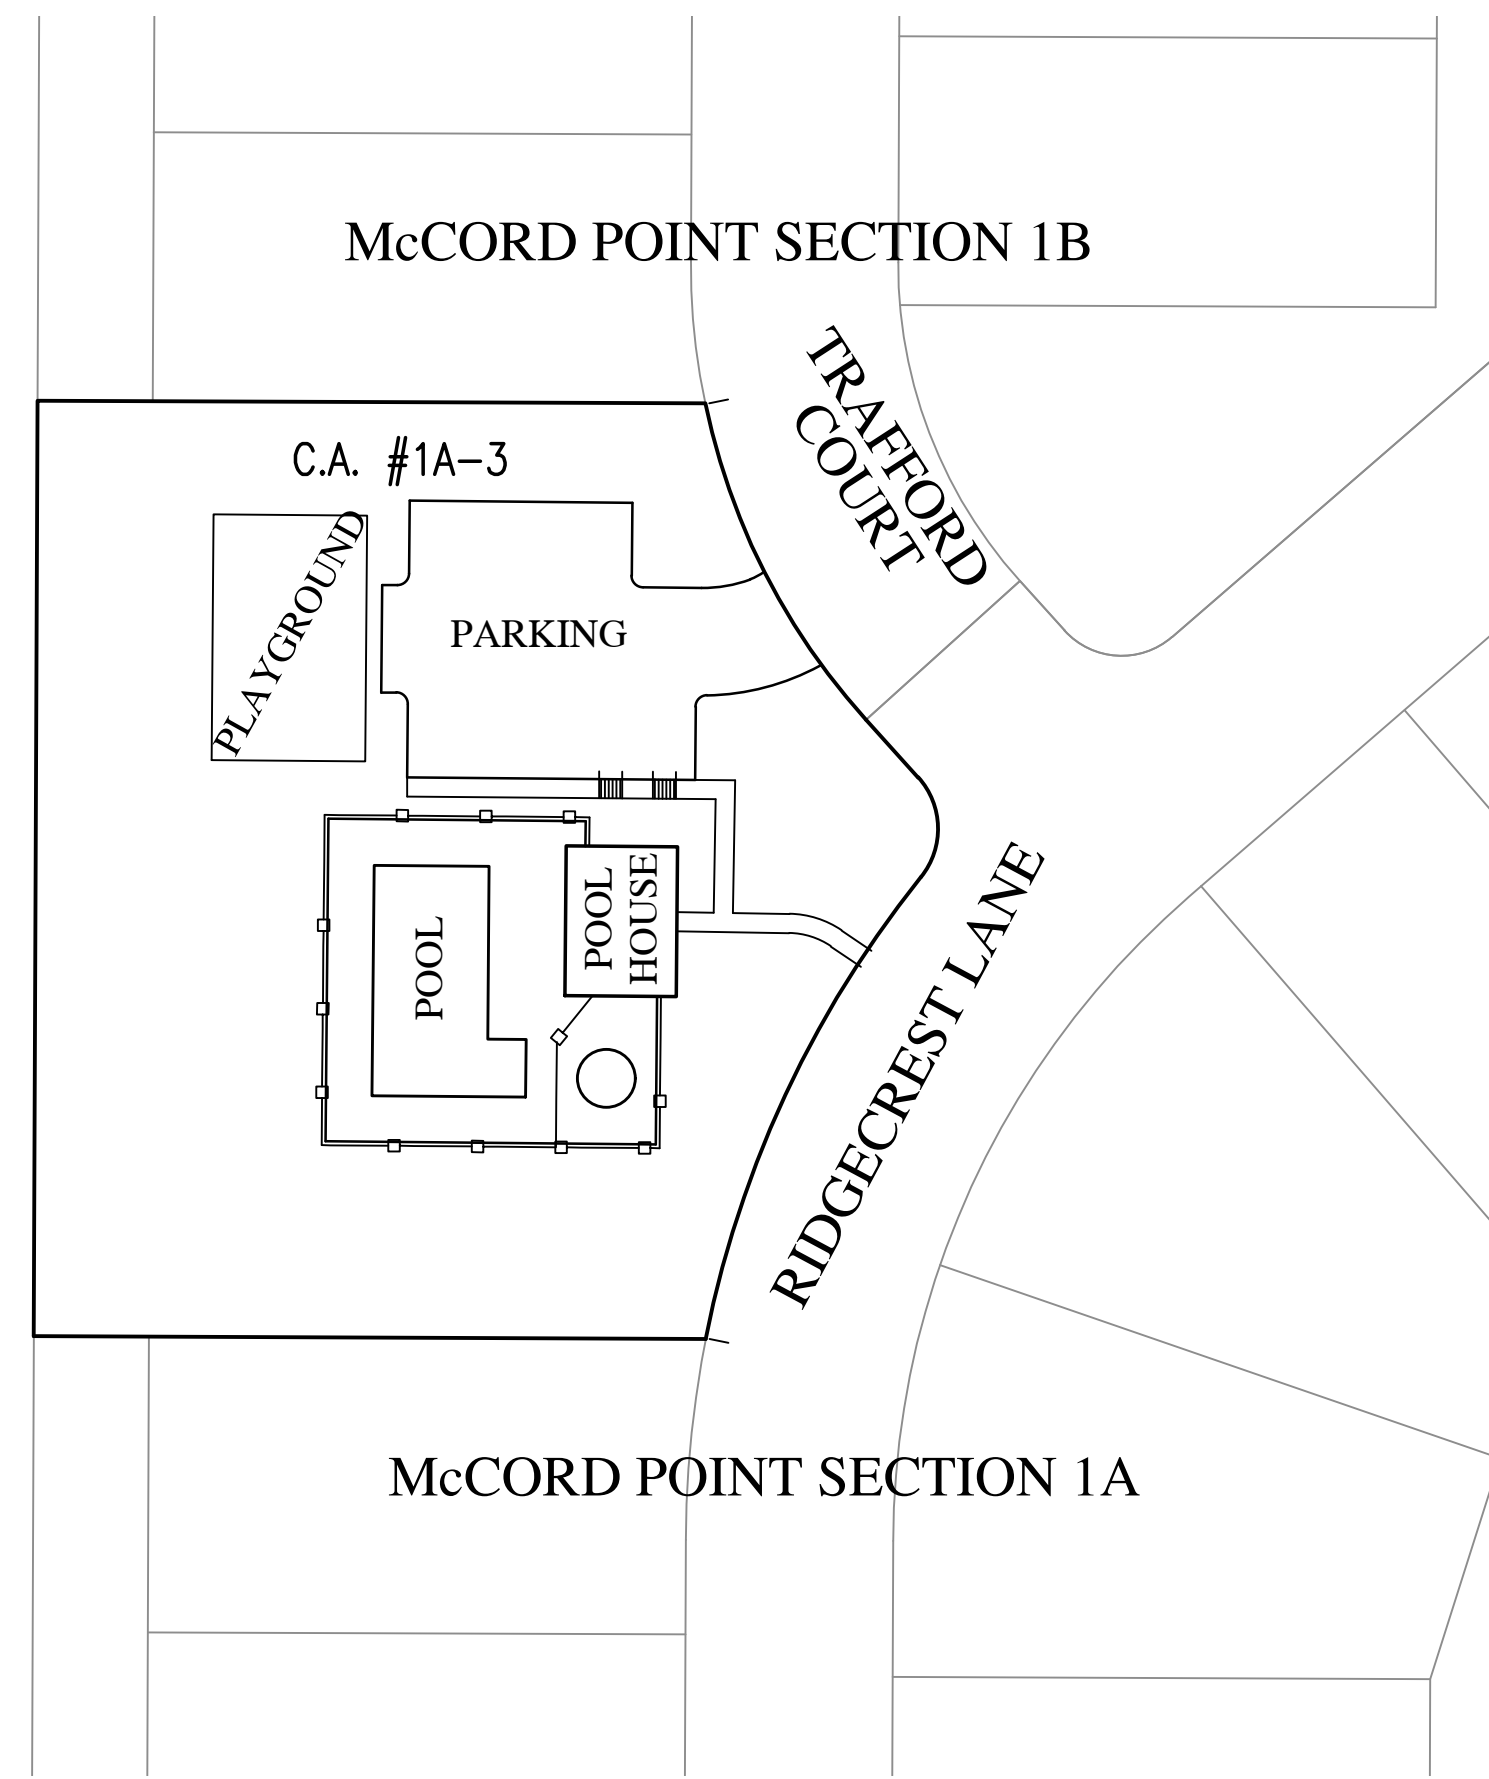

SITE MAP
SCALE: 1" = 50'

BENCHMARK INFORMATION:

CUT SQUARE ON BACK OF CURB AT INTERSECTION OF NORTH ANCHOR BEND AND NORTH MARINERS CREST. SQUARE IS AT THE NORTH EAST PORTION OF INTERSECTION 3' WEST OF A FIRE HYDRANT.
ELEVATION = 847.28 (NGVD 29)

CONTACT INFORMATION:


CITIZENS ENERGY GROUP/ CWA AUTHORITY, INC. (WATER) BRAD HOSTETLER 2150 DR. MARTIN LUTHER KING JR. STREET INDIANAPOLIS, INDIANA 46202 P: (317) 927-4351 BHOSTETLER@CITIZENSENERGYGROUP.COM	NINESTAR CONNECT (Electric & Telecom) ERIC MEYER (317) 323-2074 2243 East Main Street Greenfield, Indiana 46140 EMEYER@NINESTARCONNECT.COM	COMCAST MATT STRINGER 5330 E. 65th Street Indianapolis, IN 46220 P: (317) 774-3384 F: (317) 219-5090 matthew_stringer@cable.comcast.com	VECTREN SANDRA CASEY 16000 Allisonville Road Noblesville, Indiana 46061 P: (317) 776-5532 F: (317) 776-5553 Mailing Address: P.O. Box 1700 Noblesville, Indiana 46061 sandra.casey@centerpointenergy.com
McCORDSVILLE FIRE DEPARTMENT 7580 N Form Street McCordsville, Indiana 46055 P: (317) 335-9236	TOWN OF McCORDSVILLE PLANNING AND BUILDING DEPT RYAN CRUM 6280 W 800 N McCordsville, Indiana 46055 P: (317) 335-3604 rcrum@mccordsville.org	TOWN OF McCORDSVILLE ENGINEERING DEPARTMENT MARK WITSMAN 6280 W 800 N McCordsville, IN 46055 P: (317) 335-3604 mwitsman@mccordsville.org	TOWN OF McCORDSVILLE PUBLIC WORKS RON CRIDER 6280 W 800 N McCordsville, IN 46055 P: (317) 335-3493 rcrider@mccordsville.org

SITE DATA

LOTS: 0
 DISTURBED AREA: 1.0 AC
 START CONSTRUCTION: SEPTEMBER 2020
 END CONSTRUCTION: APRIL 2021
 ZONED McCORD POINTE AMENDED PUD ORDINANCE NO. 101017B, AN ORDINANCE AMENDING THE TOWN OF McCORDSVILLE ZONING ORDINANCE NO. 121410, AS AMENDED.

PLAN COMMISSION APPROVAL	_____
DRAINAGE APPROVAL	_____
ADDRESS APPROVAL	_____
EROSION CONTROL APPROVAL	_____
COUNTY ENGINEER APPROVAL	_____
COUNTY SANITARIAN APPROVAL	_____
COUNTY COMMISSIONERS APPROVAL	_____

REVISIONS		
DATE	DESCRIPTION	BY

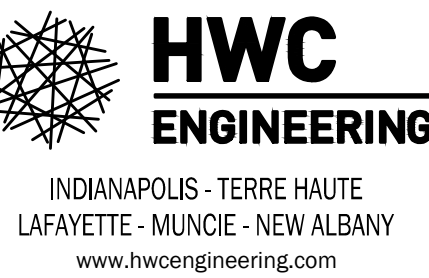


MCCORD POINTE
 MCCORDSVILLE, INDIANA
 COVER




DRAWN BY	DC
CHECKED BY	KE
DATE	JANUARY 17, 2020
SCALE	AS SHOWN
SHEET	C1.0
JOB NUMBER	2019-003-A
COVER	

PLANT SCHEDULE:

KEY	BOTANICAL NAME	COMMON NAME	QUANTITY	CALIPER	HGT	ROOT	SPACING	REMARKS
SHADE TREES								
ACE-S	ACER SACCHARUM	SUGAR MAPLE	2	2.5"	12'	B&B	SEE PLAN	CENTRAL LEADER
TIL-T	TILIA TOMENTOSA	SILVER LINDEN	2	2.5"	12'	B&B	SEE PLAN	CENTRAL LEADER
ORNAMENTAL TREES								
CER-C	CERCIS CANADENSIS	REDBUD	1	1.5"	8'	B&B	SEE PLAN	CENTRAL LEADER
DECIDUOUS SHRUBS								
HYD-Q	HYDRANGEA QUERCIFOLIA 'SNOW QUEEN'	SNOW QUEEN HYDRANGEA	10	-	24"	#5 CONT	36" O.C.	FULL IN POT
FOT-G	FOTHERGILLA GARDENII	DWARF FOTHERGILLA	14	-	24"	#5 CONT	36" O.C.	FULL IN POT
EVERGREEN SHRUBS								
BUX-G	BUXUS X 'GREEN MOUNTAIN'	GREEN GREEN MOUNTAIN BOXWOOD	17	-	24"	#5 CONT	36" O.C.	FULL IN POT
ILE-G	ILEX GLABRA 'DENSA'	DENSA COMPACT INKBERRY	6	-	24"	#5 CONT	48" O.C.	FULL IN POT
PIC-O	PICEA OMORIKA 'NANA'	DWARF SERBIAN SPRUCE	15	-	24"	#10 CONT	48" O.C.	FULL IN POT
GROUNDCOVERS								
CAR-P	CAREX PENNSYLVANICA	PENNSYLVANIA SEDGE	115	-	-	CLUMP #2 CONT	24" O.C.	FULL IN POT

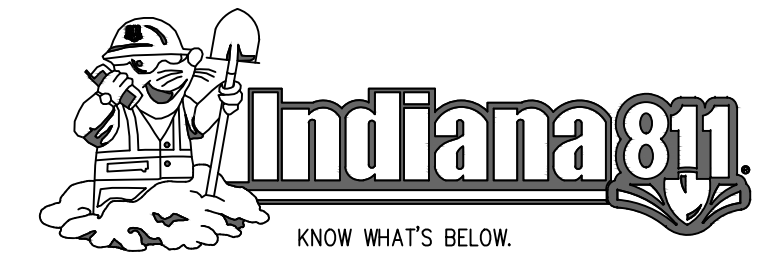

Call 811 or 800-382-5544 Before you Dig!

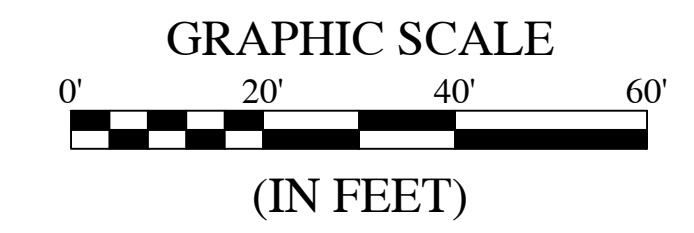

LEGEND:

- [XXXX] QUANTITY / KEY
- SHADE TREE - 2 1/2" CALIPER
- SHADE TREE - MULTI TRUNK
- ⊗ EVERGREEN TREE
- ⊙ ORNAMENTAL TREE - 1 1/2" CALIPER
- ⊘ DECIDUOUS SHRUB
- ⊙ EVERGREEN SHRUB
- ▨ GROUNDCOVER
- SPADE EDGE BED LINE
- SEE PLANTING BED PERIMETER DETAIL FOR INFORMATION

NOTES:

- LANDSCAPING AS SHOWN SUBJECT TO UTILITIES, GRADING AND DRAINAGE IMPROVEMENTS AND EASEMENTS.
- ALL LANDSCAPING WITHIN THE ENTRANCE MEDIAN WILL BE MAINTAINED BY THE HOA.
- STREET TREES SHALL BE INSTALLED IN THE LOCATION SHOWN ON THE PLANS.
- ALL PLANTING BEDS WITH ADJOINING LAWN AREAS SHALL BE EDGED WITH A SPADE, UNLESS NOTED OTHERWISE.
- MULCH: FINELY SHREDDED HARDWOOD BARK, AGED TO BE APPLIED AT A THREE (3) INCH DEPTH FOR ALL PLANTING BEDS AND TREE SAUCERS.

PARKING REQ. (5309 SFT):

- ONE SHADE TREE PER 2,400 SQUARE FEET OF SURFACE AREA
- ONE SHRUB PER 500 SQUARE FEET OF SURFACE AREA

	TREES	SHRUBS
REQUIRED:	2	10
PROVIDED:	4	33


PARKING PERIMETER REQ. (65 LFT):

- A PERIPHERAL LANDSCAPING STRIP FOUR FEET WIDE SHALL BE INSTALLED ALONG THE SIDE OF ANY PARKING AREA THAT ABUTS ANY SIDE OR REAR PROPERTY LINE. AT LEAST ONE TREE FOR EACH 50 LINEAL FEET

REQUIRED:	1
PROVIDED:	1


BUILDING PERIMETER REQ.:

- A PLANTING AREA FIVE FEET WIDE SHALL BE INSTALLED ALONG ALL SIDES OF BUILDINGS

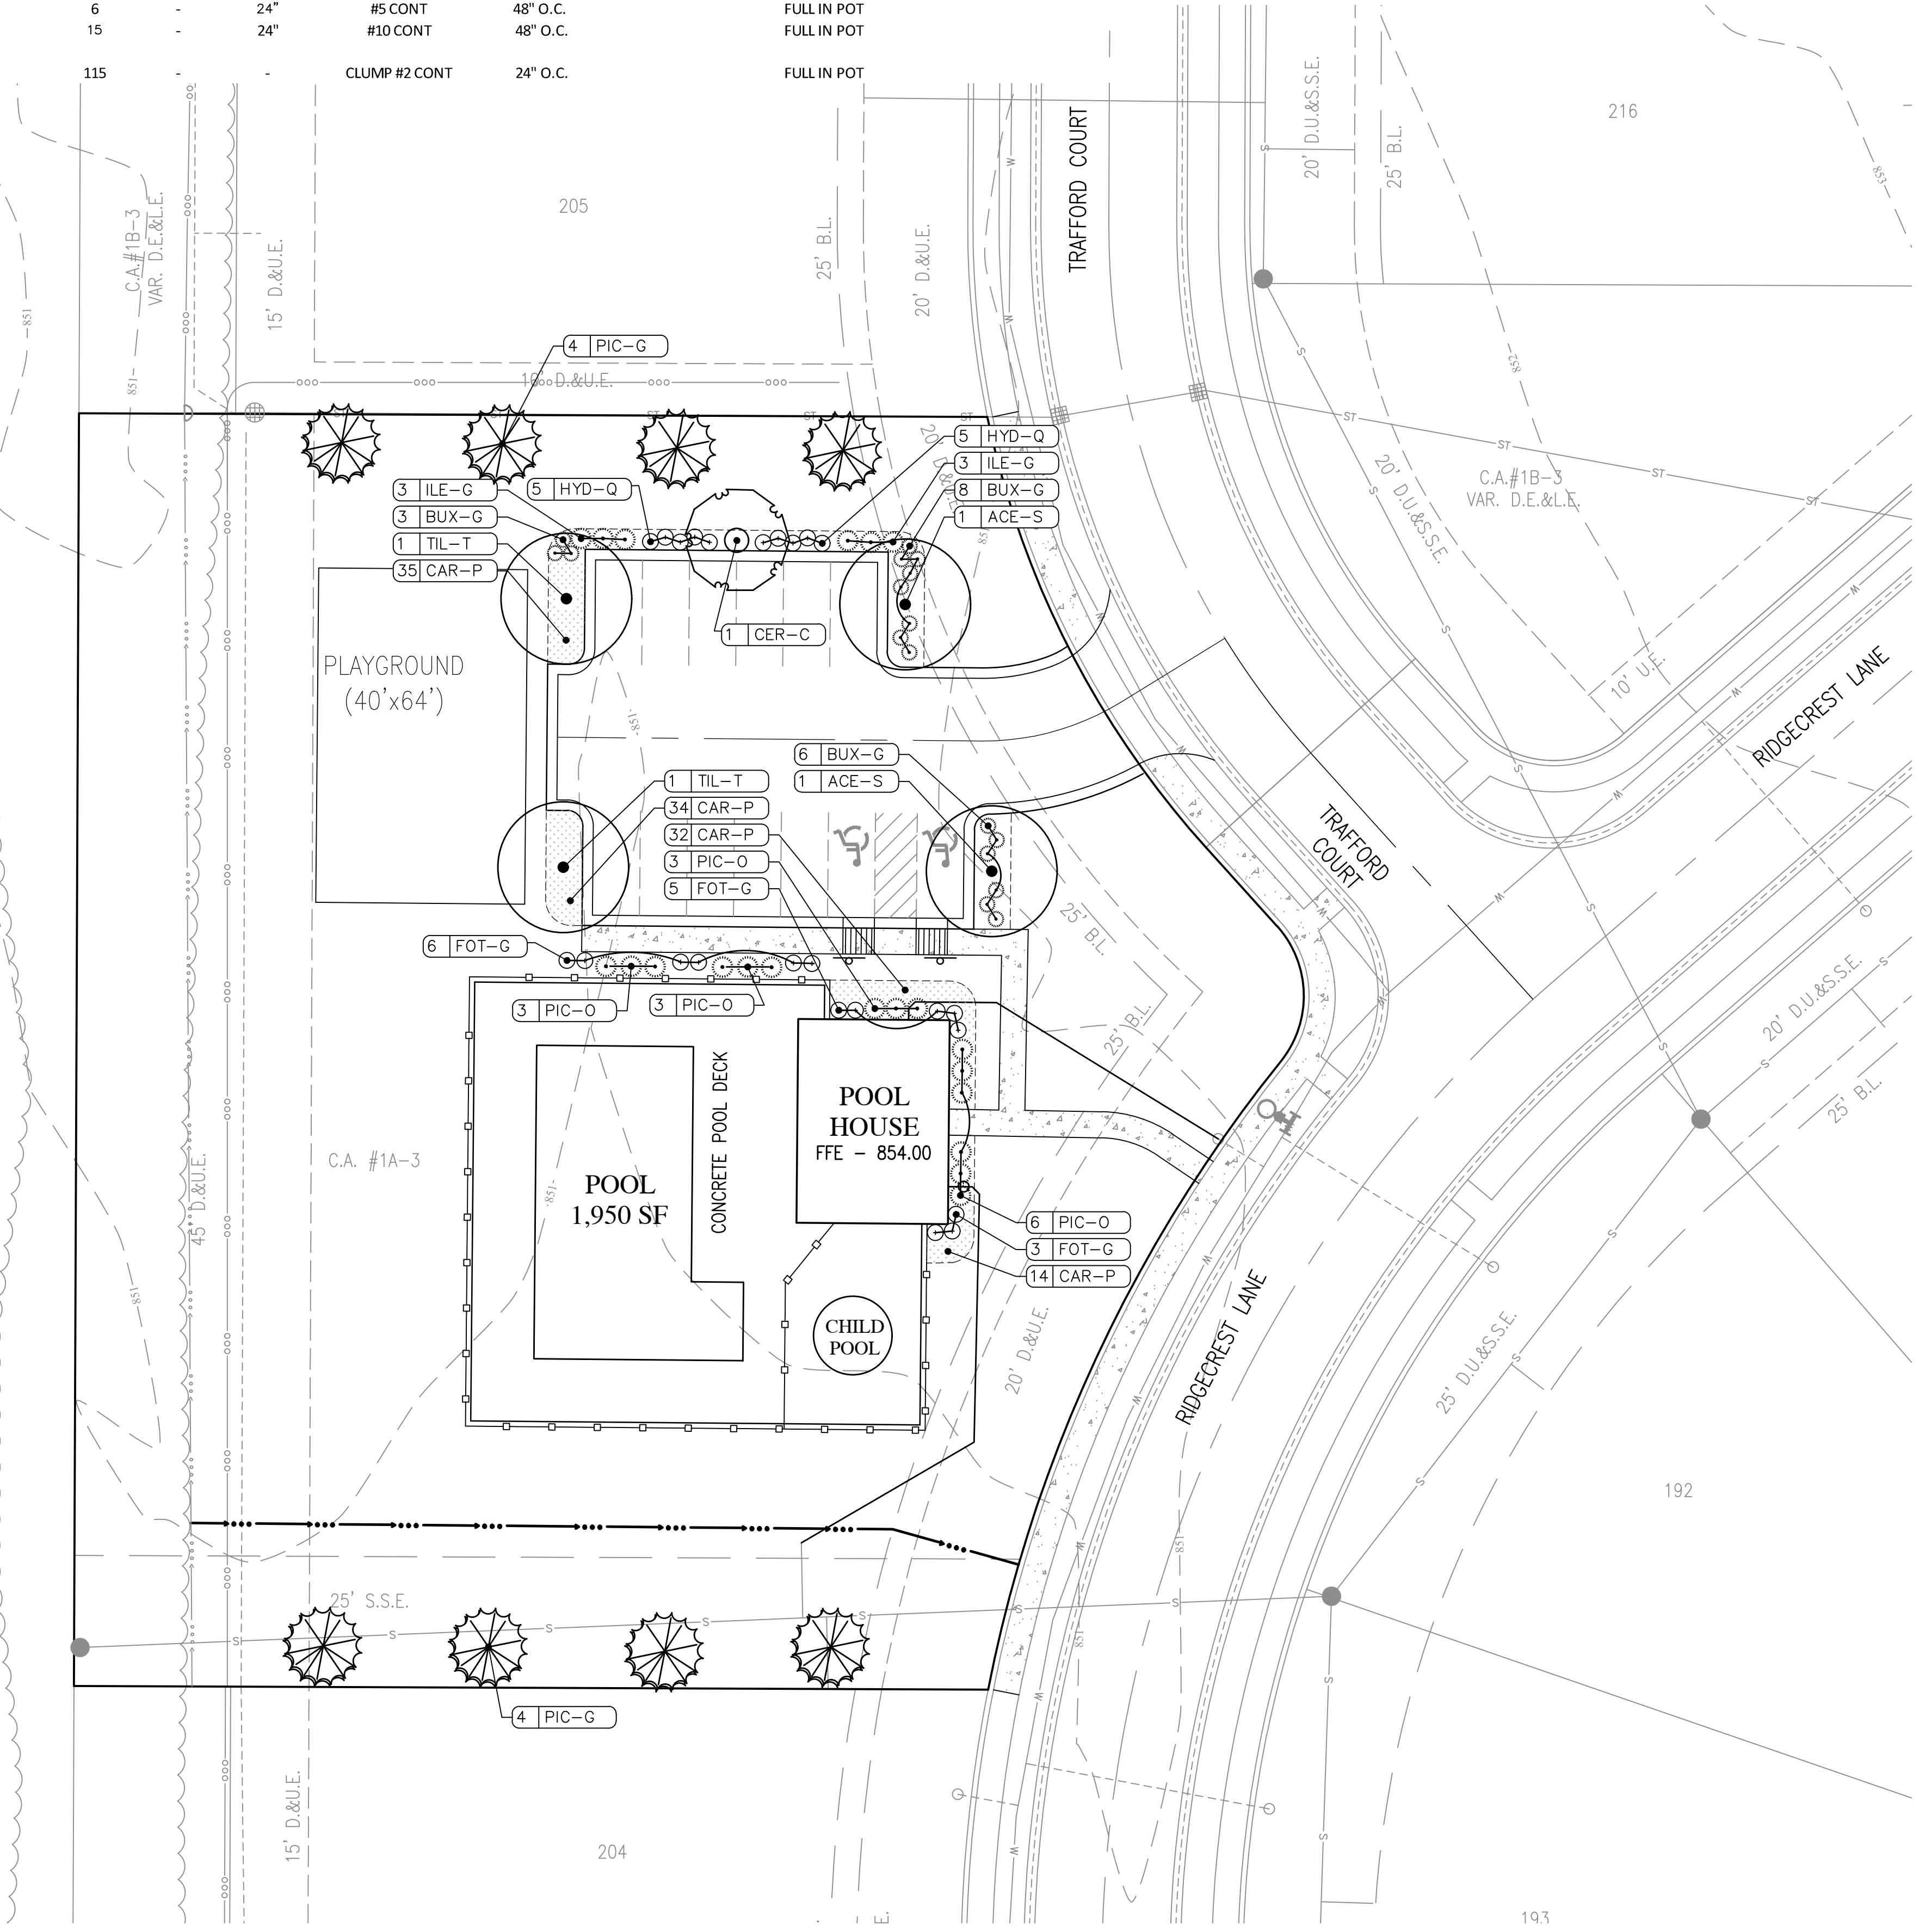

PREPARED BY:
HWC ENGINEERING
135 N. PENNSYLVANIA ST., SUITE 2800
INDIANAPOLIS, IN 46204
P: 317-347-3663

REVISIONS		
DATE	DESCRIPTION	BY

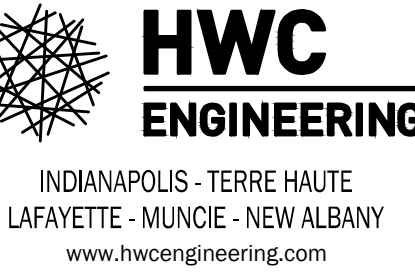

MCCORD POINTE AMENITY AREA LANDSCAPE PLAN




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CHECKED BY	KE
DATE	JANUARY 17, 2020
SCALE	AS SHOWN
SHEET	---

L1.0
LANDSCAPE PLAN


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 Mar 17, 2020

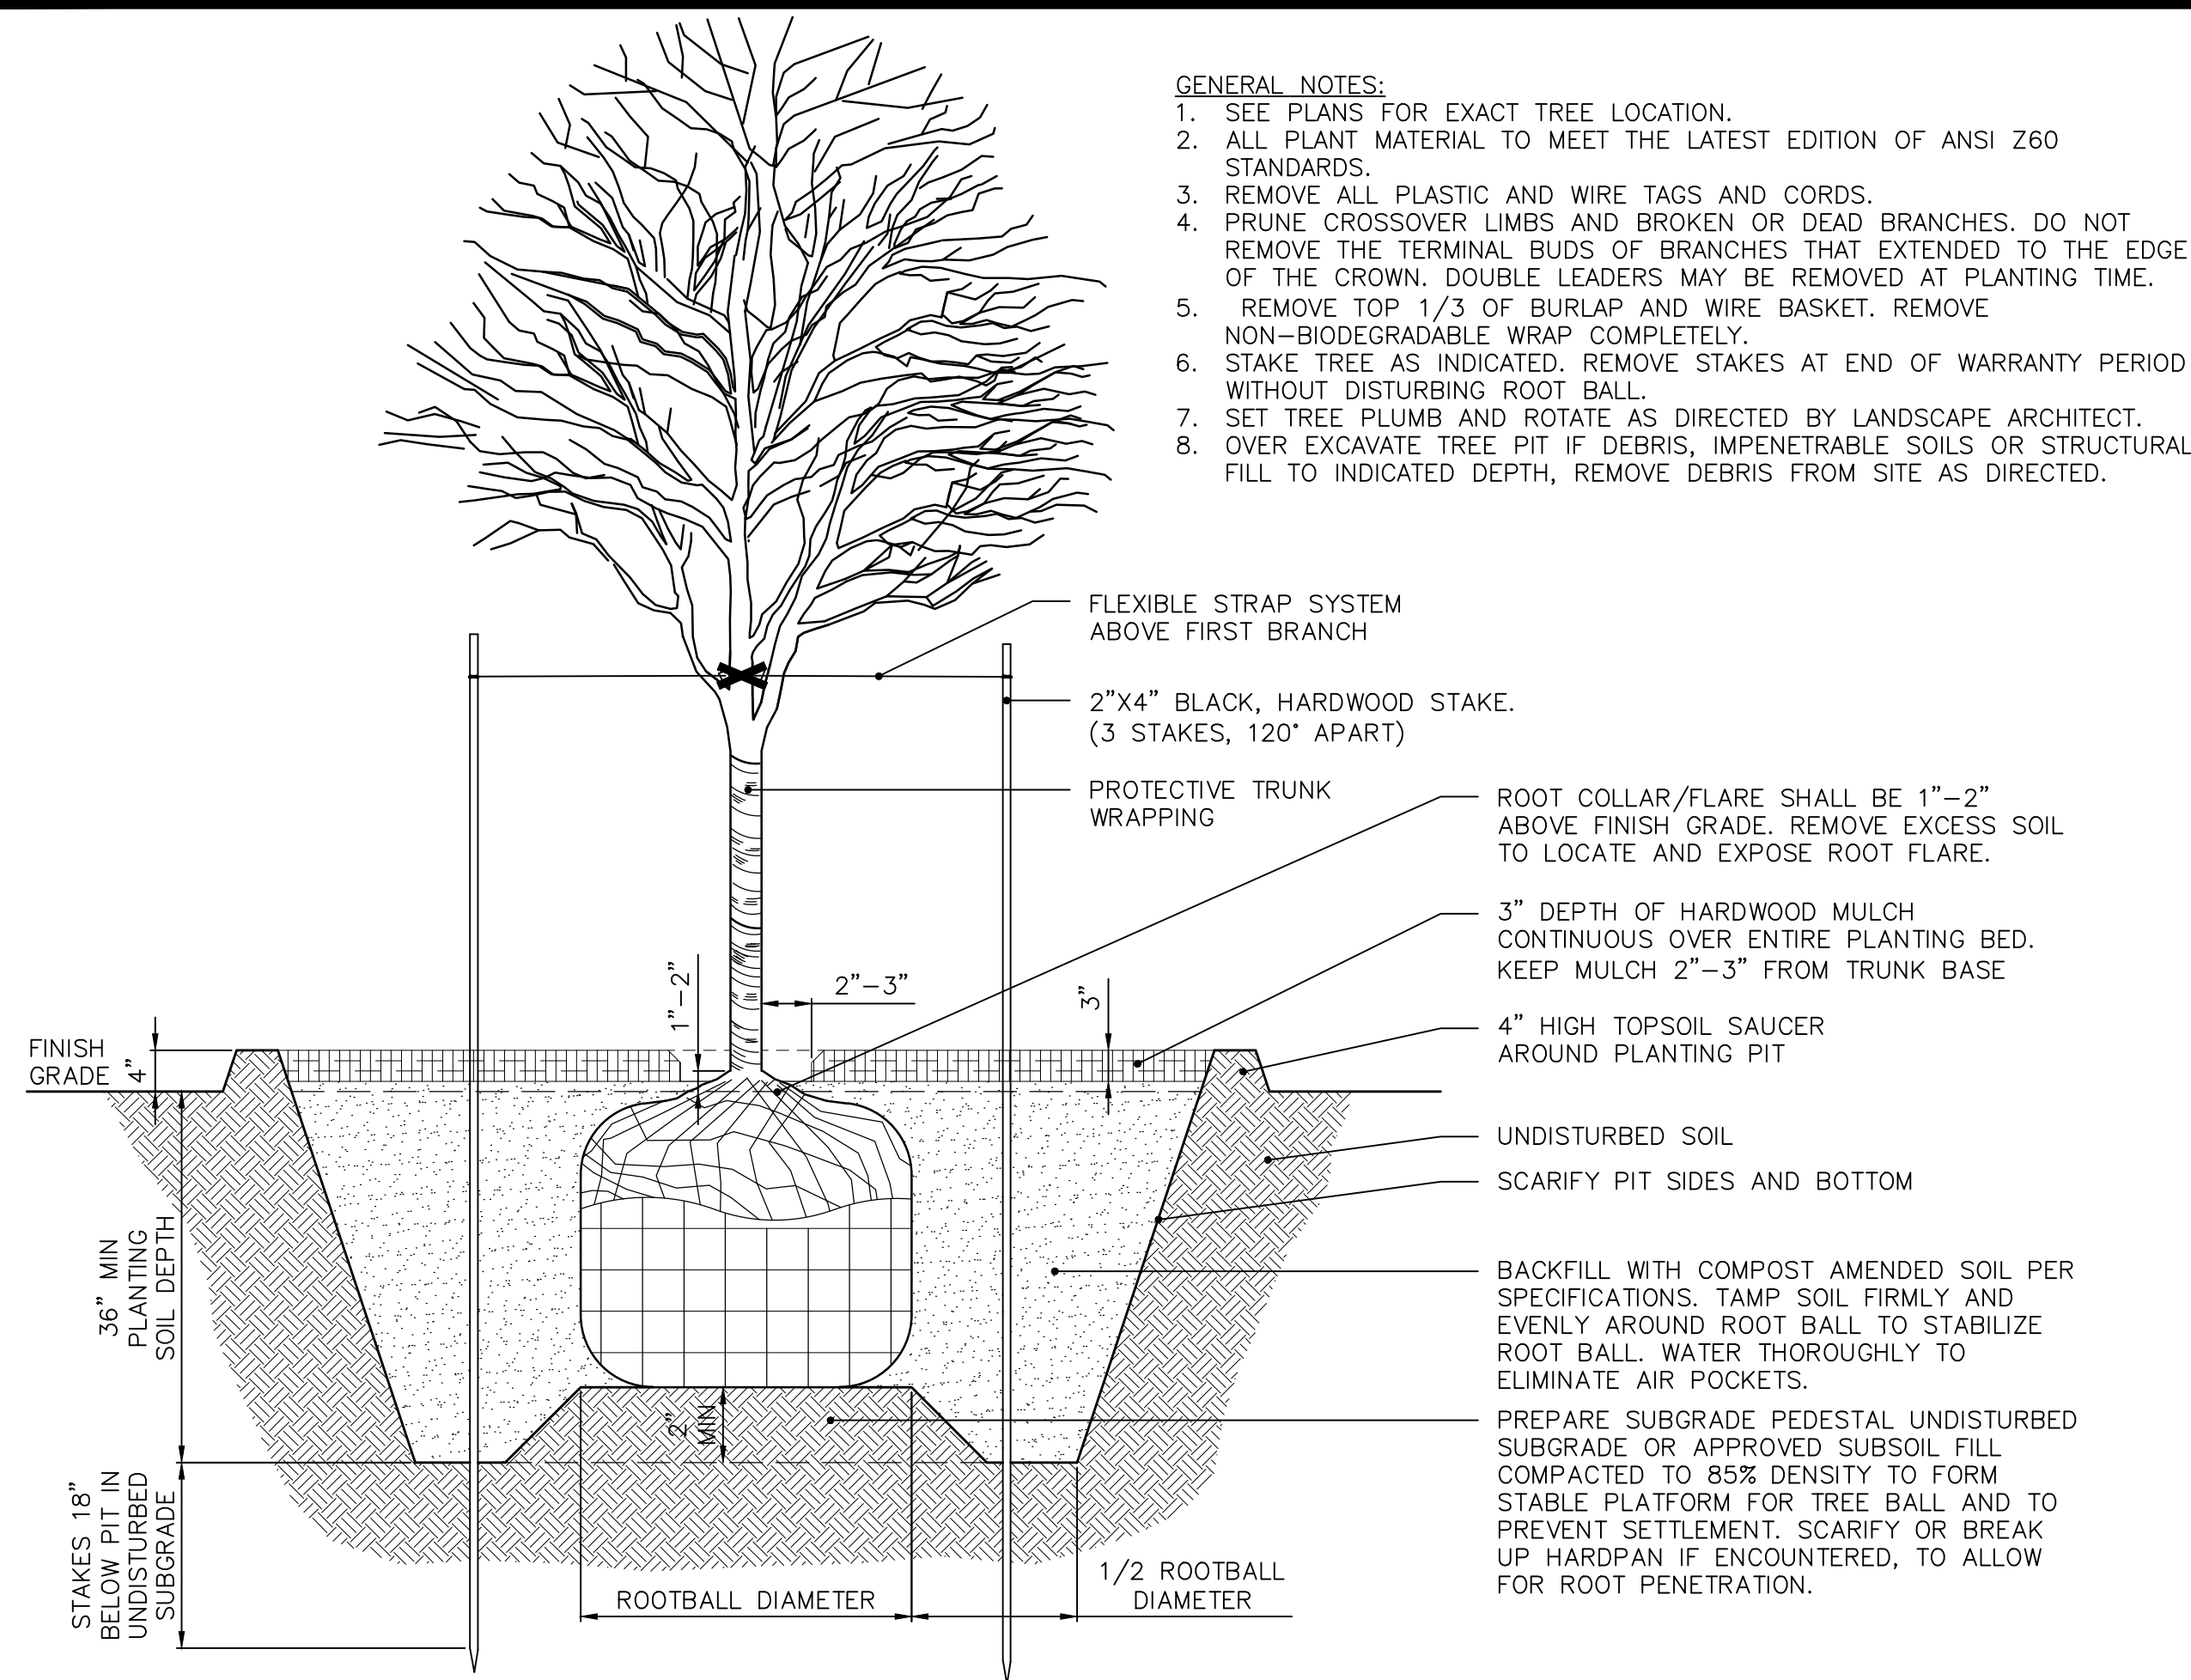


- GENERAL NOTES:**
1. SEE PLANS FOR EXACT TREE LOCATION.
 2. ALL PLANT MATERIAL TO MEET THE LATEST EDITION OF ANSI Z60 STANDARDS.
 3. REMOVE ALL PLASTIC AND WIRE TAGS AND CORDS.
 4. PRUNE CROSSOVER LIMBS AND BROKEN OR DEAD BRANCHES. DO NOT REMOVE THE TERMINAL BUDS OF BRANCHES THAT EXTENDED TO THE EDGE OF THE CROWN. DOUBLE LEADERS MAY BE REMOVED AT PLANTING TIME.
 5. REMOVE TOP 1/3 OF BURLAP AND WIRE BASKET. REMOVE NON-BIODEGRADABLE WRAP COMPLETELY.
 6. STAKE TREE AS INDICATED. REMOVE STAKES AT END OF WARRANTY PERIOD WITHOUT DISTURBING ROOT BALL.
 7. SET TREE PLUMB AND ROTATE AS DIRECTED BY LANDSCAPE ARCHITECT.
 8. OVER EXCAVATE TREE PIT IF DEBRIS, IMPENETRABLE SOILS OR STRUCTURAL FILL TO INDICATED DEPTH, REMOVE DEBRIS FROM SITE AS DIRECTED.

1 SINGLE STEM TREE PLANTING
NOT TO SCALE

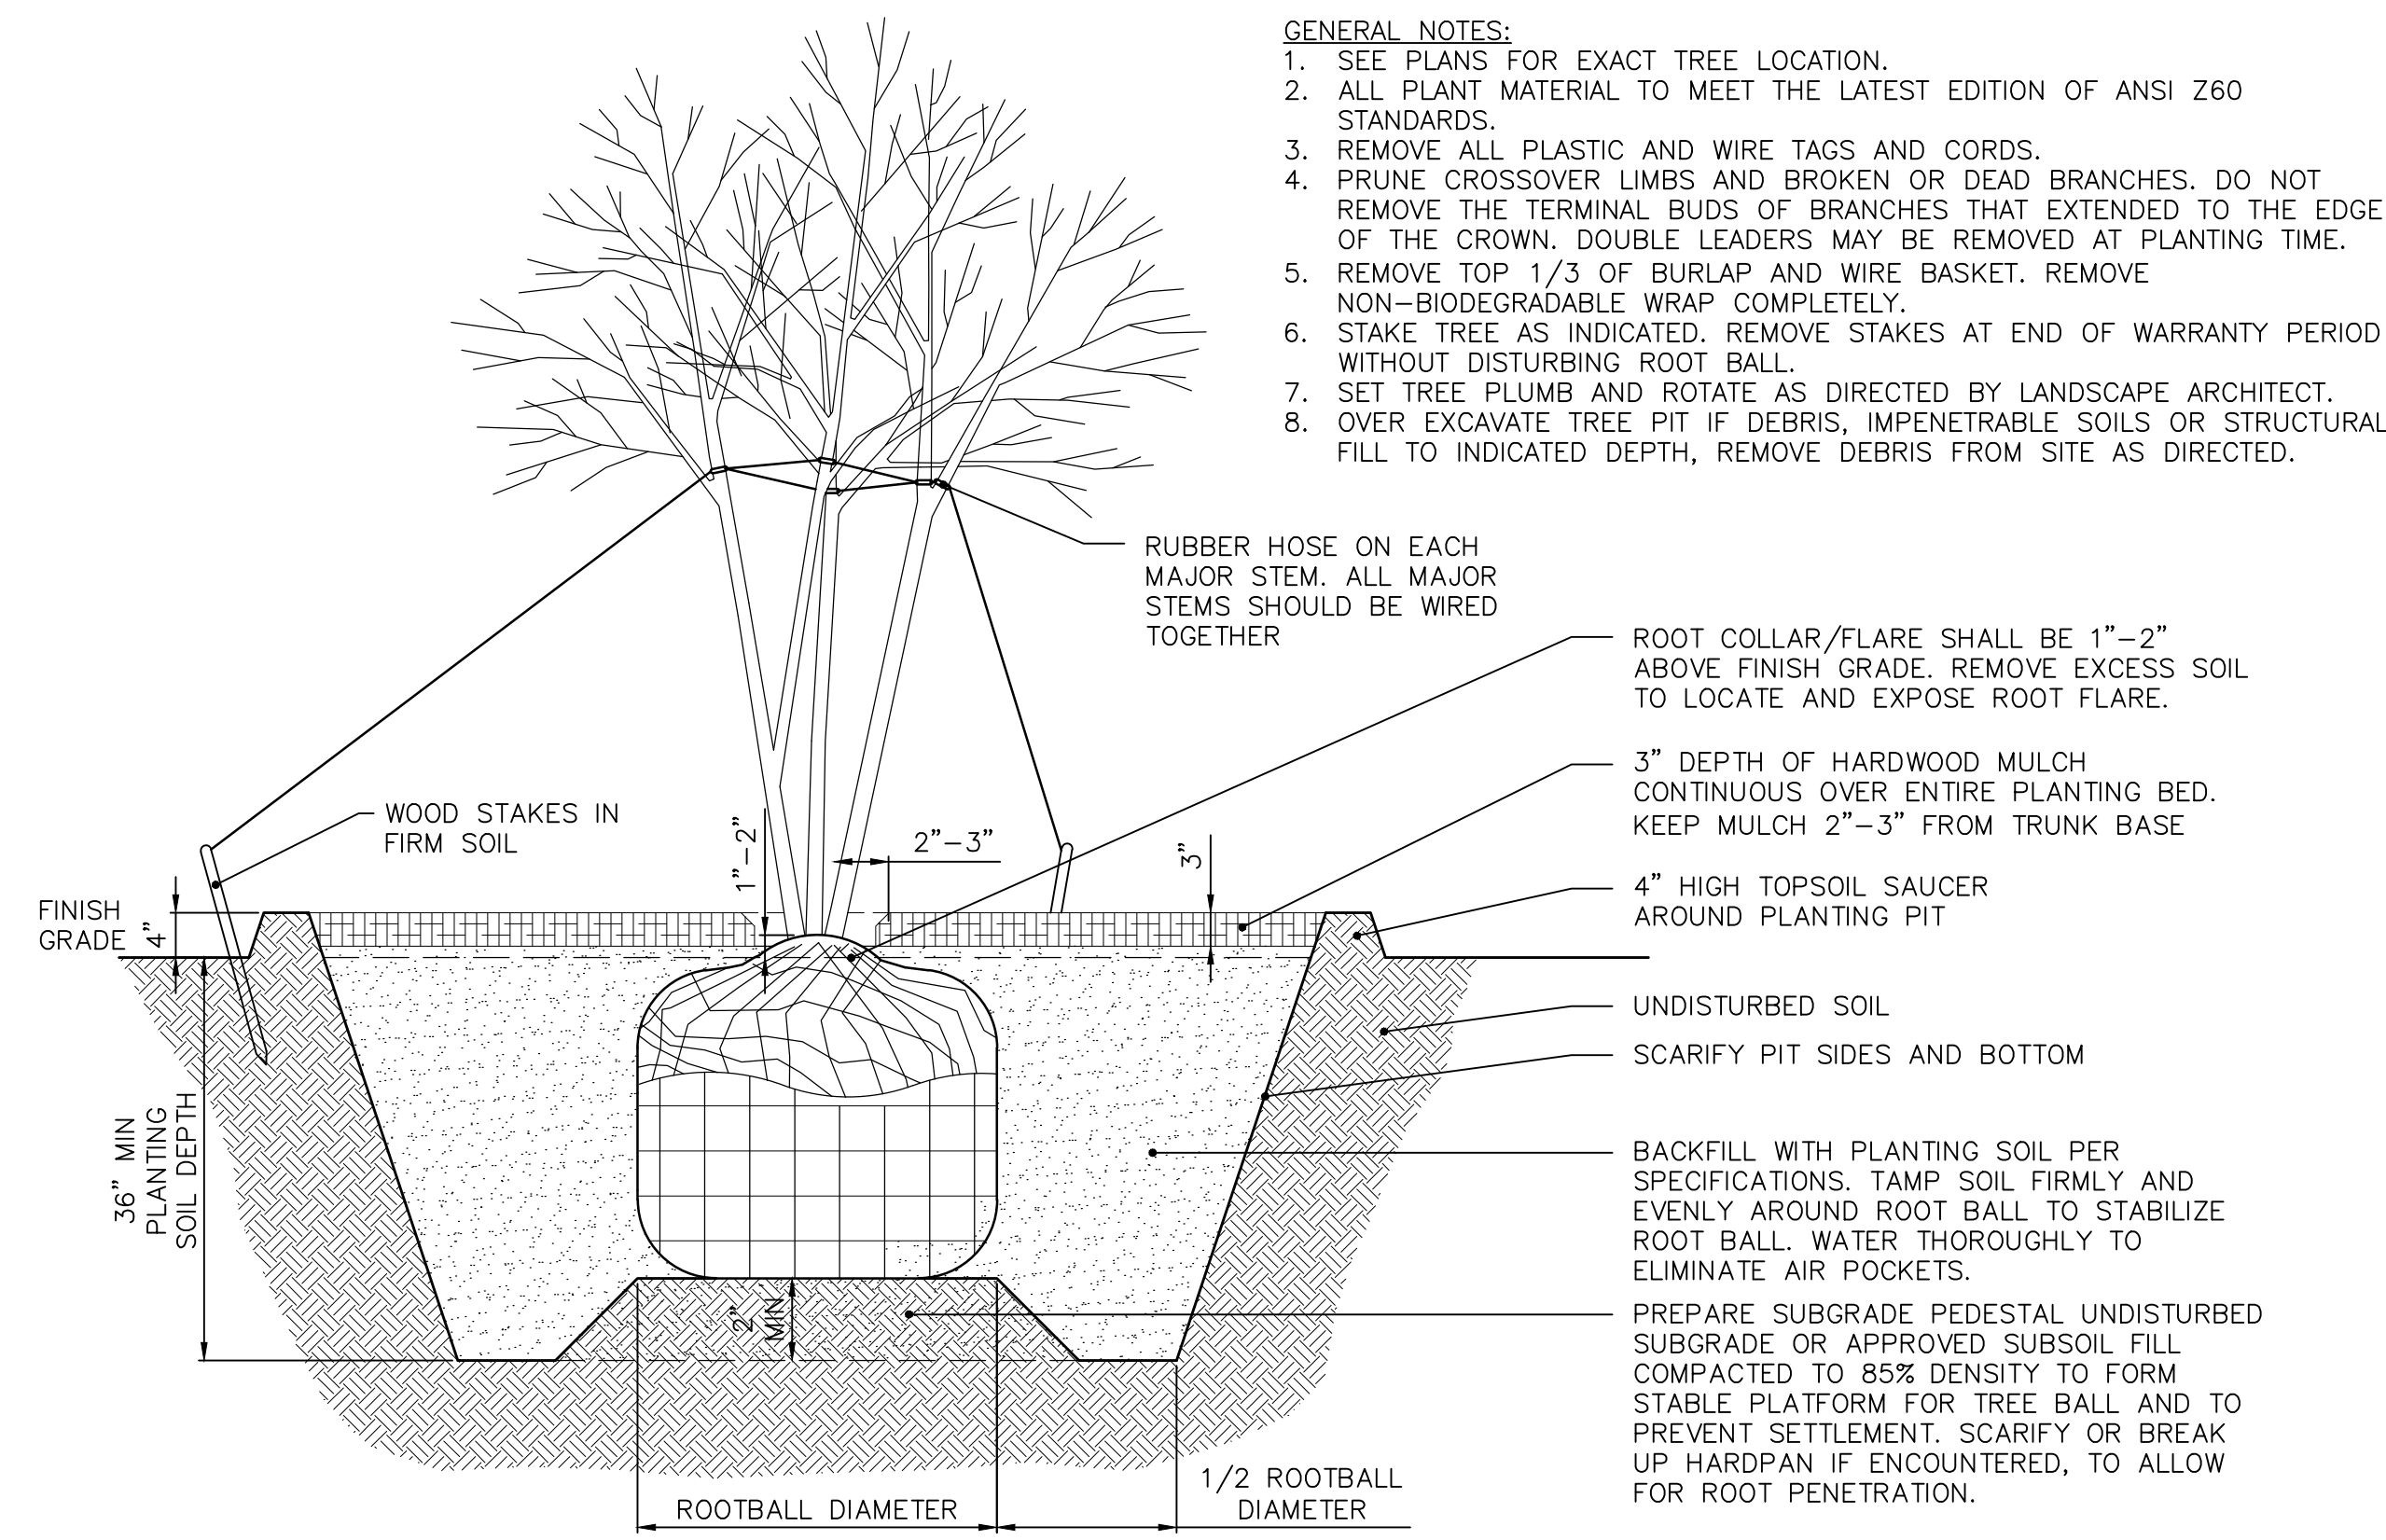


- GENERAL NOTES:**
1. SEE PLANS FOR EXACT TREE LOCATION.
 2. ALL PLANT MATERIAL TO MEET THE LATEST EDITION OF ANSI Z60 STANDARDS.
 3. REMOVE ALL PLASTIC AND WIRE TAGS AND CORDS.
 4. PRUNE CROSSOVER LIMBS AND BROKEN OR DEAD BRANCHES. DO NOT REMOVE THE TERMINAL BUDS OF BRANCHES THAT EXTENDED TO THE EDGE OF THE CROWN. DOUBLE LEADERS MAY BE REMOVED AT PLANTING TIME.
 5. REMOVE TOP 1/3 OF BURLAP AND WIRE BASKET. REMOVE NON-BIODEGRADABLE WRAP COMPLETELY.
 6. STAKE TREE AS INDICATED. REMOVE STAKES AT END OF WARRANTY PERIOD WITHOUT DISTURBING ROOT BALL.
 7. SET TREE PLUMB AND ROTATE AS DIRECTED BY LANDSCAPE ARCHITECT.
 8. OVER EXCAVATE TREE PIT IF DEBRIS, IMPENETRABLE SOILS OR STRUCTURAL FILL TO INDICATED DEPTH, REMOVE DEBRIS FROM SITE AS DIRECTED.

3 MULTI-STEM TREE PLANTING
NOT TO SCALE

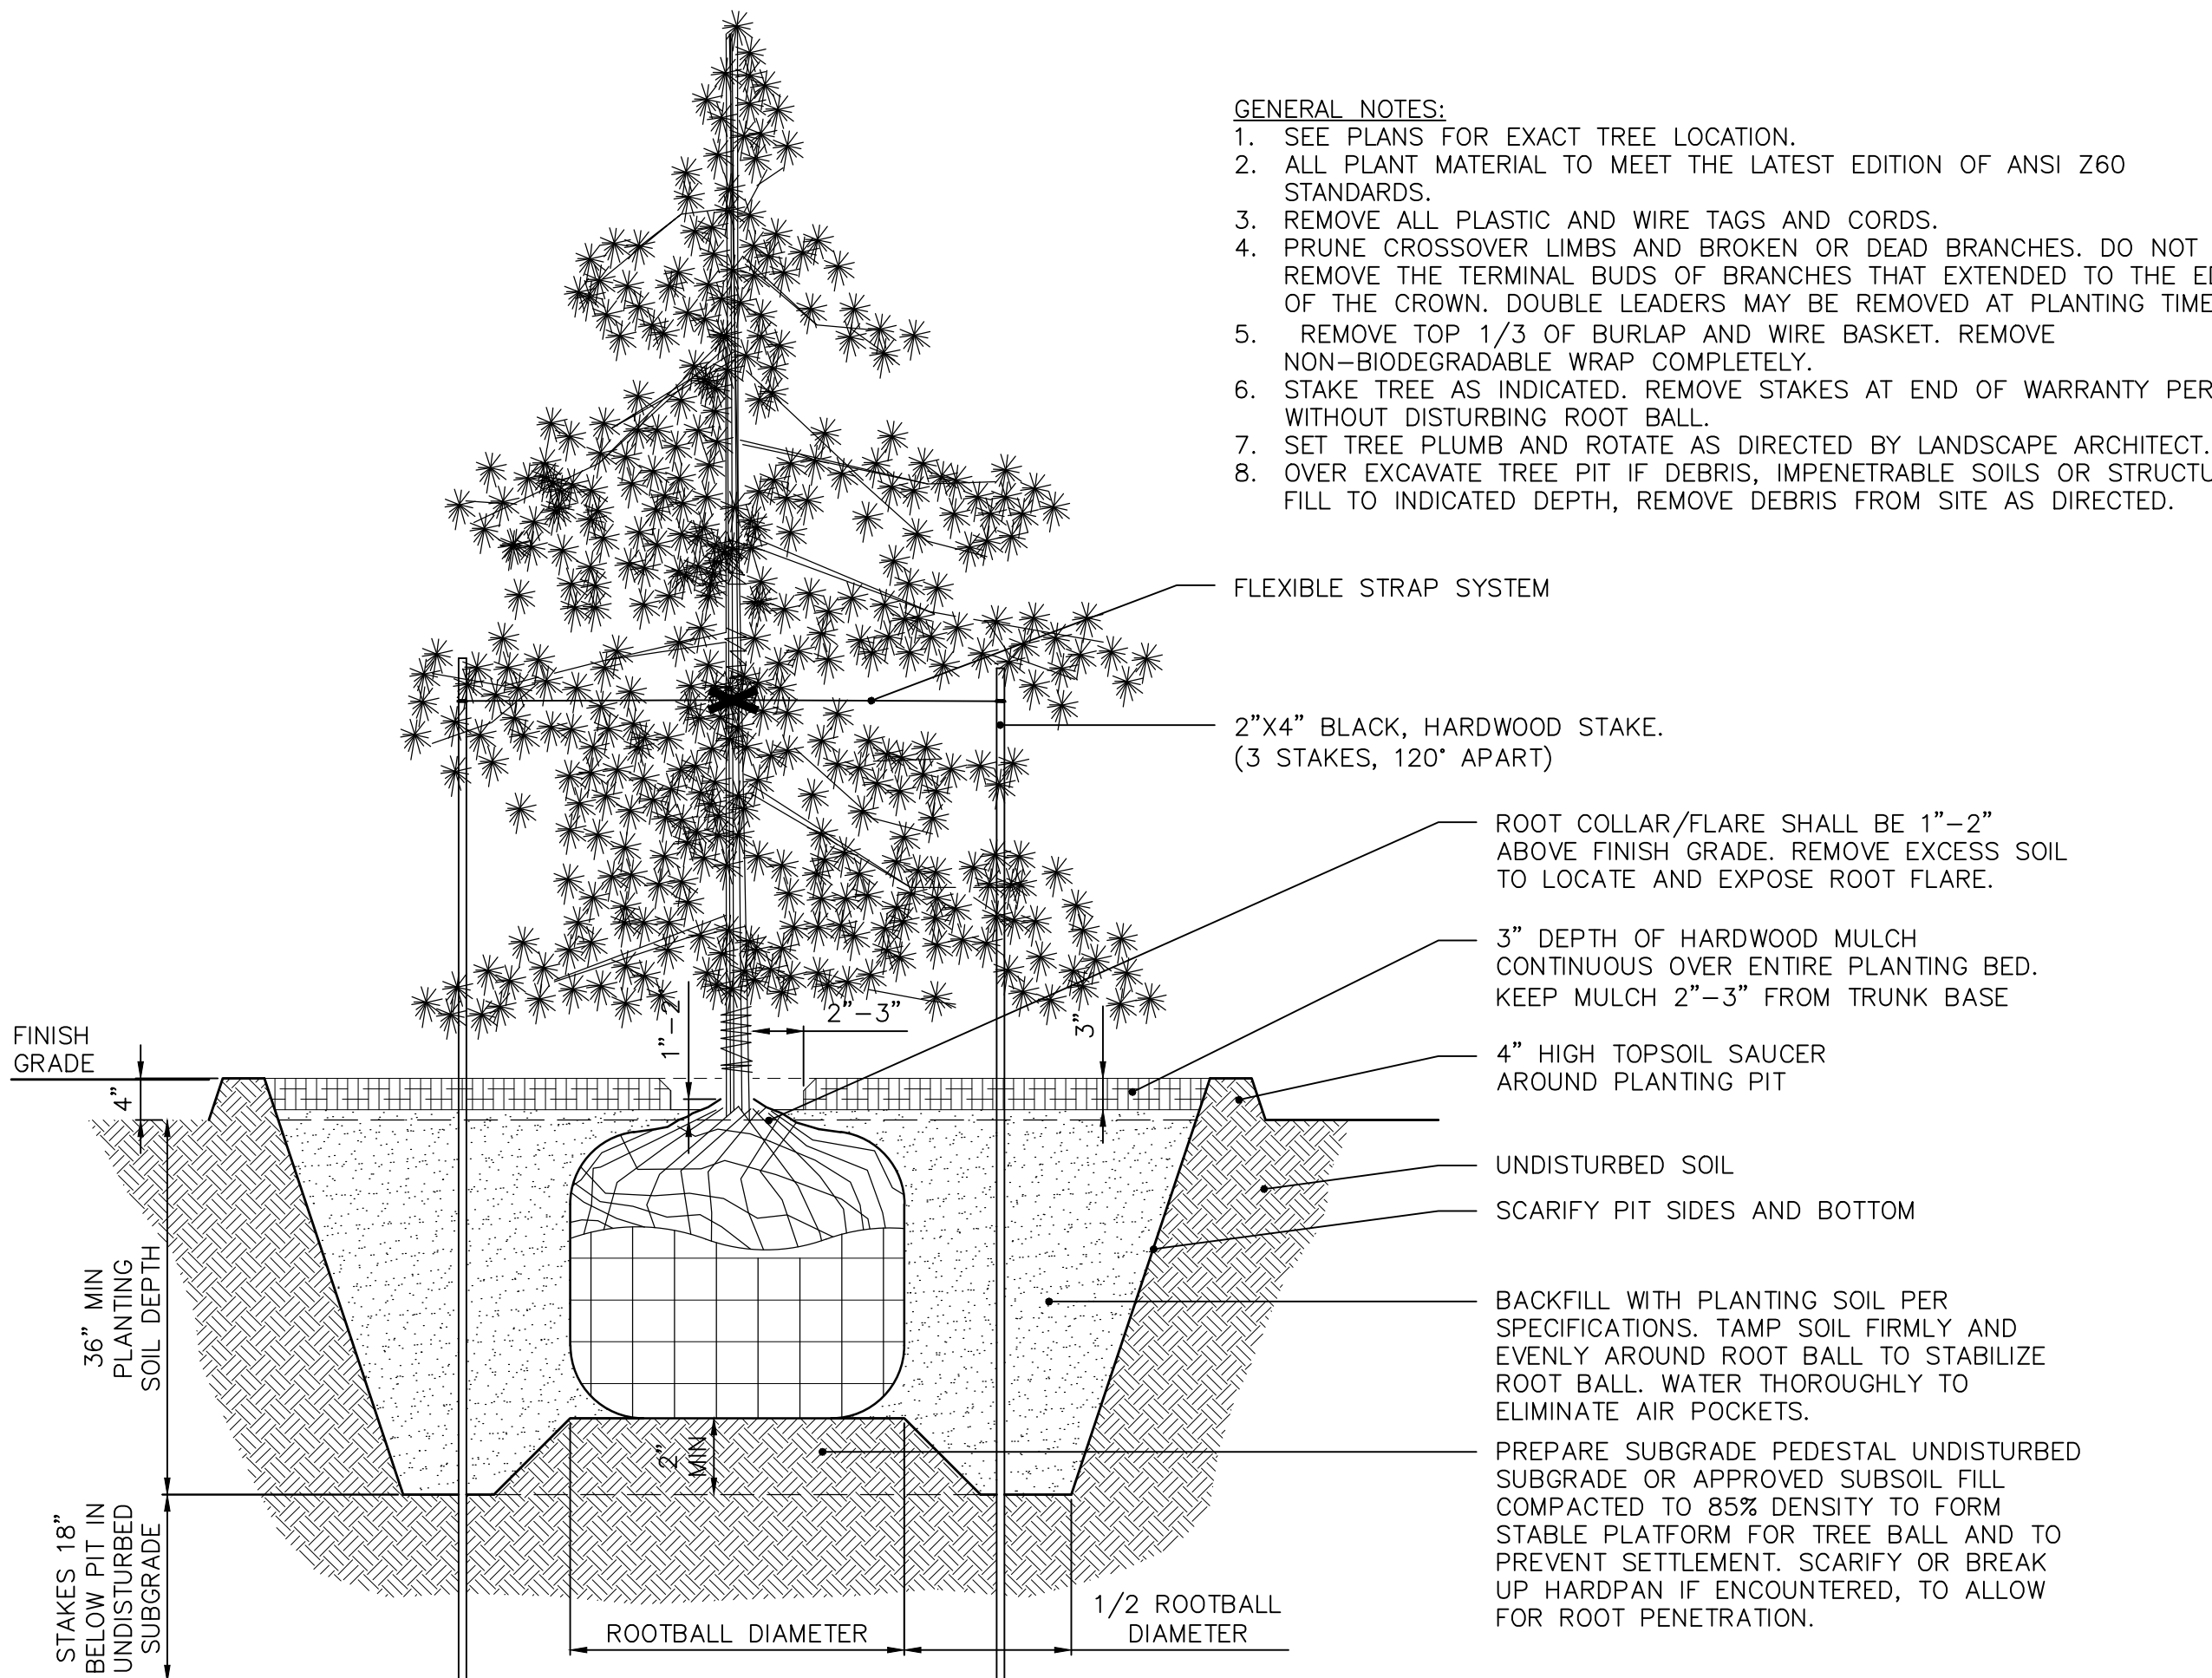


- GENERAL NOTES:**
1. SEE PLANS FOR EXACT TREE LOCATION.
 2. ALL PLANT MATERIAL TO MEET THE LATEST EDITION OF ANSI Z60 STANDARDS.
 3. REMOVE ALL PLASTIC AND WIRE TAGS AND CORDS.
 4. PRUNE CROSSOVER LIMBS AND BROKEN OR DEAD BRANCHES. DO NOT REMOVE THE TERMINAL BUDS OF BRANCHES THAT EXTENDED TO THE EDGE OF THE CROWN. DOUBLE LEADERS MAY BE REMOVED AT PLANTING TIME.
 5. REMOVE TOP 1/3 OF BURLAP AND WIRE BASKET. REMOVE NON-BIODEGRADABLE WRAP COMPLETELY.
 6. STAKE TREE AS INDICATED. REMOVE STAKES AT END OF WARRANTY PERIOD WITHOUT DISTURBING ROOT BALL.
 7. SET TREE PLUMB AND ROTATE AS DIRECTED BY LANDSCAPE ARCHITECT.
 8. OVER EXCAVATE TREE PIT IF DEBRIS, IMPENETRABLE SOILS OR STRUCTURAL FILL TO INDICATED DEPTH, REMOVE DEBRIS FROM SITE AS DIRECTED.


2 EVERGREEN TREE PLANTING
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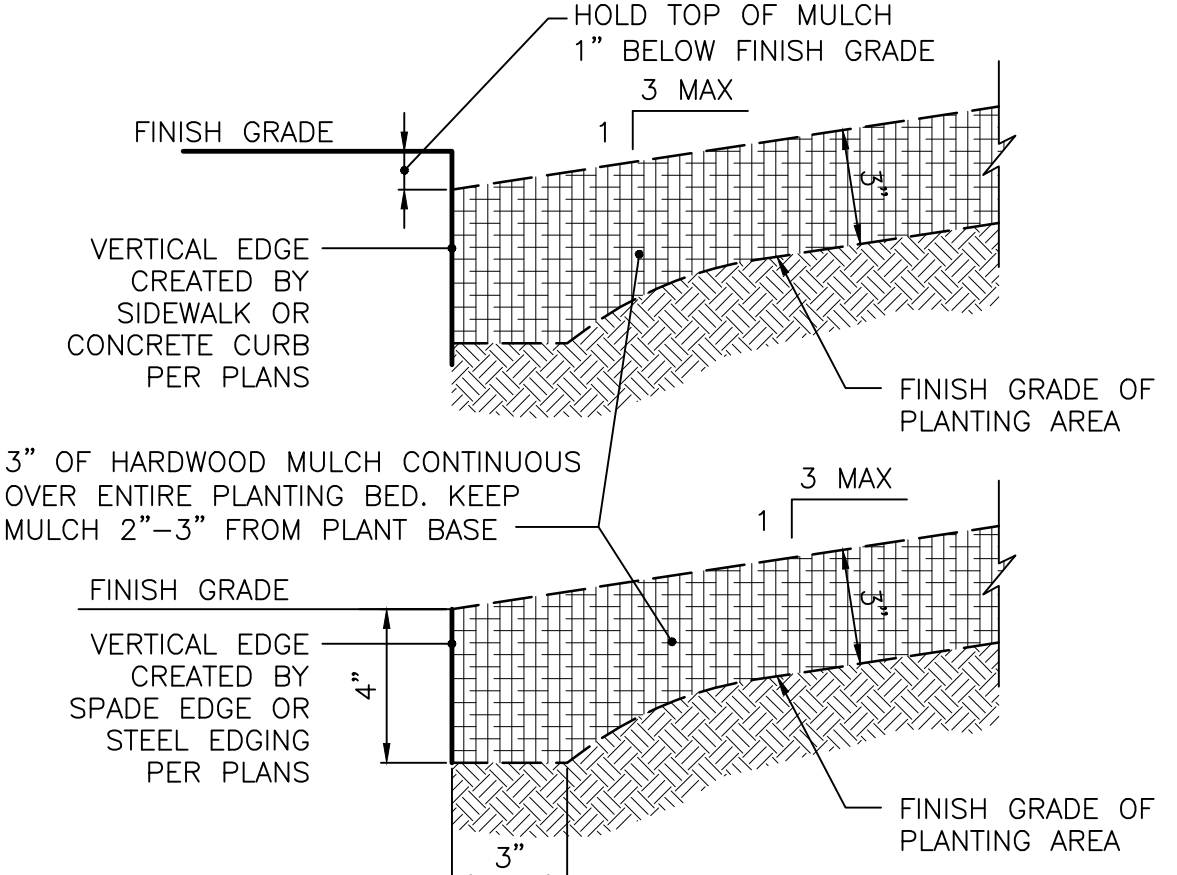
4 PLANT SPACING
NOT TO SCALE

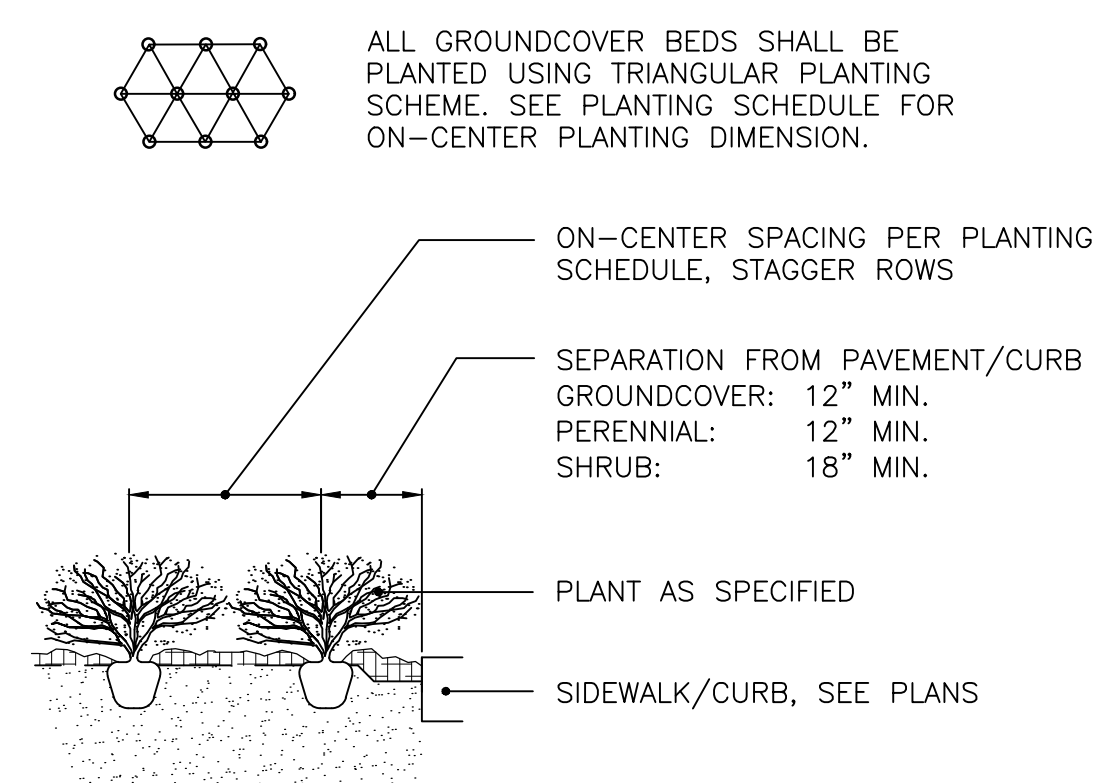

6 PERENNIALS AND GRASSES
NOT TO SCALE

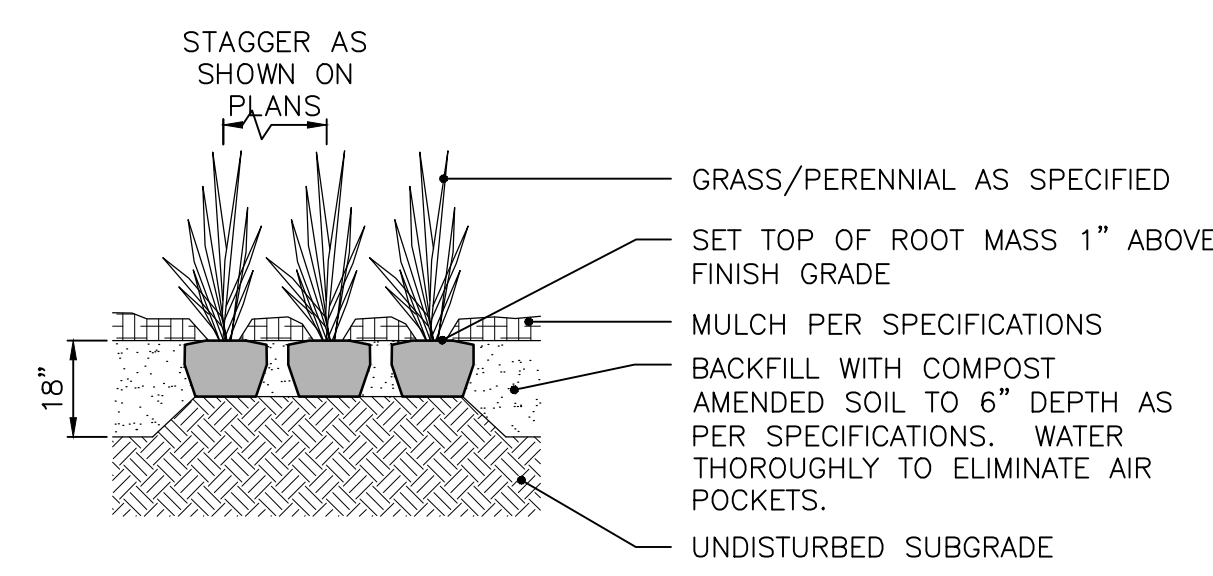


5 SHRUBS AND GROUNDCOVER
NOT TO SCALE

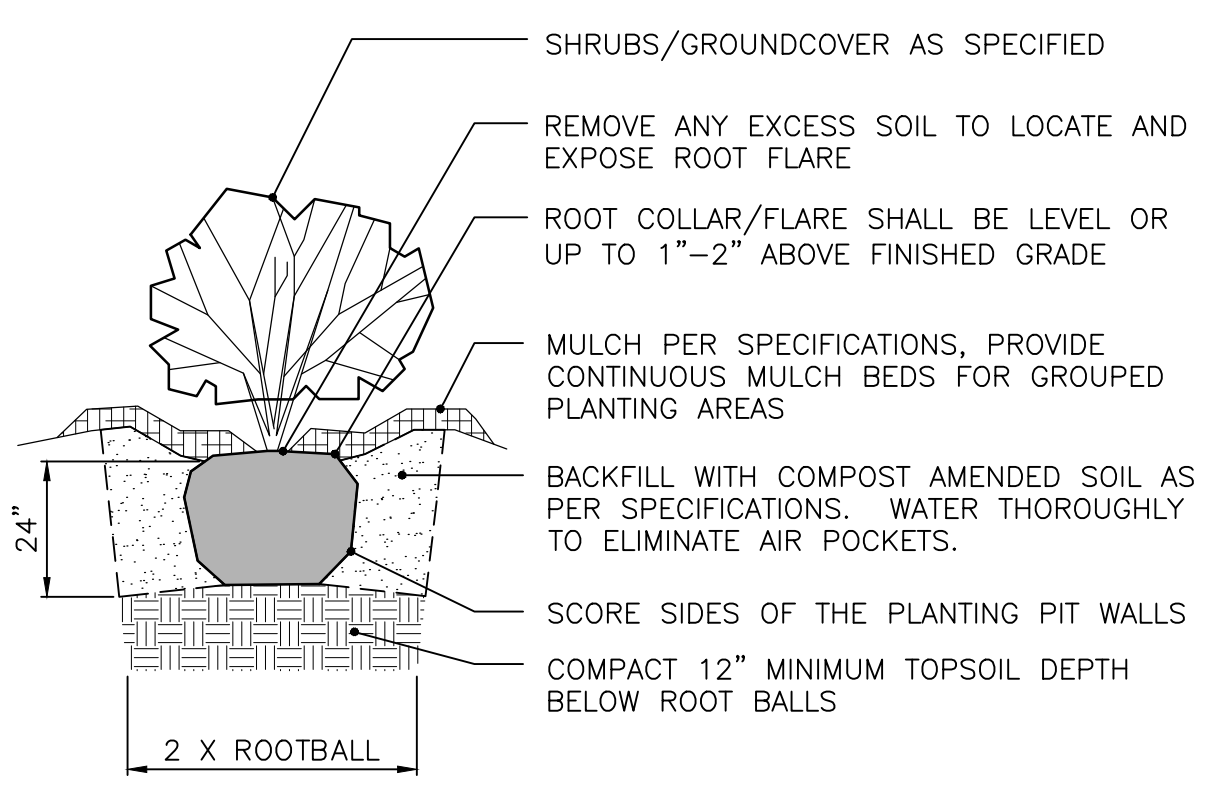

7 PLANTING BED PERIMETER
NOT TO SCALE

NOTE: EDGING SHALL BE INSTALLED AT ALL JUNCTIONS OF PLANTING/ MULCH AREAS FOR CONTAINMENT OF MULCH.


REVISIONS		
DATE	DESCRIPTION	BY

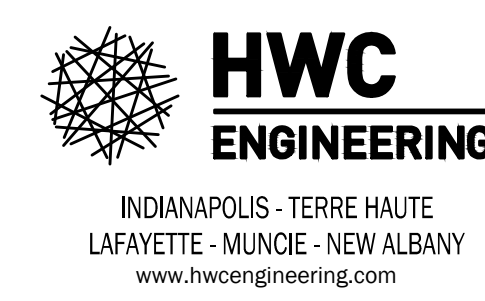


MCCORD POINTE AMENITY AREA
LANDSCAPE DETAILS




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 CHECKED BY: KE
 DATE: JANUARY 17, 2020
 SCALE: AS SHOWN
 SHEET: L1.1
 LANDSCAPE DETAILS

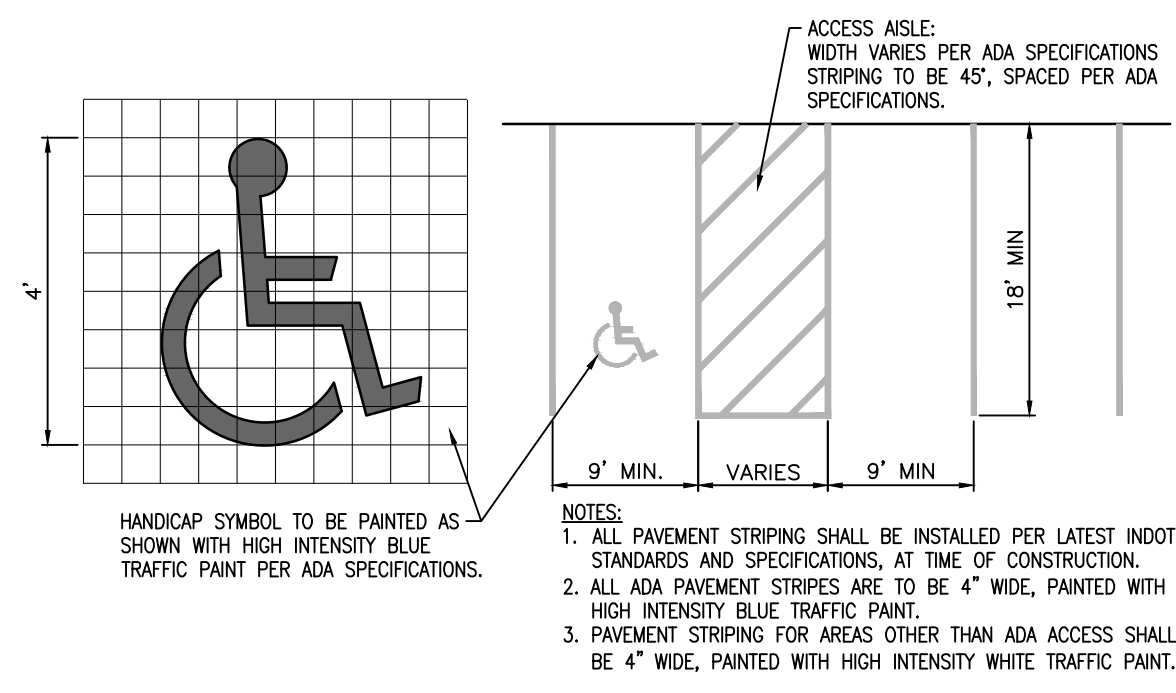


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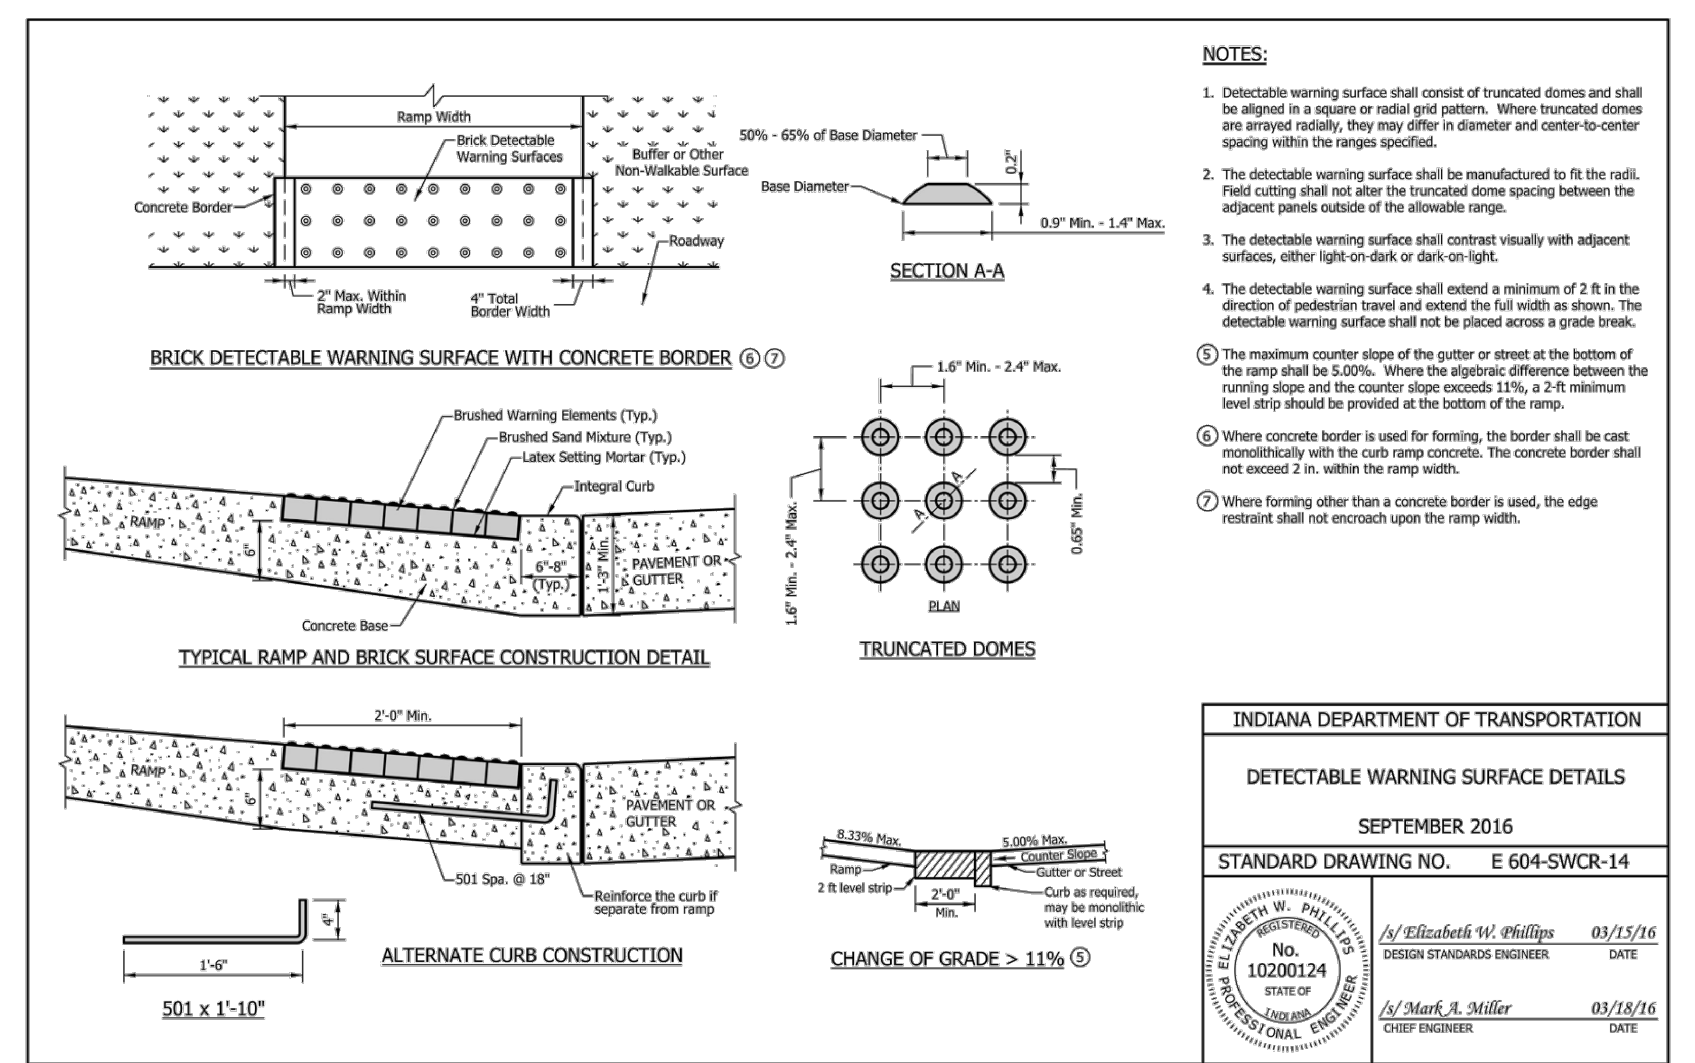
10 HANDICAP PARKING SIGN
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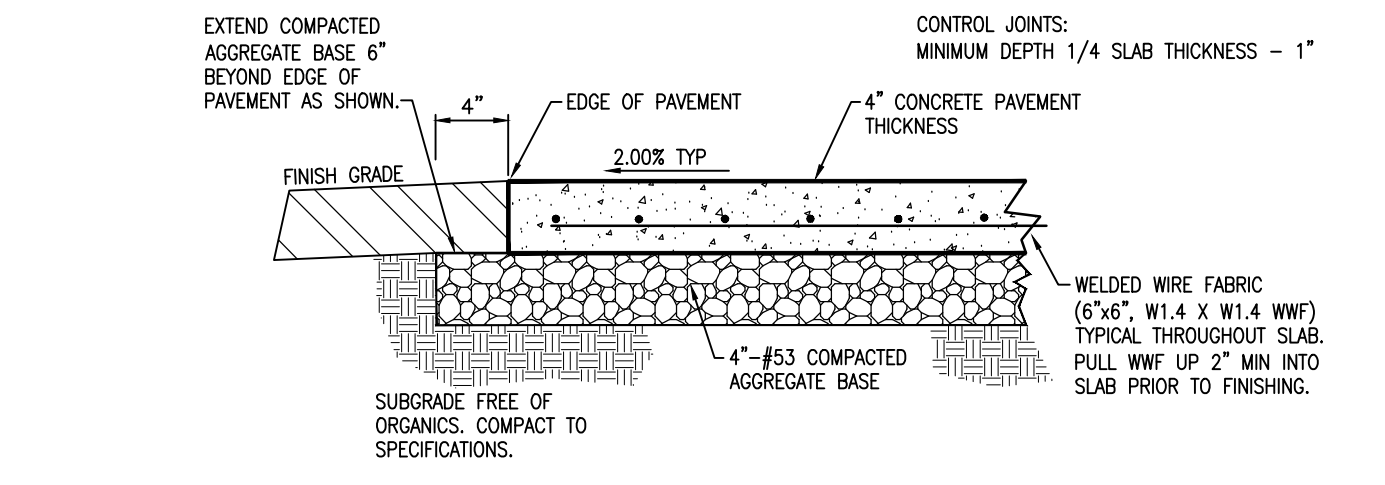
6 ADA RAMP DETAIL
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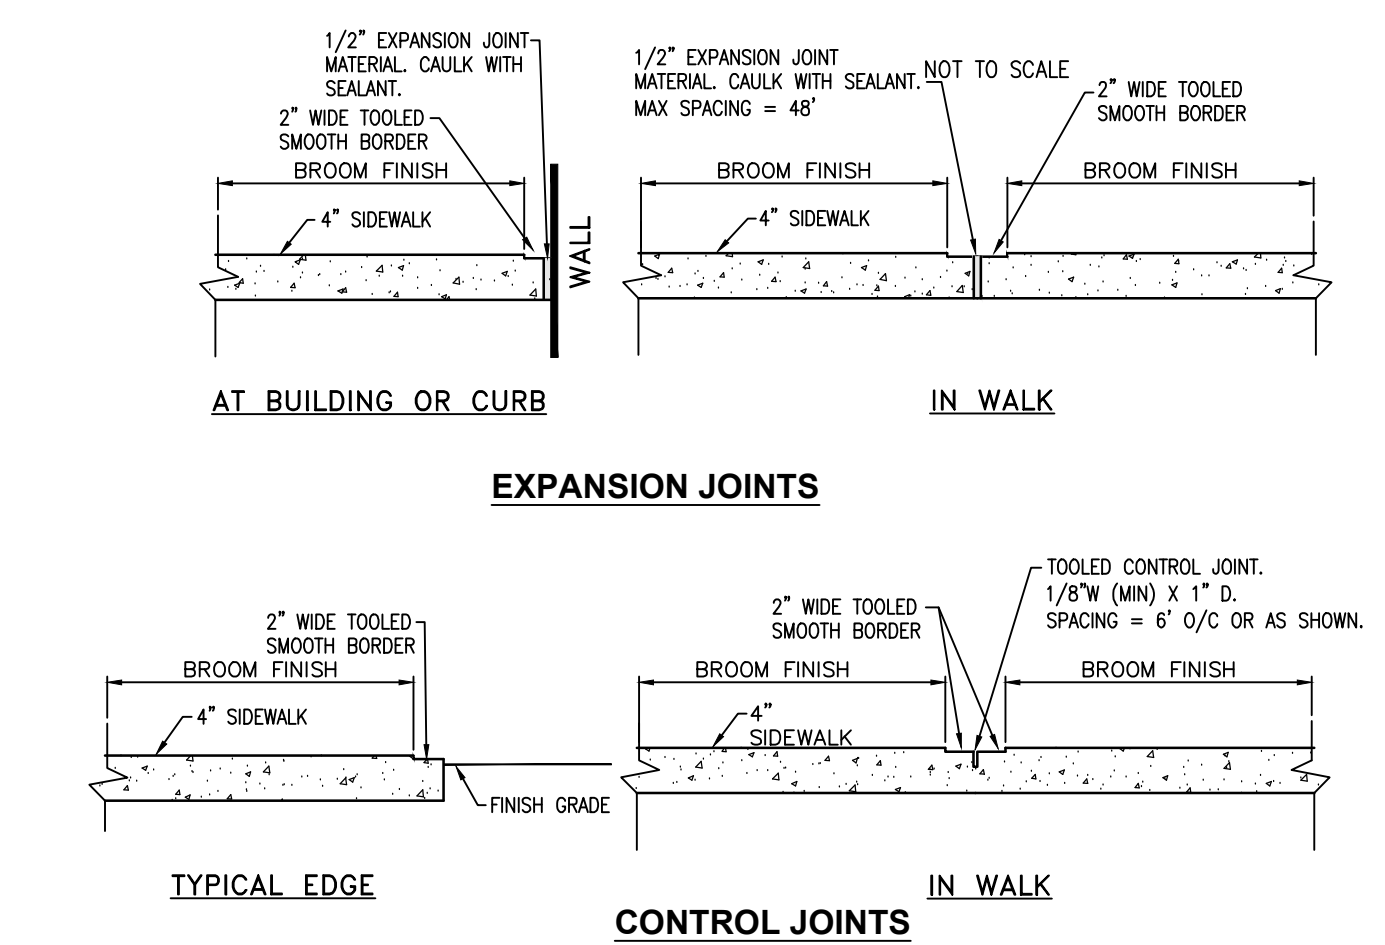
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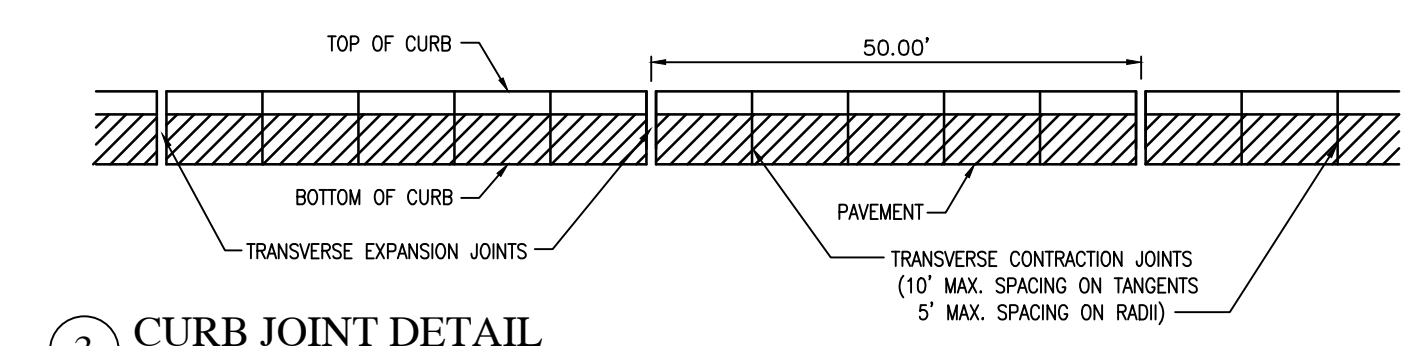
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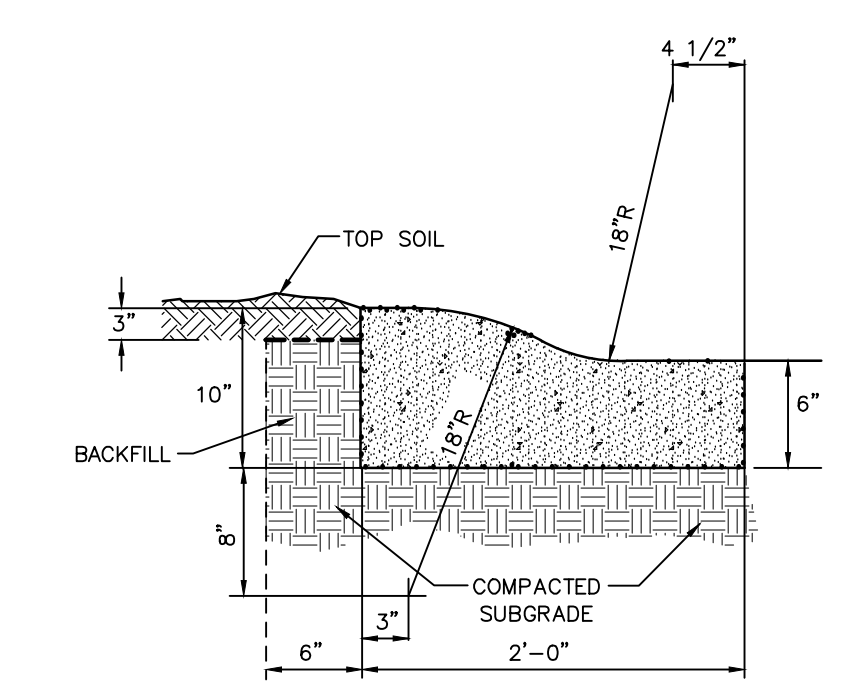
1 CONCRETE SIDEWALK
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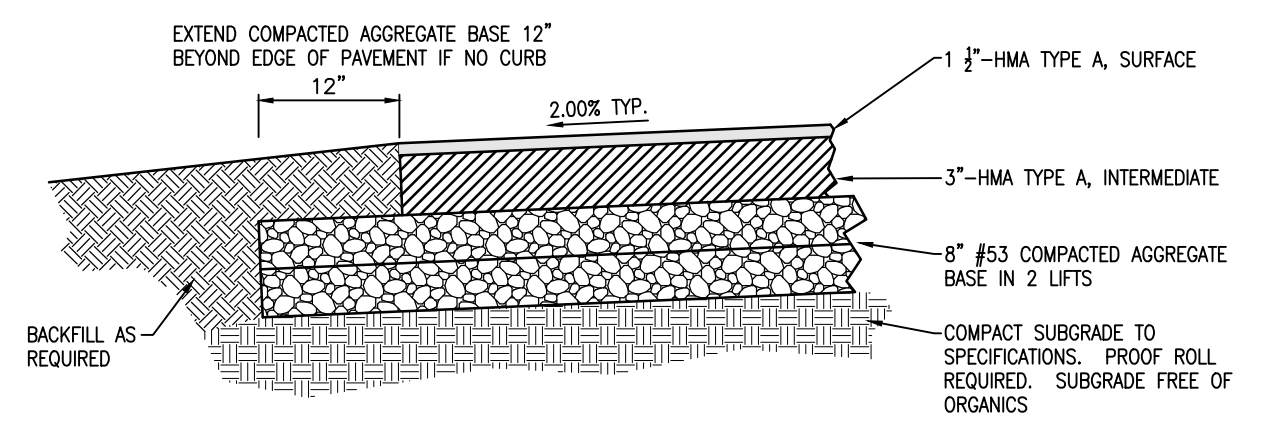
2 CONCRETE SIDEWALK JOINT & FINISHING DETAILS
NOT TO SCALE

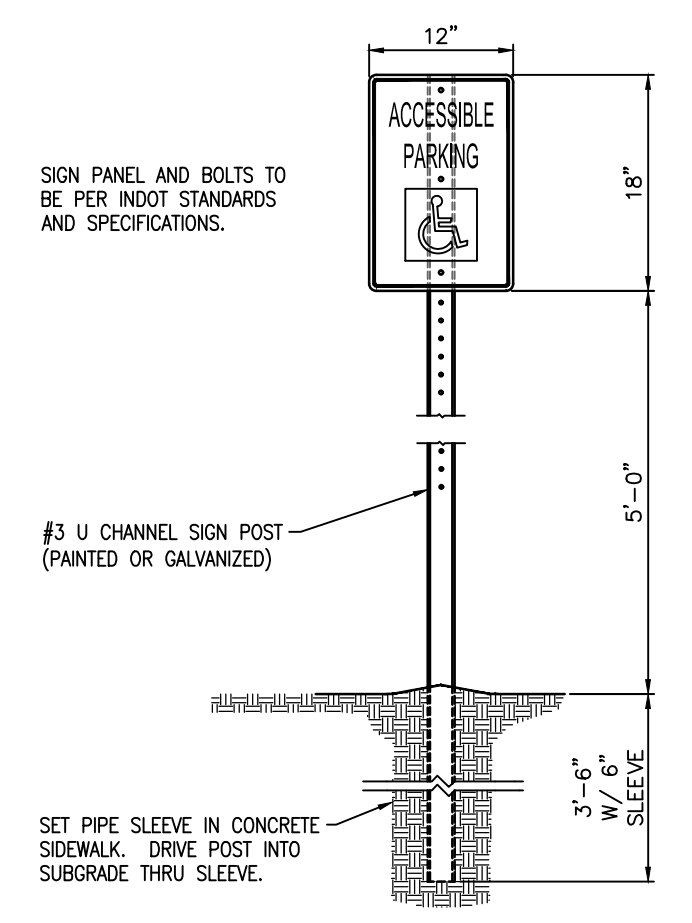

3 CURB JOINT DETAIL
NOT TO SCALE

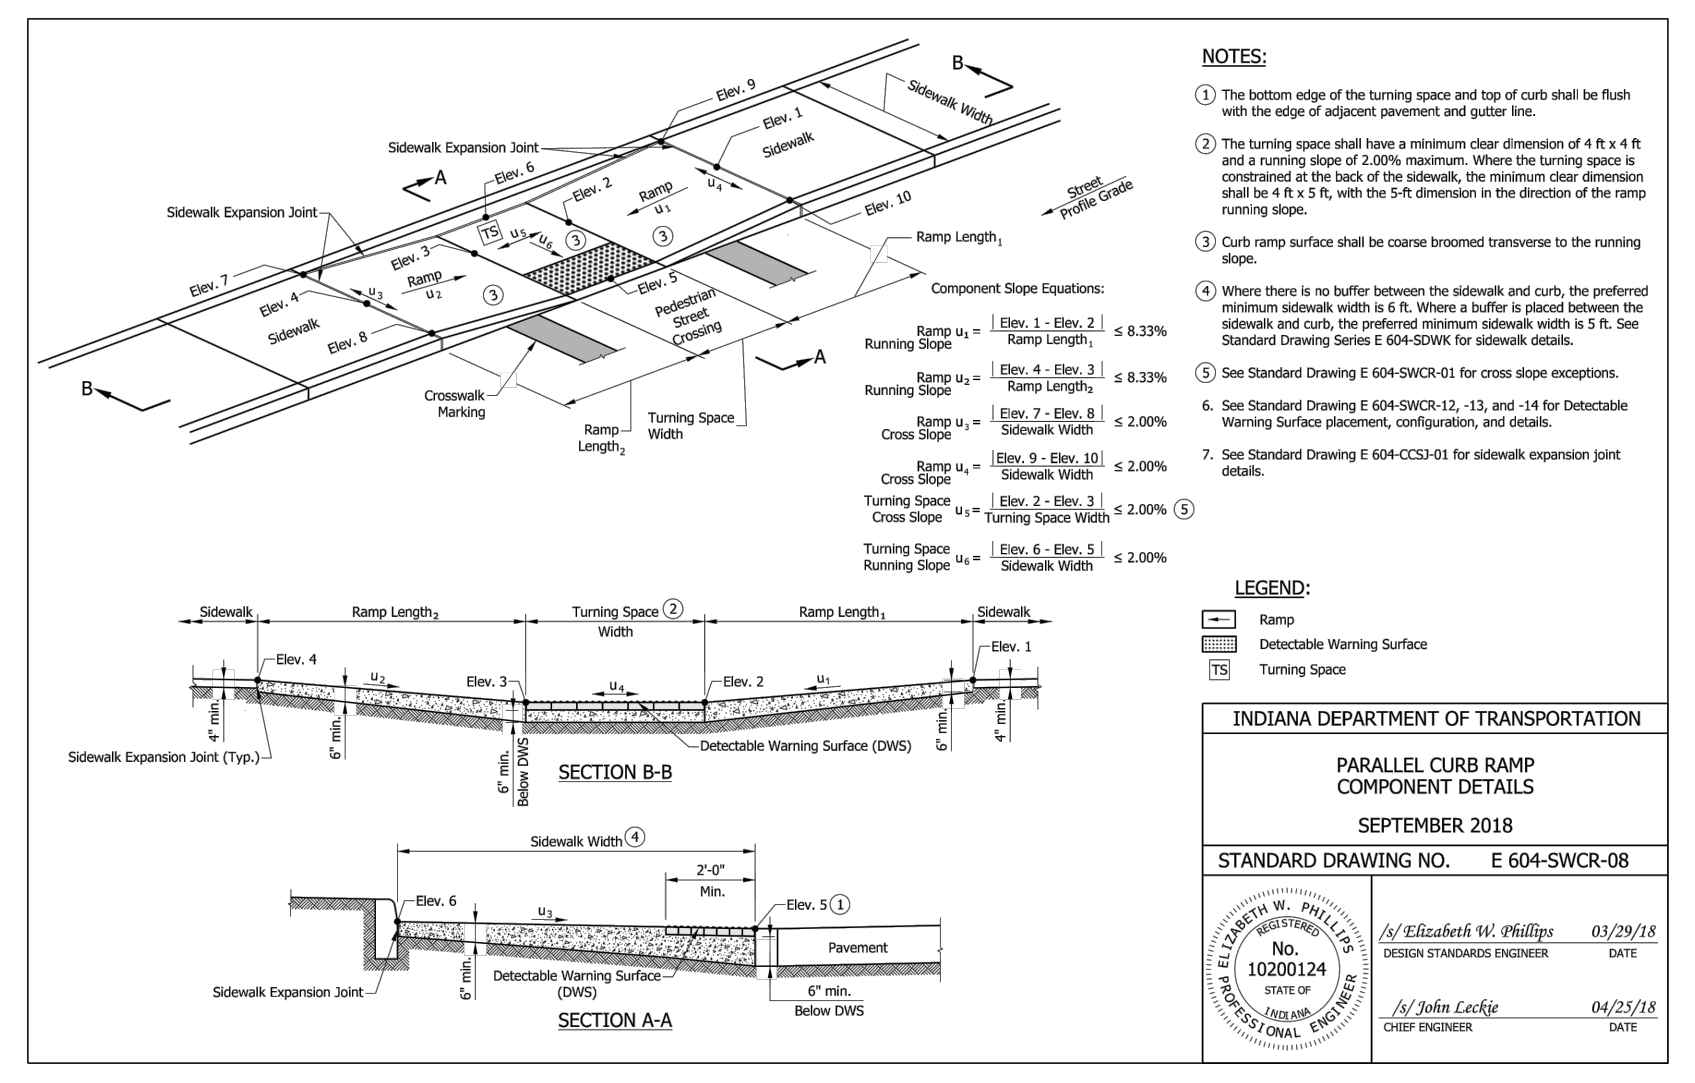

4 2' CONCRETE ROLL CURB (REVERSE SLOPE)
NOT TO SCALE

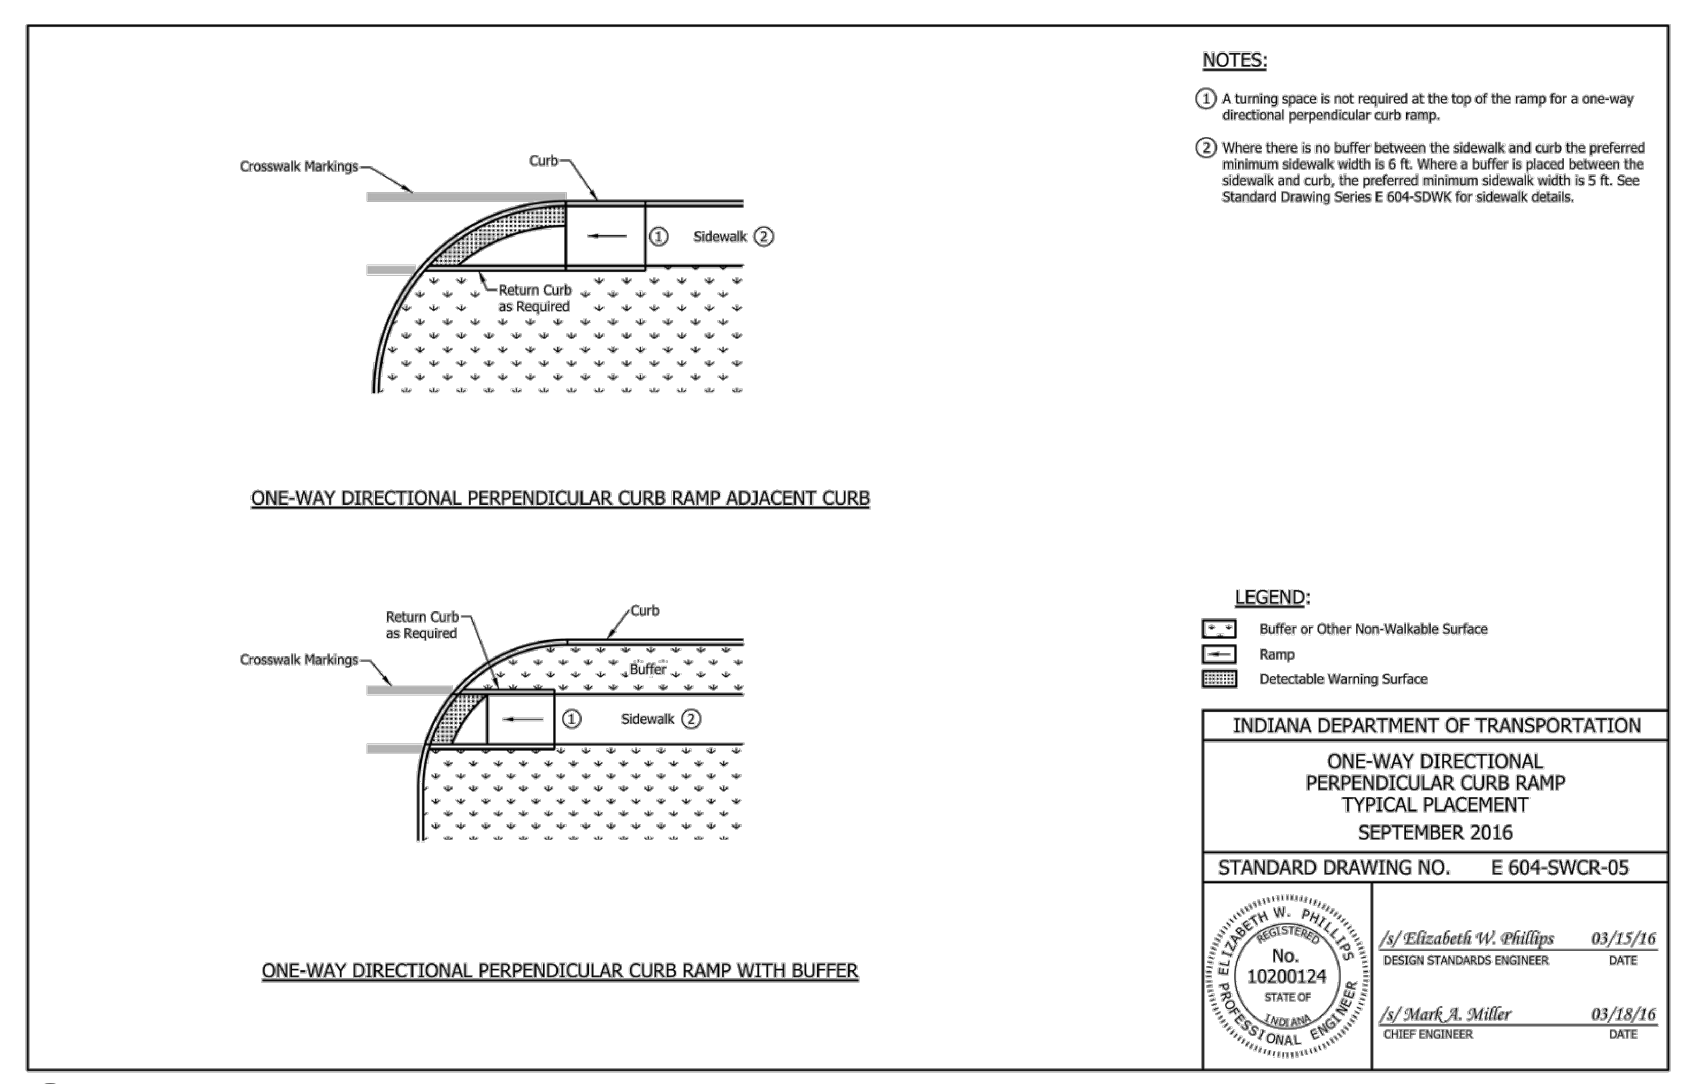

5 ASPHALT PAVEMENT SECTION
NOT TO SCALE

REVISIONS		
DATE	DESCRIPTION	BY

HWC
ENGINEERING
INDIANAPOLIS - TERRE HAUTE
LAFAYETTE - MUNCIE - NEW ALBANY
www.hwengineering.com

MCCORD POINTE
MCCORDSVILLE, INDIANA
CONSTRUCTION DETAILS

PROFESSIONAL ENGINEER
No. 11400758
STATE OF INDIANA
Kirsten K. Seibman

DRAWN BY: TD/GM
CHECKED BY: KE
DATE: JANUARY 17, 2020
SCALE: AS SHOWN
SHEET: C8.5
CONSTRUCTION DETAILS