

TYPICAL TRIM:
6" FASCIA (ALL SIDES)
8" FRIEZE (FRONT ONLY, UNLESS OTHERWISE NOTED)

General Notes:

1. REFER TO SHEET 0N.1 FOR GENERAL NOTES.
2. ROOFING MATERIAL PER SELECTIONS.

Key Notes:

1	(ELEV. A) - CANTILEVER GABLE END TRUSS TO COVER STONE VENEER BELOW - SEE DETAIL D/7.02
2	(ELEV. C) - HOLD BOTTOM OF 8" TRIM 1'-7 1/4" ABOVE TOP OF WINDOWS.
3	--
4	--
5	--

BRICK and STONE LINTEL SCHEDULE

	SPAN	36" HIGH	48" HIGH	LINTEL SIZE	WINDOW ABOVE
*BRICK	Up to 6'-0"	----	----	L3 1/2 x 3 1/2 x 1/4	----
	Up to 8'-3"	----	----	L5 x 3 1/2 x 5/16	----
	Up to 9'-3"	----	----	L6 x 4 x 5/16	L7 x 4 x 3/8
	Up to 16'-3"	L7 x 4 x 3/8	L8 x 4 x 1/2	L8 x 4 x 1/2	**per Design
*STONE	Up to 6'-0"	----	----	L4 x 3 1/2 x 1/4	----
	Up to 8'-3"	----	----	L5 x 3 1/2 x 5/16	----
	Up to 9'-3"	----	L6 x 4 x 3/8	L7 x 4 x 3/8	**per Design
	Up to 16'-3"	----	L8 x 4 x 1/2	**per Design	**per Design

All Lintels: 4" Minimum bearing required each end
* Brick is based on 40psf and Stone is based on 60psf
** Any lintels not described by the above parameters shall be specifically designed.

Space for Architect Seal

RESIDENCE FOR:
CUSTOMER NAME
JOB ADDRESS
SUBDIVISION NAME

Job Number: XXXX-XXXX-XX	Drawing Date: XX.XX.XXXX	Coord Name: COORD_NAME	Coord Phone: COORD_PHONE
House Name:			Drawn By: XXX
ALDEN			Series: SERIES_NM
			Plan No.: PLAN_NM




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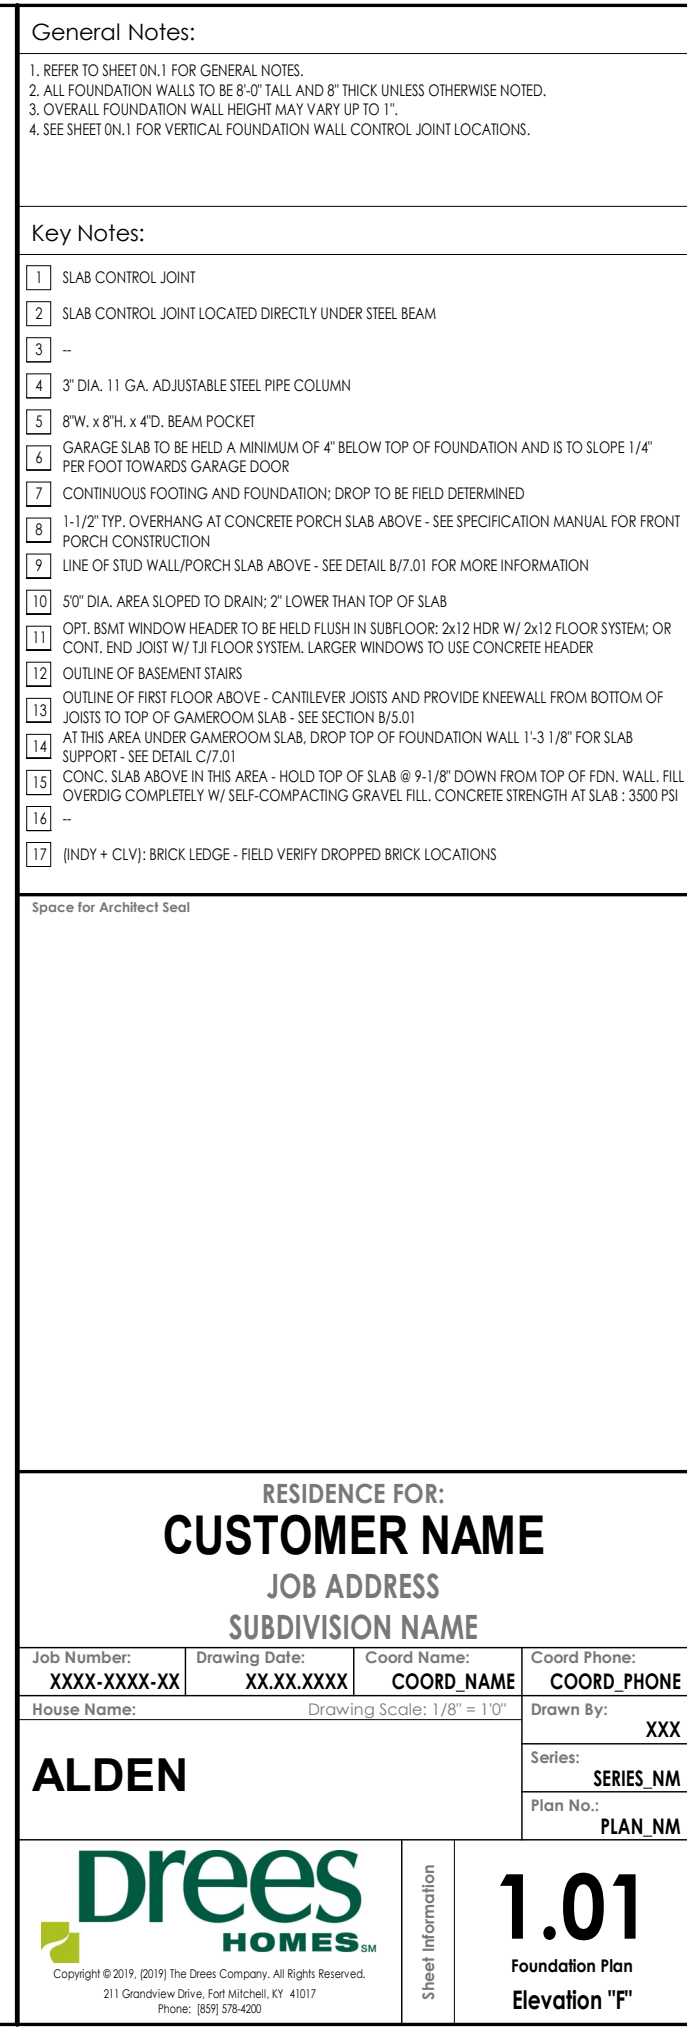
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Phone: (859) 578-4200

Sheet Information

6.01
Front Elevation
Elevation "F"

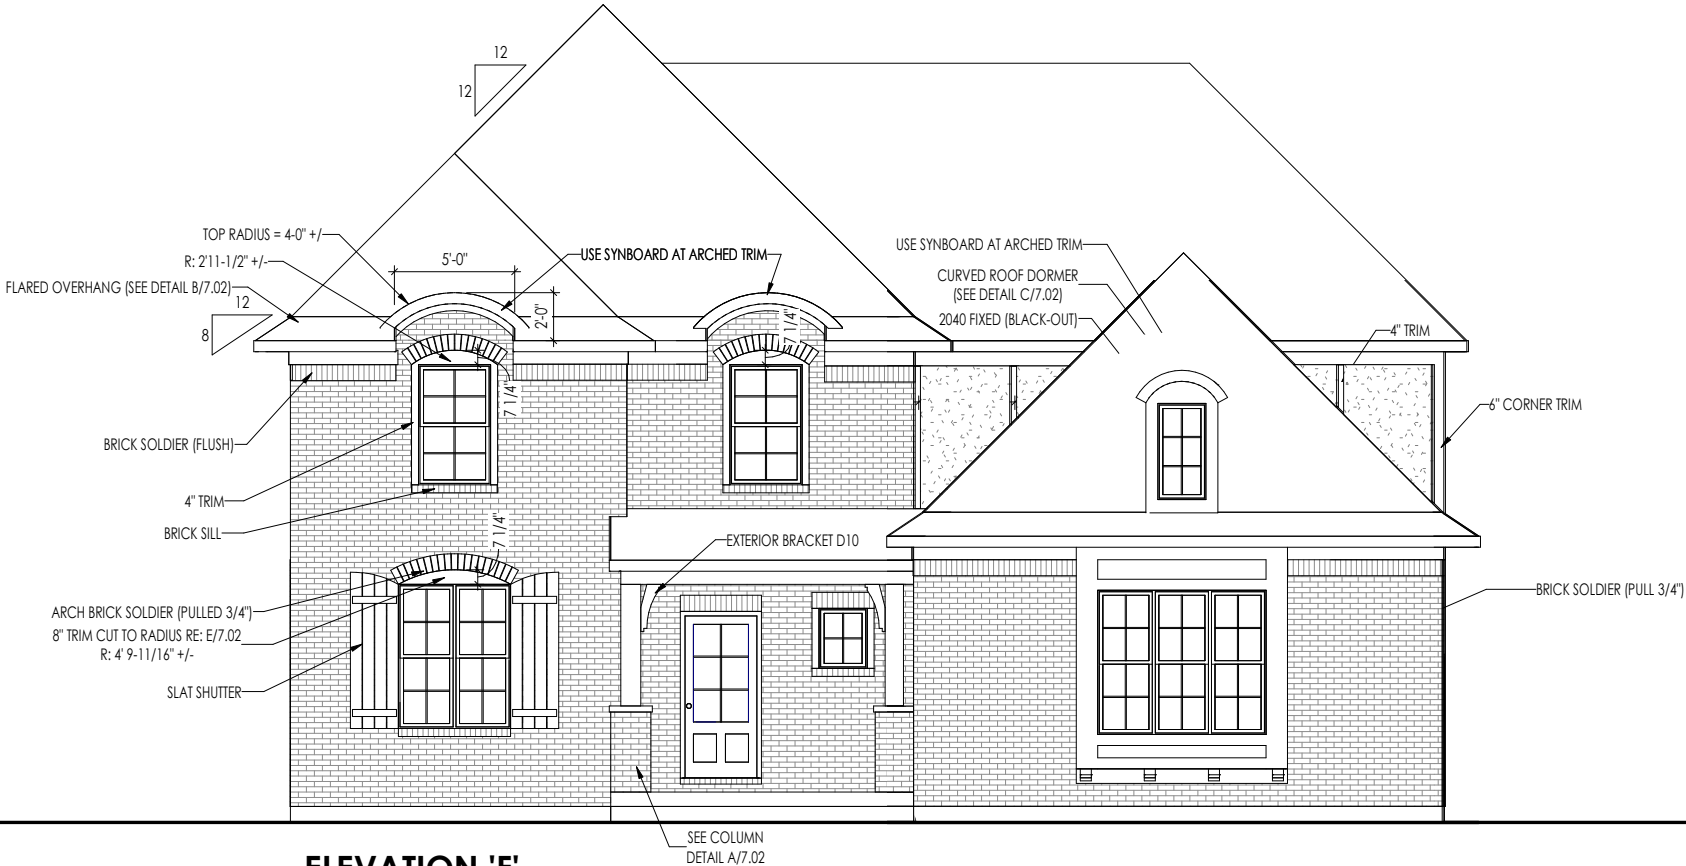

ELEVATION 'F'



General Notes:	
1.	REFER TO SHEET ON.1 FOR GENERAL NOTES.
2.	ALL FOUNDATION WALLS TO BE 8'-0" TALL AND 8" THICK UNLESS OTHERWISE NOTED.
3.	OVERALL FOUNDATION WALL HEIGHT MAY VARY UP TO 1".
4.	SEE SHEET ON.1 FOR VERTICAL FOUNDATION WALL CONTROL JOINT LOCATIONS.
Key Notes:	
1	SLAB CONTROL JOINT
2	SLAB CONTROL JOINT LOCATED DIRECTLY UNDER STEEL BEAM
3	--
4	3" DIA. 11 GA. ADJUSTABLE STEEL PIPE COLUMN
5	8"W. x 8"H. x 4"D. BEAM POCKET
6	GARAGE SLAB TO BE HELD A MINIMUM OF 4" BELOW TOP OF FOUNDATION AND IS TO SLOPE 1/4" PER FOOT TOWARDS GARAGE DOOR
7	CONTINUOUS FOOTING AND FOUNDATION; DROP TO BE FIELD DETERMINED
8	1'-1/2" TYP. OVERHANG AT CONCRETE PORCH SLAB ABOVE - SEE SPECIFICATION MANUAL FOR FRONT PORCH CONSTRUCTION
9	LINE OF STUD WALL/PORCH SLAB ABOVE - SEE DETAIL B/7.01 FOR MORE INFORMATION
10	50" DIA. AREA SLOPED TO DRAIN; 2" LOWER THAN TOP OF SLAB
11	OPT. BSMT WINDOW HEADER TO BE HELD FLUSH IN SUBFLOOR; 2x12 HDR W/ 2x12 FLOOR SYSTEM; OR CONT. END JOIST W/ TJI FLOOR SYSTEM. LARGER WINDOWS TO USE CONCRETE HEADER
12	OUTLINE OF BASEMENT STAIRS
13	OUTLINE OF FIRST FLOOR ABOVE - CANTILEVER JOISTS AND PROVIDE KNEEWALL FROM BOTTOM OF JOISTS TO TOP OF GAMEROOM SLAB - SEE SECTION B/5.01
14	AT THIS AREA UNDER GAMEROOM SLAB, DROP TOP OF FOUNDATION WALL 1'-3 1/8" FOR SLAB SUPPORT - SEE DETAIL C/7.01
15	CONC. SLAB ABOVE IN THIS AREA - HOLD TOP OF SLAB @ 9'-1/8" DOWN FROM TOP OF FDN. WALL; FILL OVERDIG COMPLETELY W/ SELF-COMPACTING GRAVEL FILL. CONCRETE STRENGTH AT SLAB : 3500 PSI
16	--
17	(INDY + CLV) - BRICK LEDGE - FIELD VERIFY DROPPED BRICK LOCATIONS

Space for Architect Seal

RESIDENCE FOR: <h1 style="margin: 0;">CUSTOMER NAME</h1>			
JOB ADDRESS <h2 style="margin: 0;">SUBDIVISION NAME</h2>			
Job Number:	Drawing Date:	Coord Name:	Coord Phone:
XXXX-XXXX-XX	XX.XX.XXXX	COORD_NAME	COORD_PHONE
House Name:		Drawing Scale: 1/8" = 1'0" <div style="font-size: 2em; font-weight: bold; margin-top: 10px;">ALDEN</div>	Drawn By: <div style="font-size: 1.5em; font-weight: bold; margin-top: 10px;">XXX</div>
		Series: <div style="font-size: 1.2em; font-weight: bold; margin-top: 10px;">SERIES_NM</div>	
		Plan No.: <div style="font-size: 1.2em; font-weight: bold; margin-top: 10px;">PLAN_NM</div>	

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- General Notes:
1. REFER TO SHEET 0N.1 FOR GENERAL NOTES.
 2. ALL FIRST FLOOR CEILINGS TO BE 9'-1" ABOVE SUBFLOOR UNLESS OTHERWISE NOTED
 3. FRAME TOP OF ALL WINDOWS AT 1'-0 1/4" BELOW TOP OF PLATE UNLESS OTHERWISE NOTED.
 4. ALL DROPPED, INTERIOR HEADERS (FALSE AND BEARING) ARE DROPPED 1'-0" FROM CEILING UNLESS CALCULATIONS REQUIRE LARGER HEADERS.
 5. REFER TO SELECTION SHEETS FOR FLOORING MATERIAL PRIOR TO CONSTRUCTING STAIRS TO DETERMINE RISER HEIGHTS.
 6. REFER TO SHEET 2.01S FOR STRUCTURAL INFORMATION.

- Key Notes:
- 1 FRAME GARAGE WALL AT 10'-3 1/8" HIGH FROM TOP OF FDN. WALL AT FRONT OF GARAGE.
 - 2 FRAME GARAGE WALL AT 8'-3 1/8" HIGH FROM TOP OF FDN. WALL AT AREAS UNDER 2ND FLOOR (OR AT OPT. CARRIAGE GARAGE, 3-CAR FRONT ENTRY GARAGE BAY, OR OPT. GARAGE STORAGE)
 - 3 RE: DETAIL C & D/7.01 FOR STAIR FRAMING DETAILS
 - 4 REFER TO SELECTIONS - STD. 36"H. WALL SLOPED W/ STRINGER - OR - W/ OPT. RAIL, HOLD TOP OF WALL EVEN WITH STAIR STRINGER
 - 5 FRAME TOP OF OPENING AT 1'-0" DOWN FROM CEILING.
 - 6 HOLD TOP OF OPENING TIGHT TO BOTTOM OF BEAM ABOVE.
 - 7 22'-1/2" x 32" ATTIC ACCESS
 - 8 OPT. BENCH - RE: STANDARD DETAIL F/D2.2 (INDY ONLY)
 - 9 CARPENTER TO DROP ELECTRICAL WIRE THROUGH PORCH CEILING FOR LIGHTS
 - 10 FRAME TOP OF KNEE WALL FLUSH WITH BOTTOM OF WINDOW SILLS W/ 2x4 STUDS @ 16" O.C. HELD 1" FROM FOUNDATION WALL WITH 3-1/2" INSULATION - SEE SECTION B/5.01
 - 11 FRAME KNEE WALL FROM GAMEROOM SLAB TO UNDERSIDE OF CANTD. FAMILY ROOM FLOOR JOISTS W/ 2x4 STUDS @ 16" O.C. HELD 1" FROM FOUNDATION WALL WITH 3-1/2" INSULATION - SEE B/5.01
 - 12 BALLOON FRAMED WALL - SEE SHEET 2.01S.
 - 13 FRAME TOP OF WINDOWS AT 8'-0 3/4" A.F.F. (W/ STD. 2-STORY FAMILY ROOM)
 - 14 FRAME TOP OF WINDOW AT 7'-0 3/4" A.F.F.
 - 15 DROP CEILING AS NEEDED FOR PLUMBING ABOVE
 - 16 --

Space for Architect Seal

RESIDENCE FOR:
CUSTOMER NAME
JOB ADDRESS
SUBDIVISION NAME

Job Number: XXXX-XXXX-XX	Drawing Date: XX.XX.XXXX	Coord Name: COORD_NAME	Coord Phone: COORD_PHONE
House Name:			Drawn By: XXX
ALDEN			Series: SERIES_NM
			Plan No.: PLAN_NM

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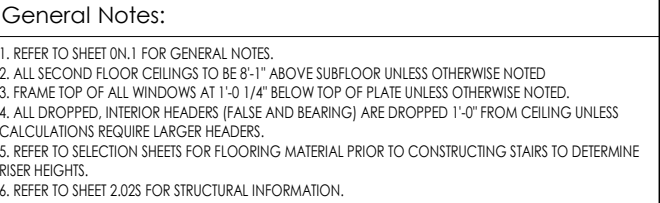
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Sheet Information

2.01F

First Floor Framing Plan
Elevation "F"



1	FRAME TOP OF WINDOW AT 2'-0 1/4" DOWN FROM CEILING
2	22-1/2" x 32" ATTIC ACCESS
3	FALSE HEADER DROPPED 1'-0" DOWN FROM CEILING
4	DO NOT LOCATE TRUSS ABOVE PLUMBING WALL.
5	CHASE FOR [OPT.] FIREPLACE
6	[OPT. GARDEN BATH] - FRAME BOTTOM OF WINDOW IN OWNERS BATH AT 3'-0 3/4" A.F.F.
7	[OPT. SUPER SHOWER] - PROVIDE 4-1/2" H. SHOWER CURB AT MUD PAN
8	REFER TO SELECTIONS - STD. 36"H. WALL SLOPED W/ STRINGER - OR - W/ OPT. RAIL, HOLD TOP OF WALL EVEN WITH STAIR STRINGER
9	BALLOON FRAMED WALL - SEE SHEET 2.025
10	
11	
12	
13	
14	
15	
16	

Job Number: XXXX-XXXX-XX	Drawing Date: XX.XX.XXXX	Coord Name: COORD_NAME	Coord Phone: COORD_PHONE
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House Name:	Drawing Scale: 1/8" = 1'0"	Drawn By:	XXX
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Drawn By: **XXX**

Series: **SERIES_NM**

Plan No.: PLAN_NM



2.02F

Second Floor Framing Plan
Elevation "F"


TRUSS MANUFACTURER TO VERIFY THE FOLLOWING:
(REFER TO SHEETS 2.01F AND/OR 2.02F)

1) DO NOT LOCATE ROOF TRUSSES ABOVE PARALLEL PLUMBING WALLS OR KITCHEN HOOD WALLS

2) DO NOT LOCATE ROOF TRUSSES ABOVE HVAC CHASES (OR LEAVE A MIN. 22-1/2" WIDE CLEAR SPACE OVER CHASE)

HEEL CUT STANDARDS

		OVERHANG	
		1'-0"	2'-0"
ROOF PITCH	4:12	3-3/4"	7-3/4"
	5:12	4-3/4"	9-3/4"
	6:12	5-3/4"	11-3/4"
	7:12	6-3/4"	13-3/4"
	8:12	7-3/4"	N/A
	9:12	8-3/4"	N/A
	10:12	9-3/4"	N/A
	12:12	11-3/4"	N/A
	14:12	13-3/4"	N/A

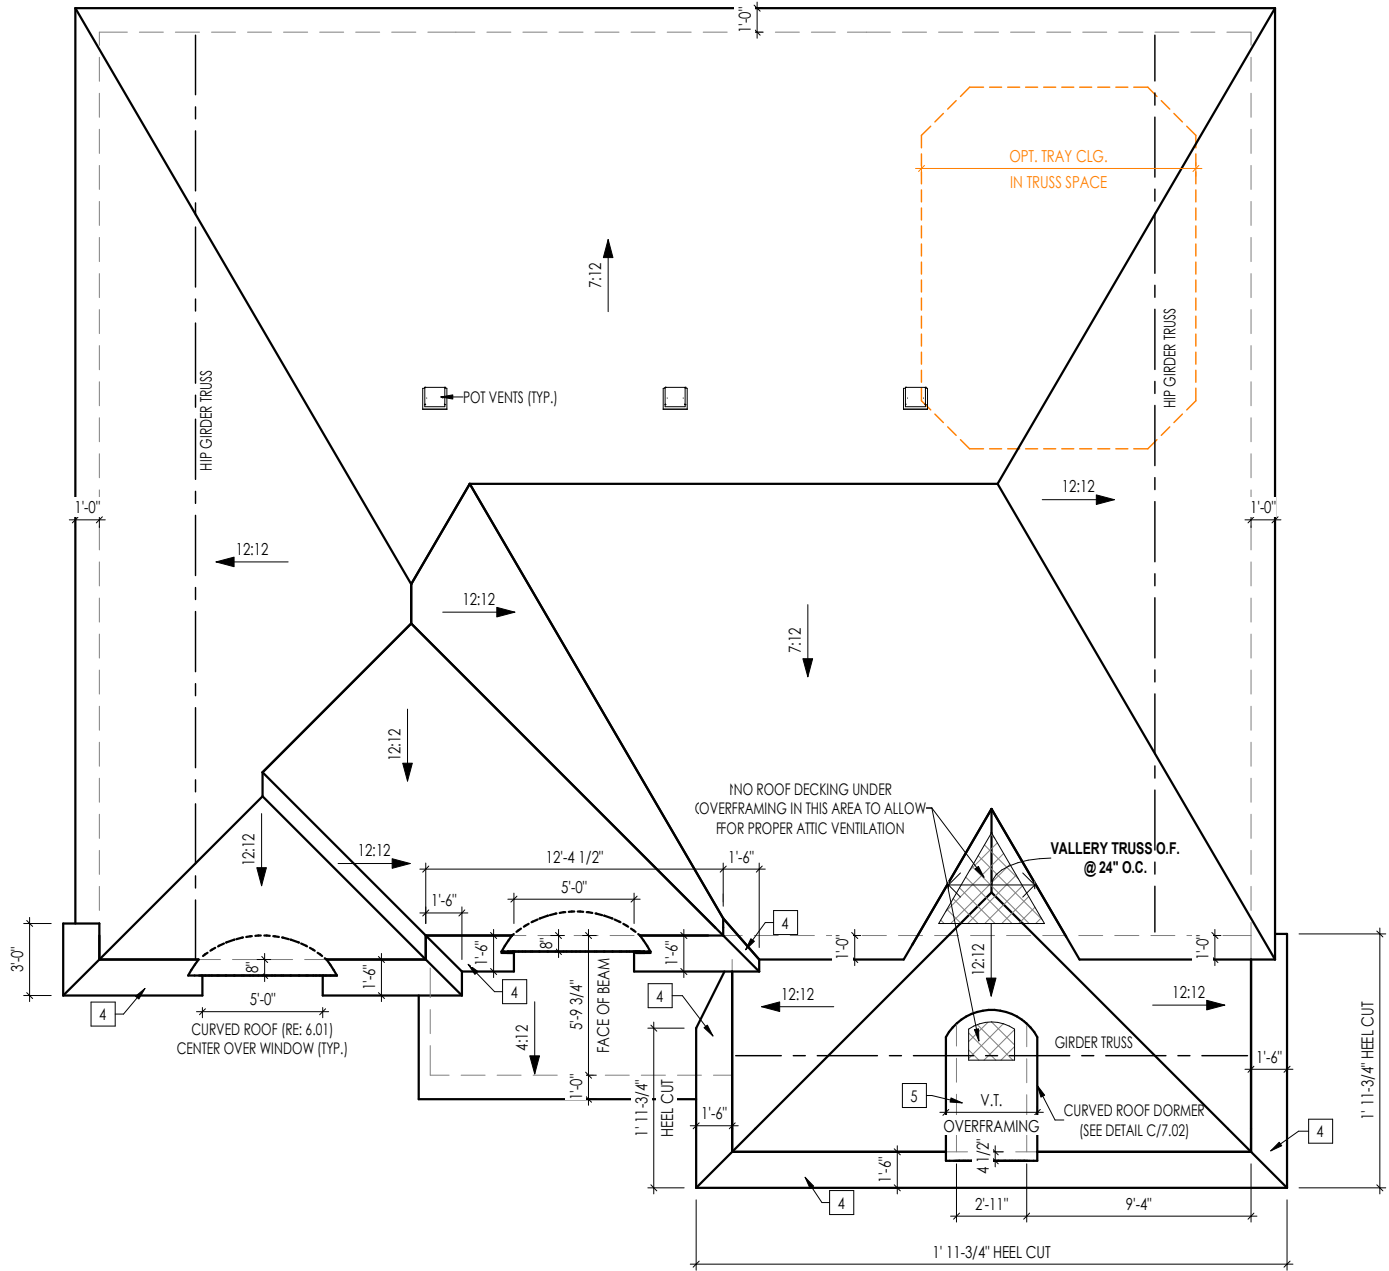

General Notes:

1. REFER TO SHEET 0N.1 FOR GENERAL NOTES.

Key Notes:

- (ELEV. A) - CANTILEVER GABLE END TRUSS TO COVER STONE VENEER BELOW - SEE DETAIL D/7.02
- DO NOT REMOVE ROOF SHEATHING UNDER GABLE TO CONNECT ATTIC SPACES. ROOFS TO BE VENTED SEPARATELY
- SADDLE: MIN. 5:12 PITCH - EXTEND 18" PAST FRAME WALL
- (ELEV. F) - 8:12 PITCH AT FLARED OVERHANG -SEE SHEET 6.01 AND DETAIL B/7.02
- (ELEV. F) - DORMER OVER-FRAMING, PROVIDE 2x_ BLOCKING @ 24" O.C. BETWEEN ROOF TRUSS TOP CHORDS RE: C/7.02

CONNECTION SPECIFICATIONS (TYP. U.N.O.)

NOTE: 10d NAIL = 3" x 0.131" GUN NAIL	
JOIST TO SOLE PLATE	(3)10d TOENAILS
SOLE PLATE TO JOIST/BLK'G.	10d NAILS @ 6" o.c.
STUD TO SOLE PLATE	(3)10d TOENAILS
TOP OR SOLE PLATE TO STUD	(3)10d NAILS
RIM TO TOP PLATE	10d TOENAILS @ 6" o.c.
BLK'G. BTWN. JOISTS TO TOP PL.	(3)10d TOENAILS
RAFTER/TRUSS TO TOP PLATE	(3)10d TOENAILS + (1) SIMPSON H2.5A
GAB. END TRUSS TO DBL. TOP PL.	10d TOENAILS @ 8" o.c.
R.T. w/ HEEL HT. 9 1/4" TO 12"	2x10 BLK EVERY 3RD BAY FASTENED TO DBL. TOP PLATE w/ 10d TOENAILS @ 6" O.C.
R.T. w/ HEEL HT. 12" TO 16"	2x12 BLK EVERY 3RD BAY FASTENED TO DBL. TOP PLATE w/ 10d TOENAILS @ 6" O.C.
R.T. w/ HEEL HT. UP TO 24"	LAP WALL SHTG. w/ DBL. TOP PL. & INSTALL ON TRUSS VERT. - FASTEN w/ 8d NAILS @ 6" O.C.
R.T. w/ HEEL HT. 24" TO 48"	LAP WALL SHTG. w/ DBL. TOP PL. & INSTALL ON TRUSS VERT. - FASTEN w/ 8d NAILS @ 6" O.C. PROVIDE 2x BLK @ EA. BAY AT TOP OF HEEL
DOUBLE STUD	10d NAILS @ 24" o.c.
DOUBLE TOP PLATE	10d NAILS @ 24" o.c.
DOUBLE TOP PLATE LAP SPICE	(10)10d NAILS IN LAPPED AREA
TOP PLATE LAP @ CORNERS & INTERSECTING WALLS	(2)10d NAILS
WALL TO FOUNDATION	WALL SHTG. LAP w/ SILL PL. & FASTENED PER SHEAR WALL FASTENING SPEC.

Space for Architect Seal

RESIDENCE FOR:
CUSTOMER NAME
JOB ADDRESS
SUBDIVISION NAME

Job Number: XXXX-XXXX-XX	Drawing Date: XX.XX.XXXX	Coord Name: COORD_NAME	Coord Phone: COORD_PHONE
House Name:			Drawing Scale: 1/8" = 1'0"
ALDEN			Drawn By: XXX
			Series: SERIES_NM
			Plan No.: PLAN_NM



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Sheet Information

2.04
Roof Plan
Elevation "F"

TYPICAL TRIM:
6" FASCIA (ALL SIDES)
8" FRIEZE (FRONT ONLY, UNLESS OTHERWISE NOTED)

General Notes:

1. REFER TO SHEET 0N.1 FOR GENERAL NOTES.
2. ROOFING MATERIAL PER SELECTIONS.

Key Notes:

1	(ELEV. A) - CANTILEVER GABLE END TRUSS TO COVER STONE VENEER BELOW - SEE DETAIL D/7.02
2	(ELEV. C) - HOLD BOTTOM OF 8" TRIM 1'-7 1/4" ABOVE TOP OF WINDOWS.
3	--
4	--
5	--

BRICK and STONE LINTEL SCHEDULE

	SPAN	36" HIGH	48" HIGH	LINTEL SIZE	WINDOW ABOVE
*BRICK	Up to 6'-0"	----	----	L3 1/2 x 3 1/2 x 1/4	----
	Up to 8'-3"	----	----	L5 x 3 1/2 x 5/16	----
	Up to 9'-3"	----	----	L6 x 4 x 5/16	L7 x 4 x 3/8
	Up to 16'-3"	L7 x 4 x 3/8	L8 x 4 x 1/2	L8 x 4 x 1/2	**per Design
*STONE	Up to 6'-0"	----	----	L4 x 3 1/2 x 1/4	----
	Up to 8'-3"	----	----	L5 x 3 1/2 x 5/16	----
	Up to 9'-3"	----	L6 x 4 x 3/8	L7 x 4 x 3/8	**per Design
	Up to 16'-3"	----	L8 x 4 x 1/2	**per Design	**per Design

All Lintels: 4" Minimum bearing required each end
* Brick is based on 40psf and Stone is based on 60psf
** Any lintels not described by the above parameters shall be specifically designed.

Space for Architect Seal

RESIDENCE FOR:
CUSTOMER NAME
JOB ADDRESS
SUBDIVISION NAME


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House Name:			Drawn By: XXX
ALDEN			Series: SERIES_NM
			Plan No.: PLAN_NM




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Sheet Information

6.01
Front Elevation
Elevation "F"



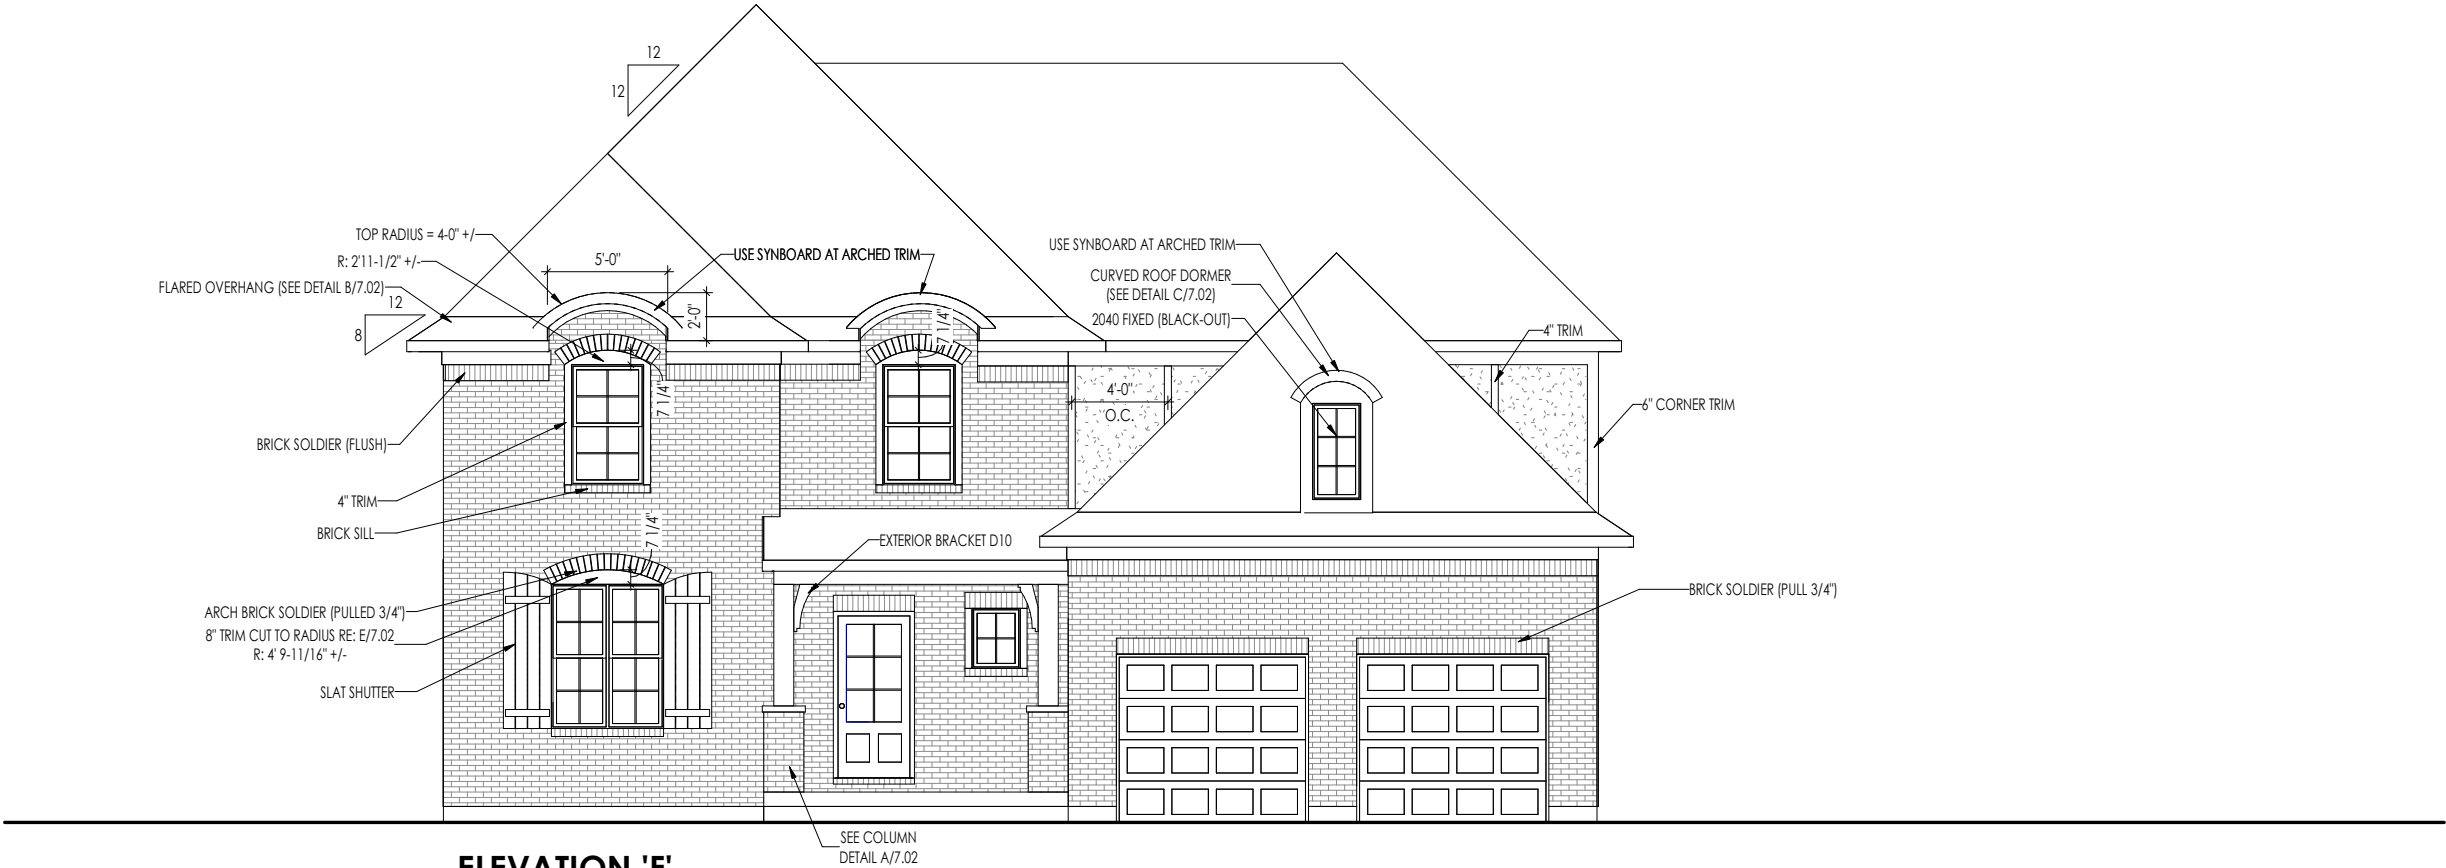

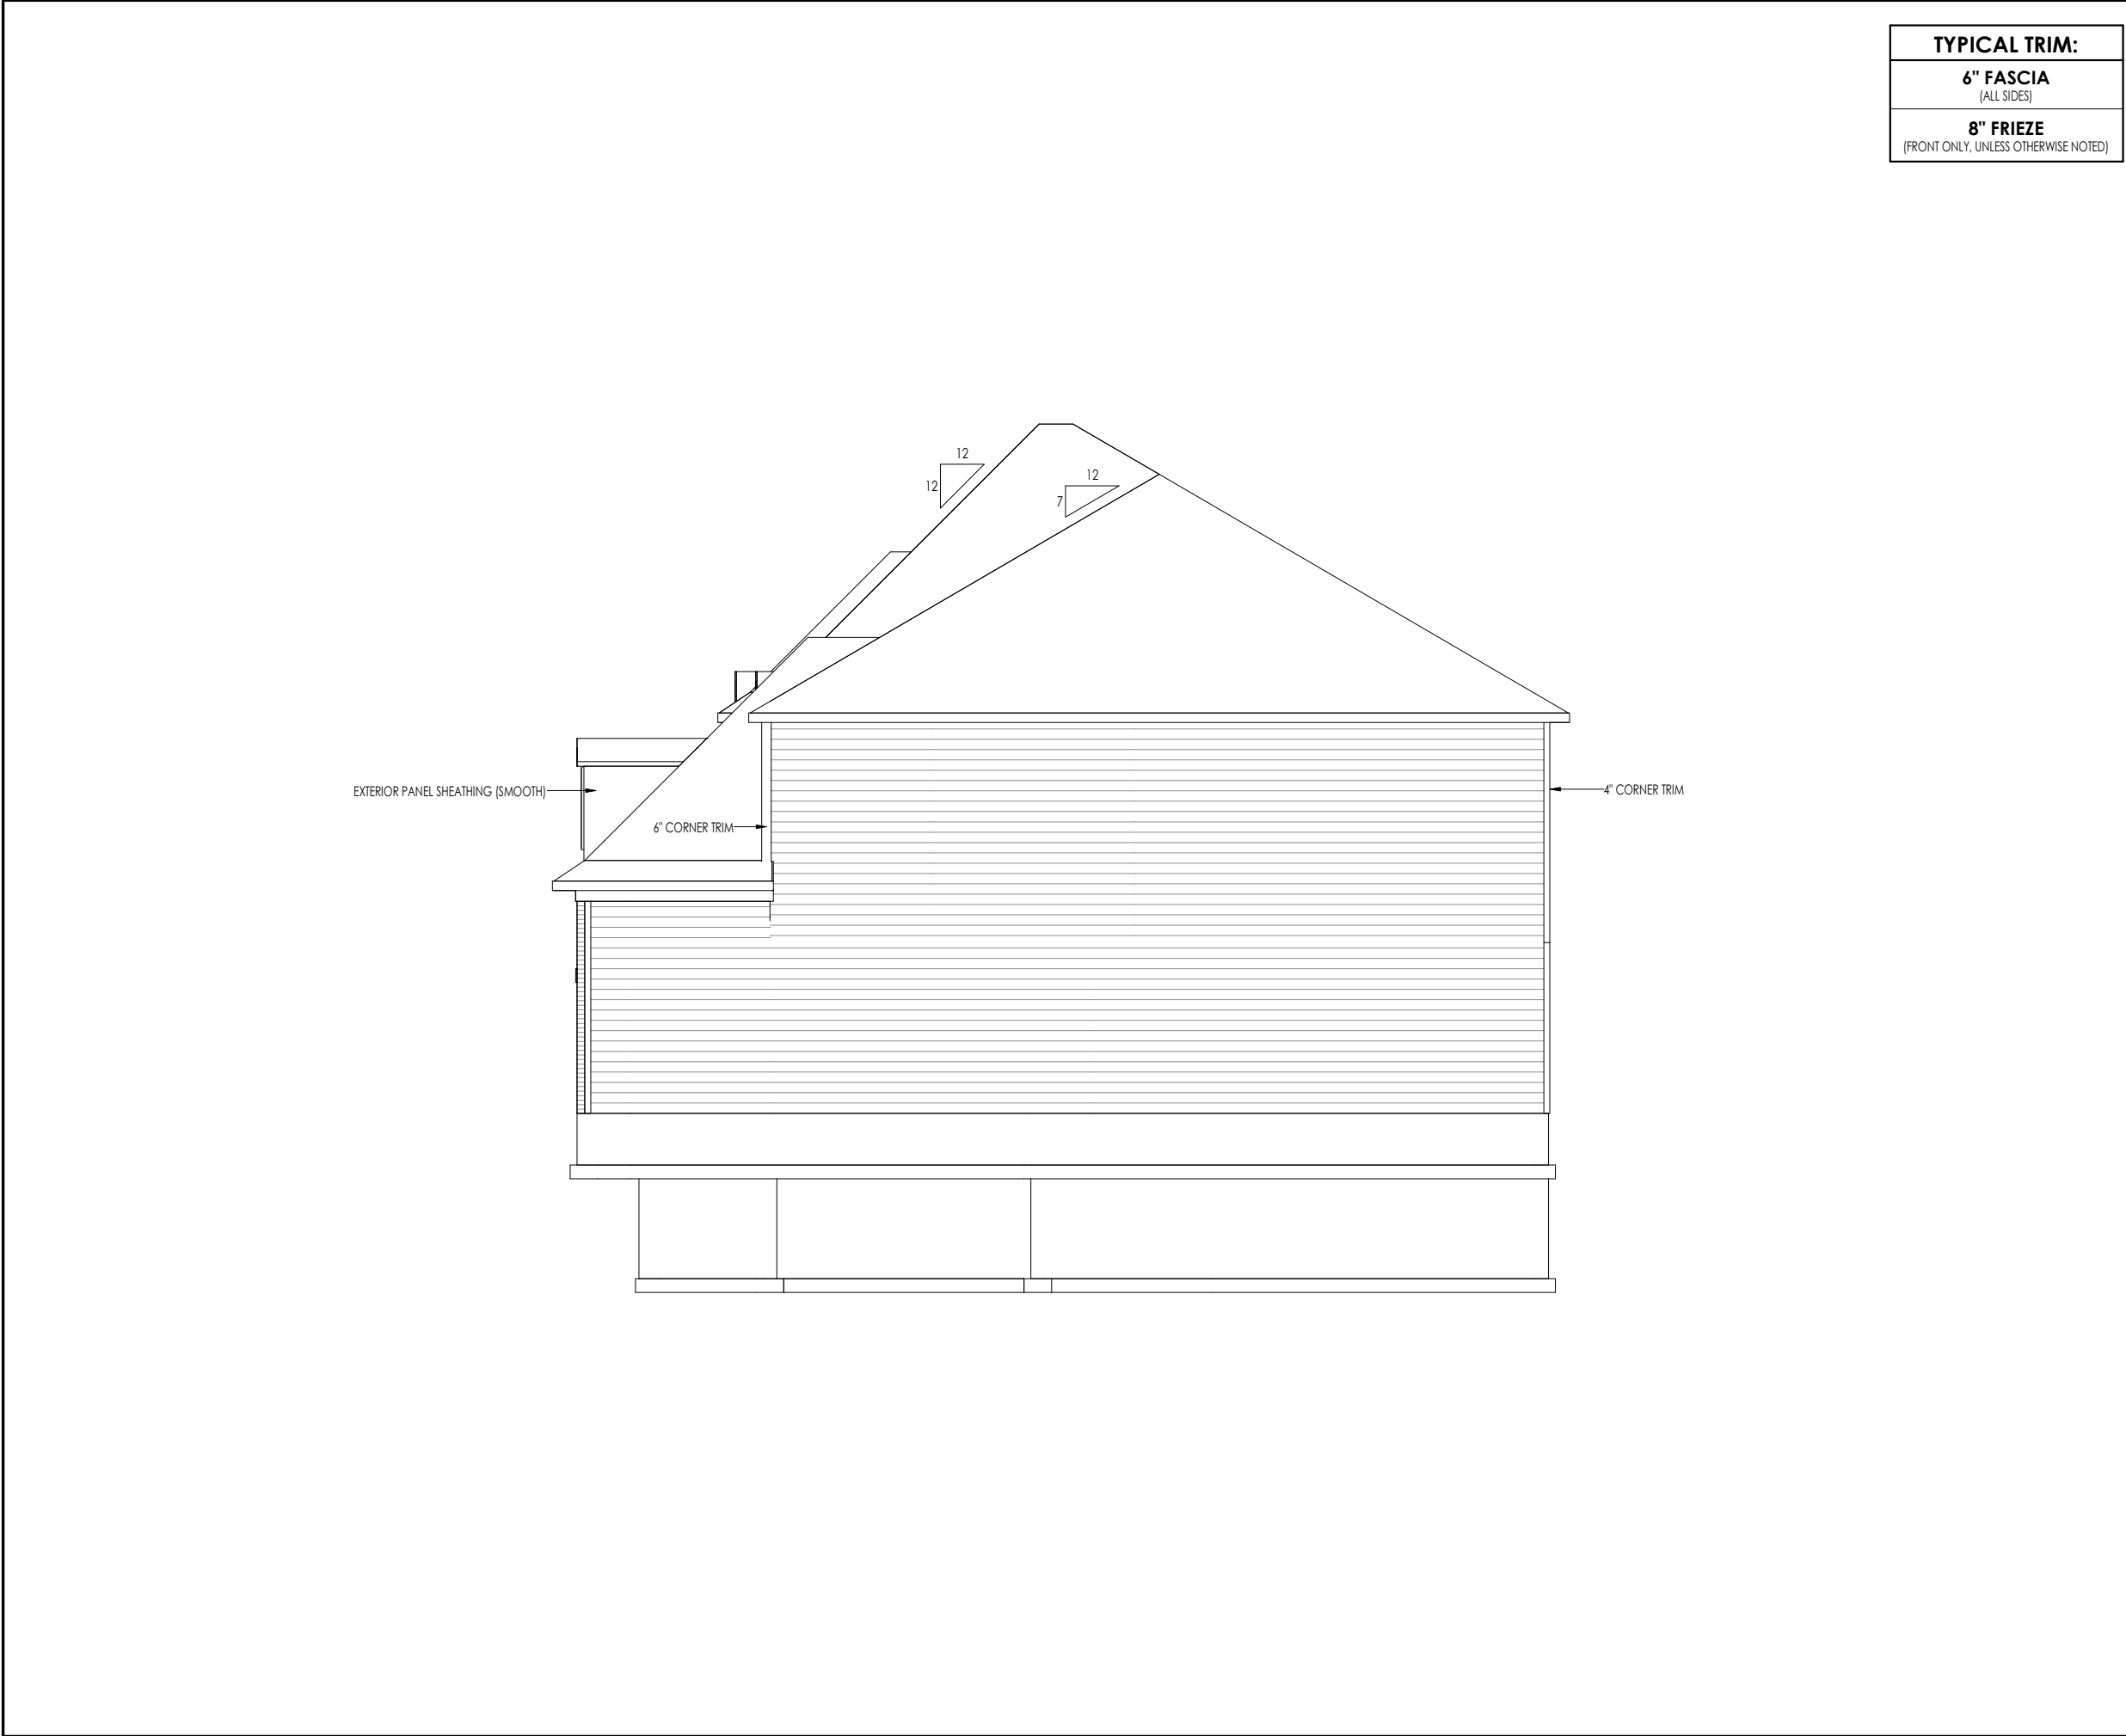TYPICAL TRIM:
6" FASCIA (ALL SIDES)
8" FRIEZE (FRONT ONLY, UNLESS OTHERWISE NOTED)

General Notes:

1. REFER TO SHEET 0N.1 FOR GENERAL NOTES.

2. ROOFING MATERIAL PER SELECTIONS.

3. REFER TO LINTEL SCHEDULE AS NEEDED ON SHEET 6.01.

Key Notes:

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Space for Architect Seal

RESIDENCE FOR:

CUSTOMER NAME

JOB ADDRESS

SUBDIVISION NAME

Job Number:	Drawing Date:	Coord Name:	Coord Phone:
XXXX-XXXX-XX	XX.XX.XXXX	COORD_NAME	COORD_PHONE
House Name:			Drawn By:
ALDEN			XXX
			Series:
			SERIES_NM
Plan No.:			PLAN_NM

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Sheet Information

6.02

Garage Side Elevation

Elevation "F"




TYPICAL TRIM:
6" FASCIA (ALL SIDES)
8" FRIEZE (FRONT ONLY, UNLESS OTHERWISE NOTED)

General Notes:	
1. REFER TO SHEET 0N.1 FOR GENERAL NOTES. 2. ROOFING MATERIAL PER SELECTIONS. 3. REFER TO LINTEL SCHEDULE AS NEEDED ON SHEET 6.01.	
Key Notes:	
1	-
2	-
3	-
4	-
5	-

Space for Architect Seal

RESIDENCE FOR: CUSTOMER NAME JOB ADDRESS SUBDIVISION NAME			
Job Number: XXXX-XXXX-XX	Drawing Date: XX.XX.XXXX	Coord Name: COORD_NAME	Coord Phone: COORD_PHONE
House Name: ALDEN		Drawing Scale: 1/8" = 1'0"	
		Drawn By: XXX	
		Series: SERIES_NM	
		Plan No.: PLAN_NM	

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TYPICAL TRIM:
6" FASCIA (ALL SIDES)
8" FRIEZE (FRONT ONLY, UNLESS OTHERWISE NOTED)

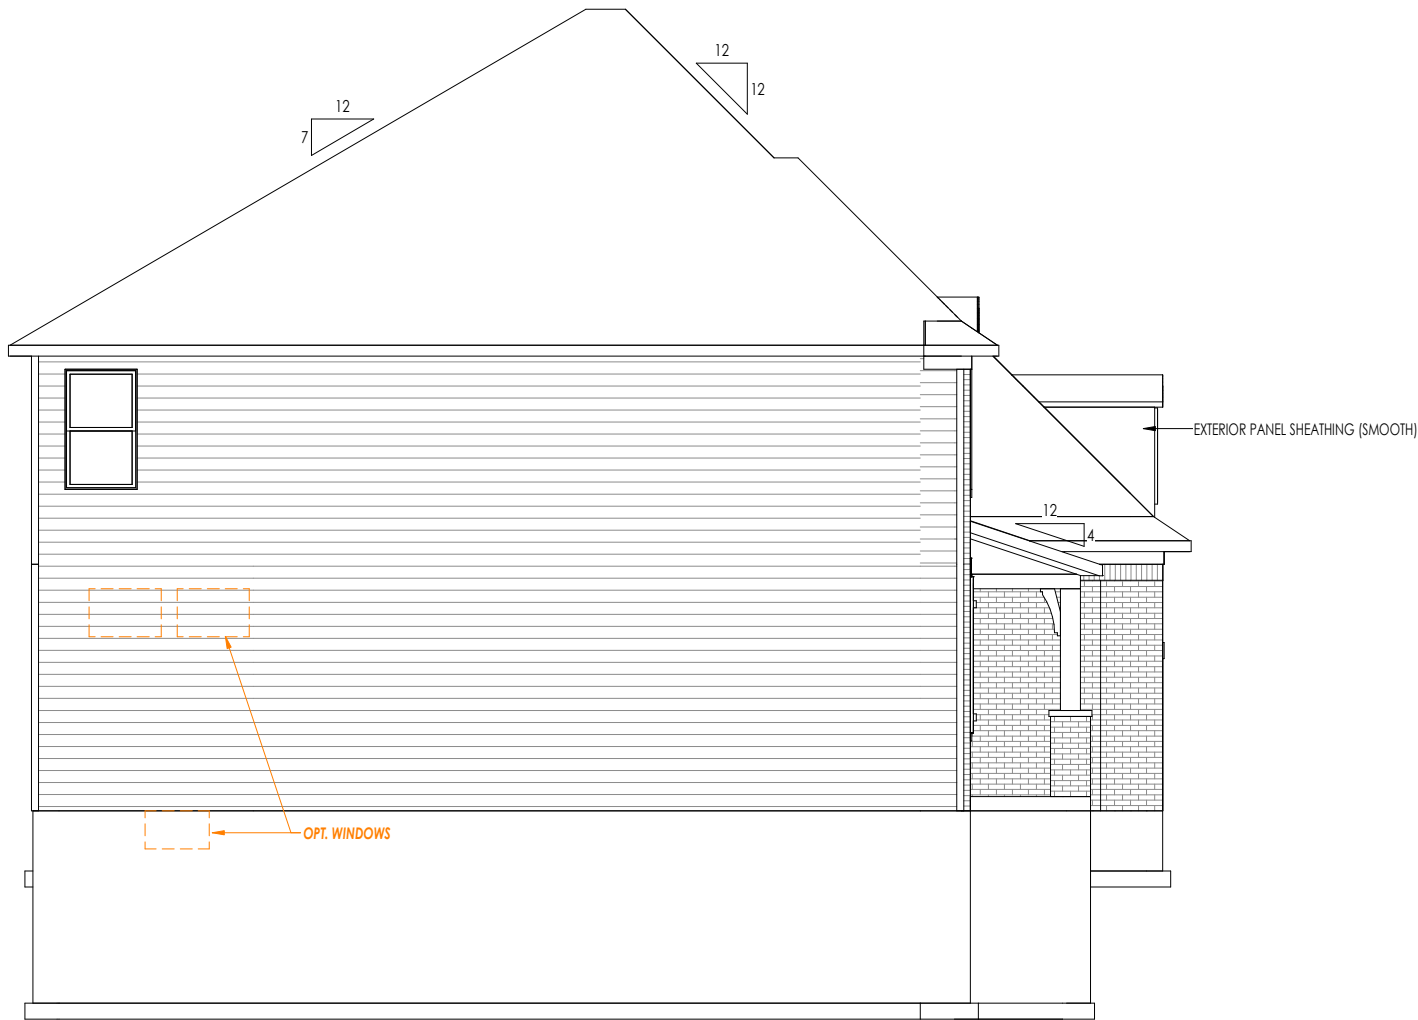General Notes:

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2. ROOFING MATERIAL PER SELECTIONS.
3. REFER TO LINTEL SCHEDULE AS NEEDED ON SHEET 6.01.

Key Notes:

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Space for Architect Seal

RESIDENCE FOR:

CUSTOMER NAME

JOB ADDRESS

SUBDIVISION NAME

Job Number:	Drawing Date:	Coord Name:	Coord Phone:
XXXX-XXXX-XX	XX.XX.XXXX	COORD_NAME	COORD_PHONE
House Name:		Drawing Scale: 1/8" = 1'0"	
ALDEN		Drawn By:	XXX
		Series:	SERIES_NM
		Plan No.:	PLAN_NM

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Sheet Information

6.04

Side Elevation

Elevation "F"