KENNSINGTON WAY MCCORDSVILLE, IN 46055







PROJECT TEAM

DEVELOPER:

THE RIDGE GROUP

TYLER BOWERS 3225 S. HOYT AVENUE MUNCIE, IN 47302

ARCHITECT:



STRUCTURAL ENGINEER:

CONSULTING JPS CONSULTING ENGINEERS 9365 COUNSELORS ROW INDIANAPOLIS, IN 46240

jburke@jpsconsultingengineers.com

BILLY@R3BARCHITECTURE.COM

PHONE: 317-503-0447

MECH., PLUMBING & ELEC. ENGINEER:

CONTACT: DAVID EVERHART

CIVIL ENGINEER:

STANTEC

5778 WEST 74TH STREET INDIANAPOLIS, IN 46278-1754 MICHAEL KING

LANDSCAPE

STANTEC

5778 WEST 74TH STREET INDIANAPOLIS, IN 46278-1754 MICHAEL KING 317-879-8902 MICHAEL.KING@STANTEC.COM

CONSTRUCTION:

THE RIDGE GROUP

BRITTANY OLMSTEAD 3225 S. HOYT AVENUE MUNCIE, IN 47302 BOLMSTEAD@RIDGECORPORATION.COM

INTERIOR DESIGNER:

KELSEY PARKISON, NCIDQ

2325 N. DELAWARE ST INDIANAPOLIS, IN 46205 CONTACT: KELSEY PARKISON PHONE: 219-851-0192 KELSEYPARKISON@GMAIL.COM

3225 S. HOYT AVENUE MUNCIE, IN 47302 765-282-3778



INDIANAPOLIS, IN 46202 574-850-2270

PROJECT TITLE

REVISIONS MARK DESCRIPTION


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COVER

CHECKED BY: BP

FLOOR PLAN BUILDING TYPE-A - LEVEL 1

A311

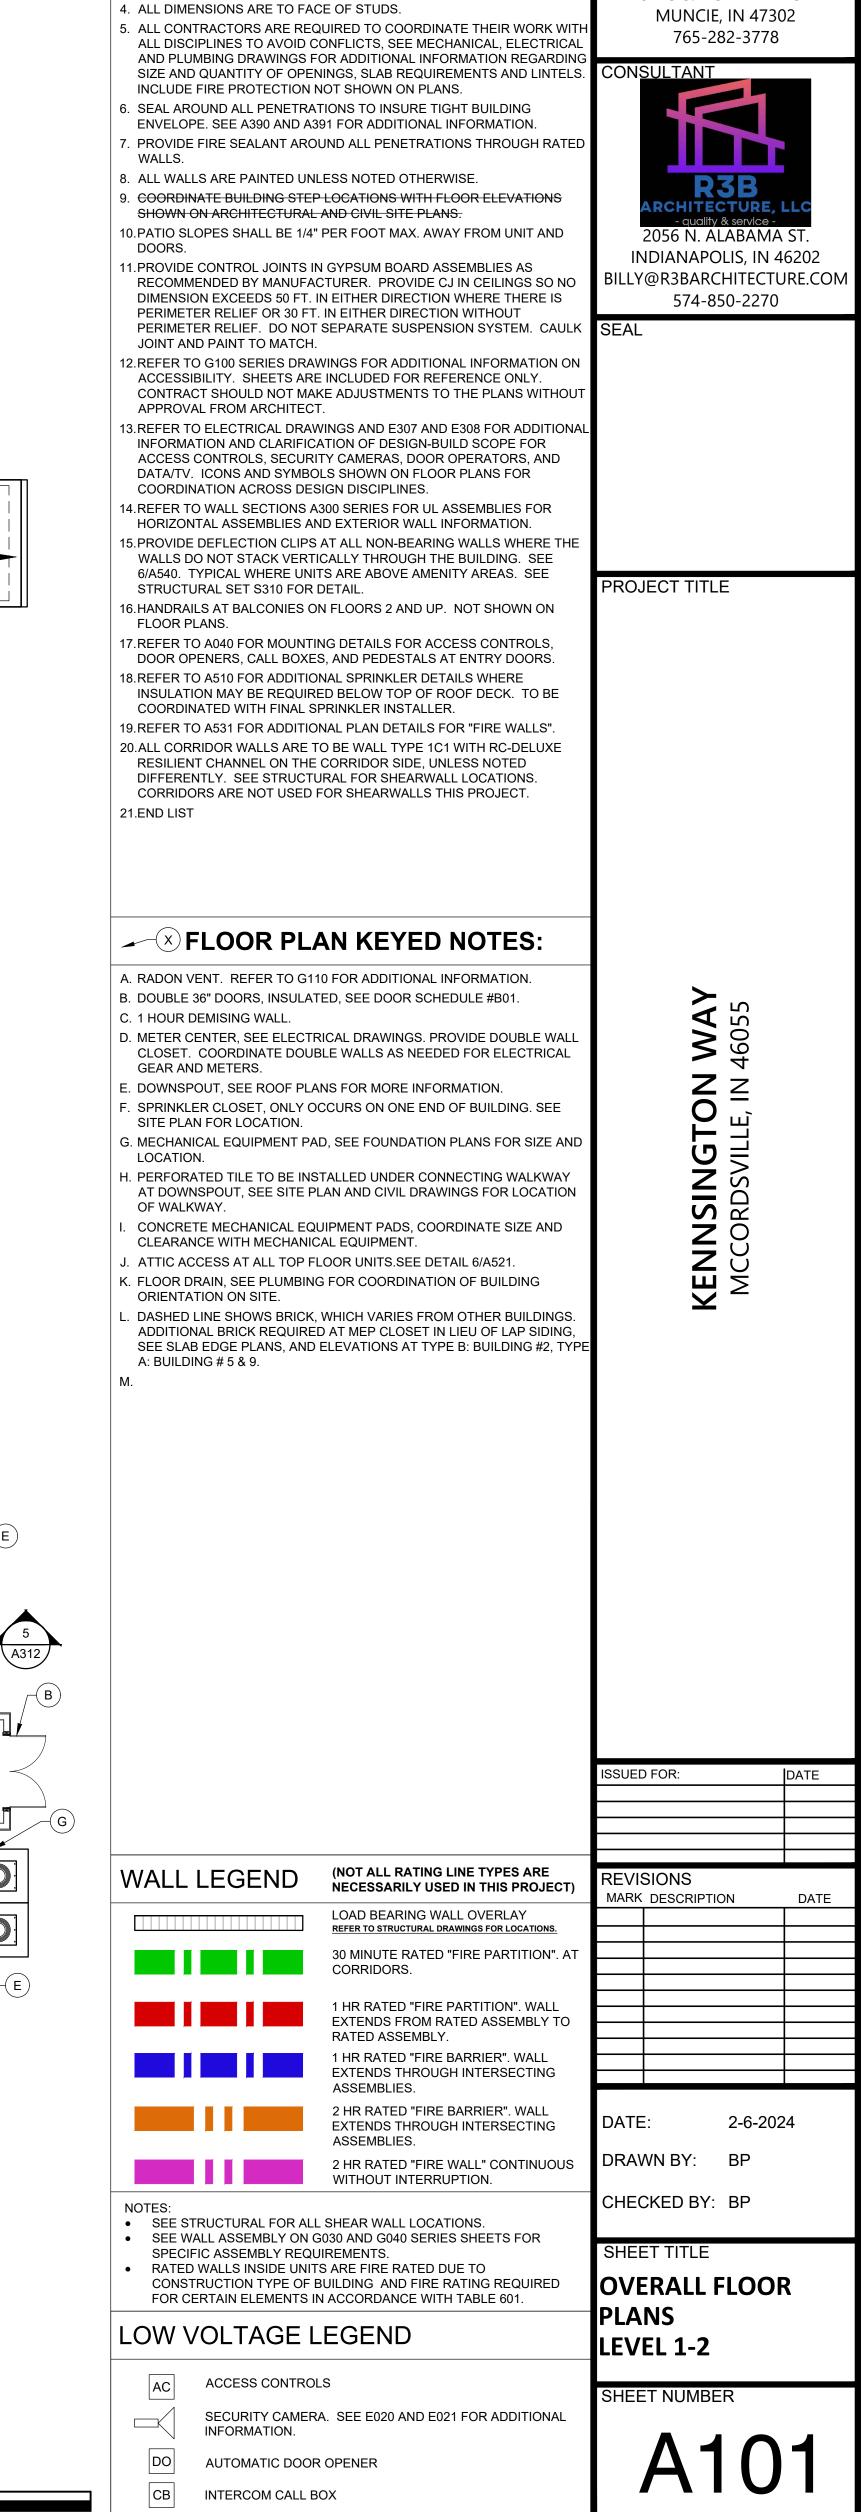

9'-9" — 9'-2" —

INTERCOM CALL BOX

SEE E307 AND E308 FOR ADDITIONAL INFORMATION.

Scale: 1/8" = 1' - 0"

A312

ROOF DRAINAGE CALCULAT	
MCCORDS VILLE UPDATED 12/22/2023 Light of the state of	1. DETAILED FLOOR AND ROOF TRUSS FRAMING DIAGRAMS ARE TO BE FURNISHED BY A STRUCTURAL ENGINEER LICENSED IN THE STATE WHERE THE PROJECT IS TO BE LOCATED. 2. THE TRUSS MANUFACTURER SHALL PROVIDE ENGINEERED
BOX VENT BASIS OF DESIGN FREE VENTILATION AREA. SOFFIT VENT BASIS OF DESIGN "HARDIESOFFIT, FREE VENTILATION AREA/ Reference Location: Indianapolis	PERMANENT ROOF TRUSS BRACING AS REQUIRED BY THE CODE.
LINEAR FT. X 5	4. DOWNSPOUTS TO BE PROVIDED WITH EXTENSIONS TO ENSURE ALL WATER DISCHARGES NO LESS THAN 6' FROM BUILDING FOUNDATION OR DIRECTLY INTO STORM SYSTEM 3225 S. HOYT AVENUE
BC 1203.2 NET FREE VENTILATION AREA SHALL BE > 1/X OF THE AREA. Exception #1 - The net free area shall be reduced to 1/300 provided that 50% < Actual Roof Area 1000	5. THE ENTIRE BUILDING ENVELOPE INCLUDING ROOF, WALLS, & FLOORS TO BE DRIED IN PRIOR TO THE STORAGE AND INSTALLATION OF INTERIOR FINISH MATERIALS. IN ADDITION, THE OWNER'S 3223 3. HOTT AVENUE MUNCIE, IN 47302 765-282-3778
x > 80% of the ventilators are positioned in the upper portion of the space > 3 ft above the soffit vents. ROOF PITCH FACTOR: 1.00 Calculated Roof Area 1000	REPRESENTATIVE IS RESPONSIBLE FOR VERIFYING THAT THERE HAS BEEN NO EVIDENCE OF WATER PENETRATING THE BUILDING ENVELOPE OR WATER LEAK FROM MECHANICAL AND/OR FIRE CONSULTANT
TOTAL FREE ATTIC AREA (SQ. INCHES) SOFFIT VENT SOFFIT	sprinkler systems prior to enclosing the Wall, Ceiling or Roof Cavities. 6. ARROWS ON THE ROOF PLAN INDICATE WATER DRAINAGE DIRECTION.
SQ. INCHES (NFVA / 2) REQUIRED, MINIMUM. Provided SQ. INCHES REQUIRED, MINIMUM. Provided Notes Notes Sq. INCHES Notes Notes Sq. INCHES Notes	7. FRAMING SUB-CONTRACTOR, PANEL MANUFACTURER, ROOFING SUPPLIERS, ROOF TRUSS MANUFACTURERS AND INSTALLERS SHALL
B 2552 1225 980 6.8 10.0 490 98.0 136	2 1/2" x 3" RECOMMENDED CHANGES. UNLESS NOTED OTHERWISE, ROOFING SUPPLIERS, MANUFACTURERS AND INSTALLERS WILL BE ASSUMED TO HAVE REVIEWED AND APPROVED THE DETAILS SHOWN. ARCHITECTURE, LLC - quality & service -
C 2522 1211 968 6.7 10.0 484 96.8 111 9:12 1.3 4 dia. 95 CLUB 6300 3024 2419 16.8 14.0 1210 241.9 320 11:12 1.2 5" dia. 74	3 1/2" x 4" 192 8. PRIME ALL METAL TO BE IN CONTACT WITH ROOFING MATERIALS. 2056 N. ALABAMA ST. INDIANAPOLIS, IN 46202 10. PROVIDE FLASHING PER DETAILS AT ALL CONDUIT AND HVAC LINES
6:12 - 8:12 1.1 6" dia. 110	PENETRATING THE ROOF. 4" x 5" 360 BILLY@R3BARCHITECTURE.CON 574-850-2270 THE NECESSARY CARE TO PREVENT DAMAGE TO OR PUNCTURE OF
4:12 - 5:12 1.05 3" x 5" 157 Flat - 3:12 1.0 4 1/2" x 6" 348	5 x 6" 563 THE ROOF. THIS SHALL INCLUDE ALL SHARP MATERIALS, TOOLS, MATERIAL SCRAPS OR MATERIALS HAVING A DELETERIOUS AFFECT ON THE ROOFING MATERIAL.
© IBC 1106.6	12. PROVIDE SOFFIT DRAFTSTOPPING AT 20' MAX. INTERVALS. 10. SEPARATE DISSIMILAR METALS AS THEY OCCUR PER MANUFACTURER'S RECOMMENDATIONS. REVIEW MATERIALS AND
	METHODS WITH ARCHITECT. 16. THE ROOF ASSEMBLY IS CONSIDERED A COMPLETE ROOF ASSEMBLY. ARCHITECTS DRAWINGS DO NOT INCLUDE ALL ACCESSORIES,
	FLASHING, TRANSITIONS, AND INSTALLATION DETAILS AS REQUIRED BY MANUFACTURER. OMISSIONS OF ANY ACCESSORY FROM THE ROOF PLAN SHALL NOT RELIEVE THE G.C. OR SUB-CONTRACTOR
	FROM PROVIDING A COMPLETE SYSTEM. 17. PROVIDE "ICE & WATER SHIELD" AROUND ALL PENETRATIONS. VALLEYS, AND ALONG EAVES. EXTEND 24" FROM FACE OF EXT. WALL.
\overline{DS}	18. PROVIDE A 24X36 MIN. OPENING TO ALL ROOF CAVITIES TO CONNECT TO THE MAIN VOLUME OF SPACE FOR VENTING AND ACCESS. RIDGE VENTS MAY BE USED AT GABLES ONLY. PROJECT TITLE
	- J DS
SLOPE SLOPE SLOPE SLOPE	
ATTIC AREA "C" = 2522 SF. ATTIC AREA "C" = 2522 SF.	1 2 99 2 7
	5
ROOF PLAN BUILDING TYPE B	
Scale: 1/8" = 1' - 0"	ROOF LEGEND (NOT ALL RATING LINE TYPES ARE NECESSARILY USED IN THIS PROJECT)
	2 HR RATED "FIRE WALL" CONTINUOUS WITHOUT INTERRUPTION.
	1 HR RATED "FIRE BARRIER". WALL EXTENDS FROM RATED ASSEMBLY TO
DS D	RATED ASSEMBLY. DRAFT STOPPING - ALIGN WITH DEMISING WALLS. LIMIT CAVITY TO
	3000 SQ. FT OR (2) UNITS (WHAT EVER IS LESS). ALIGN WITH 1 SIDE OF THE CORRIDOR. IBC 718.3.1 -
	DRAFTSTOPPING, WHERE SHOWN, IS INTENDED TO STOP THE PASSAGE OF AIR. ALIGN WITH FIRE RATED WALLS ("FIRE BARRIERS") BELOW.
	("FIRE BARRIERS") BELOW. 1 ROOF PLAN KEYED NOTES
	1 RADON VENT REFER TO G110 FOR ADDITIONAL INFORMATION REVISIONS
SLOPE SLOPE	1.1. OFFSET PIPE IN ROOF CAVITY TO AVOID FIRE TREATED DECKING. 2. ASPHALTIC ROOF SHINGLES ON SYNTHETIC UNDERLAYMENT, 30 YEAR WARRANTY, ENERGY STAR, ANTI-FUNGAL RATED. BASIS OF DESIGN -
ATTIC AREA "A" = 2047 SF.	OWENS CORNING, OAKRIDGE, 3. not used 4. DRAFTSTOPPING IN CEILING-ROOF CAVITY BELOW. ACCEPTABLE
ATTIC AREA "A" = 2047 SF. U O O O O O O O O O O O O	DRAFTSTOPPING MATERIALS INCLUDE: 4.1. ½" GYPSUM BOARD 4.2. ¾" WOOD STRUCTURAL PANELS
SLOPE SLOPE	4.3. ³ / ₈ " PARTICLE BOARD 4.4. 1" NOMINAL LUMBER
SLOPE SLOPE 9	4.5. CEMENT FIBERBOARD 4.6. MINERAL WOOL 5. TYPICAL GUTTER. REFER TO ELEVATIONS FOR DOWNSPOUT DATE: 2-6-2024
	LOCATIONS. GUTTERS TO BE 6" WIDE X 6" DEEP. SLOPE TO BE 1/16" PER 1'-0". DOWNSPOUTS TO BE 5" WIDE X 5" DEEP. SEE 12/A520. Considerable by the construction of the con
	VENTILATION CHART. 7. LINE OF WALLS BELOW. 8. ATTIC ACCESS HATCH IN CEILING AT TOP FLOOR. SIZE 20"X40"
DS D	MINIMUM, 9. SOFFIT VENTS, 5 SQ. INCHES / FOOT MIN
	 10. DOOR THROUGH DRAFTSTOPPING COMPARTMENTS. SEE SHEET 8/A521. 11. EXTEND DRAFT STOPPING TO EDGE OF OVERHANG IN THE ROOF ATTIC SPACE. ALIGN WITH UNIT DEMISING WALL BELOW.
DS DS DS	12. END LIST
	SHEET NUMBER
ROOF PLAN BUILDING TYPE A	A103
Scale: 1/8" = 1' - 0"	




SEAL

PROJECT TITLE

2

KENNSINGTON WAY MCCORDSVILLE, IN 46055

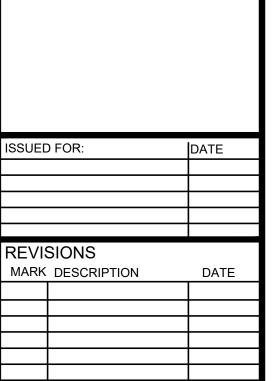

DATE: 2-6-2
DRAWN BY: BP

CHECKED BY: BP

SHEET TITLE
RENDERINGS
TYPE A

SHEET NUMBER

A201







R3B
ARCHITECTURE, LLC
- quality & service 2056 N. ALABAMA ST.
INDIANAPOLIS, IN 46202
BILLY@R3BARCHITECTURE.COM
574-850-2270

765-282-3778

SEAL

PROJECT TITLE

KENNSINGTON WAY MCCORDSVILLE, IN 46055





ISSUED FOR:	DATE
REVISIONS MARK DESCRIPTION	DATE

DRAWN BY: BP

SHEET TITLE
RENDERINGS
TYPE B

SHEET NUMBER

A202





PROJECT TITLE









ISSUED FOR:	DATE
REVISIONS MARK DESCRIPTION	DATE


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SHEET TITLE RENDERINGS CLUBHOUSE



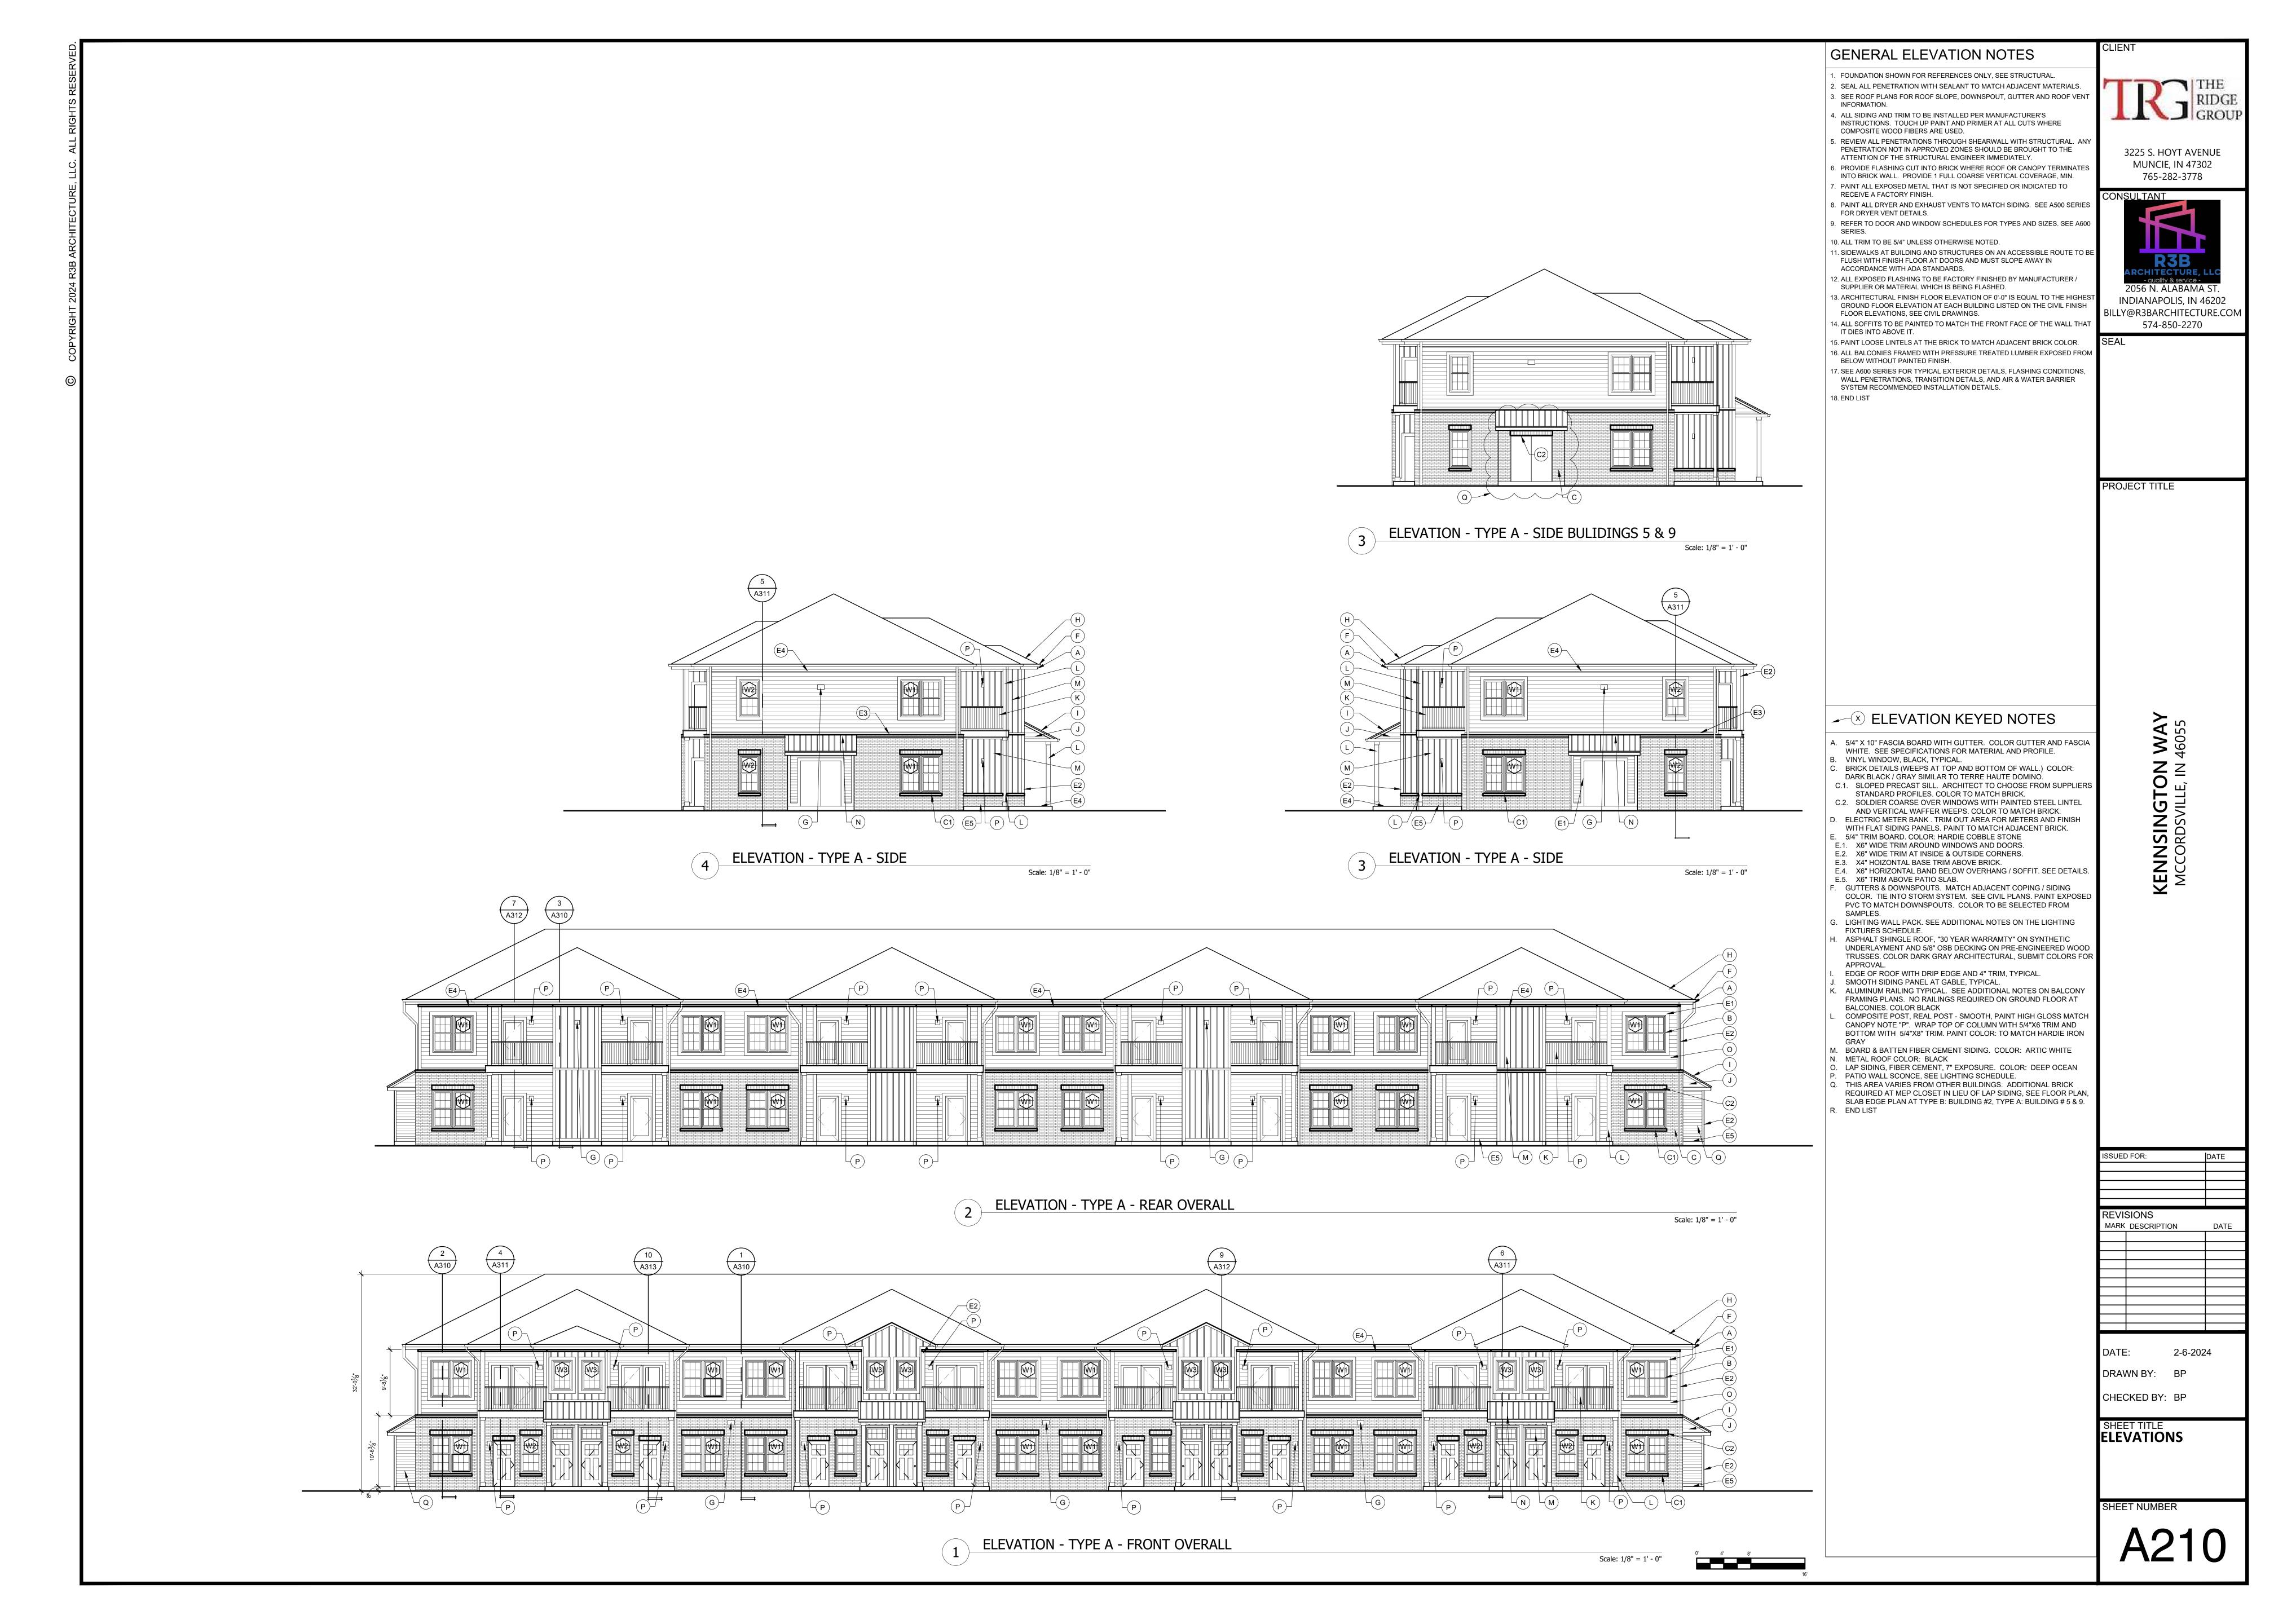



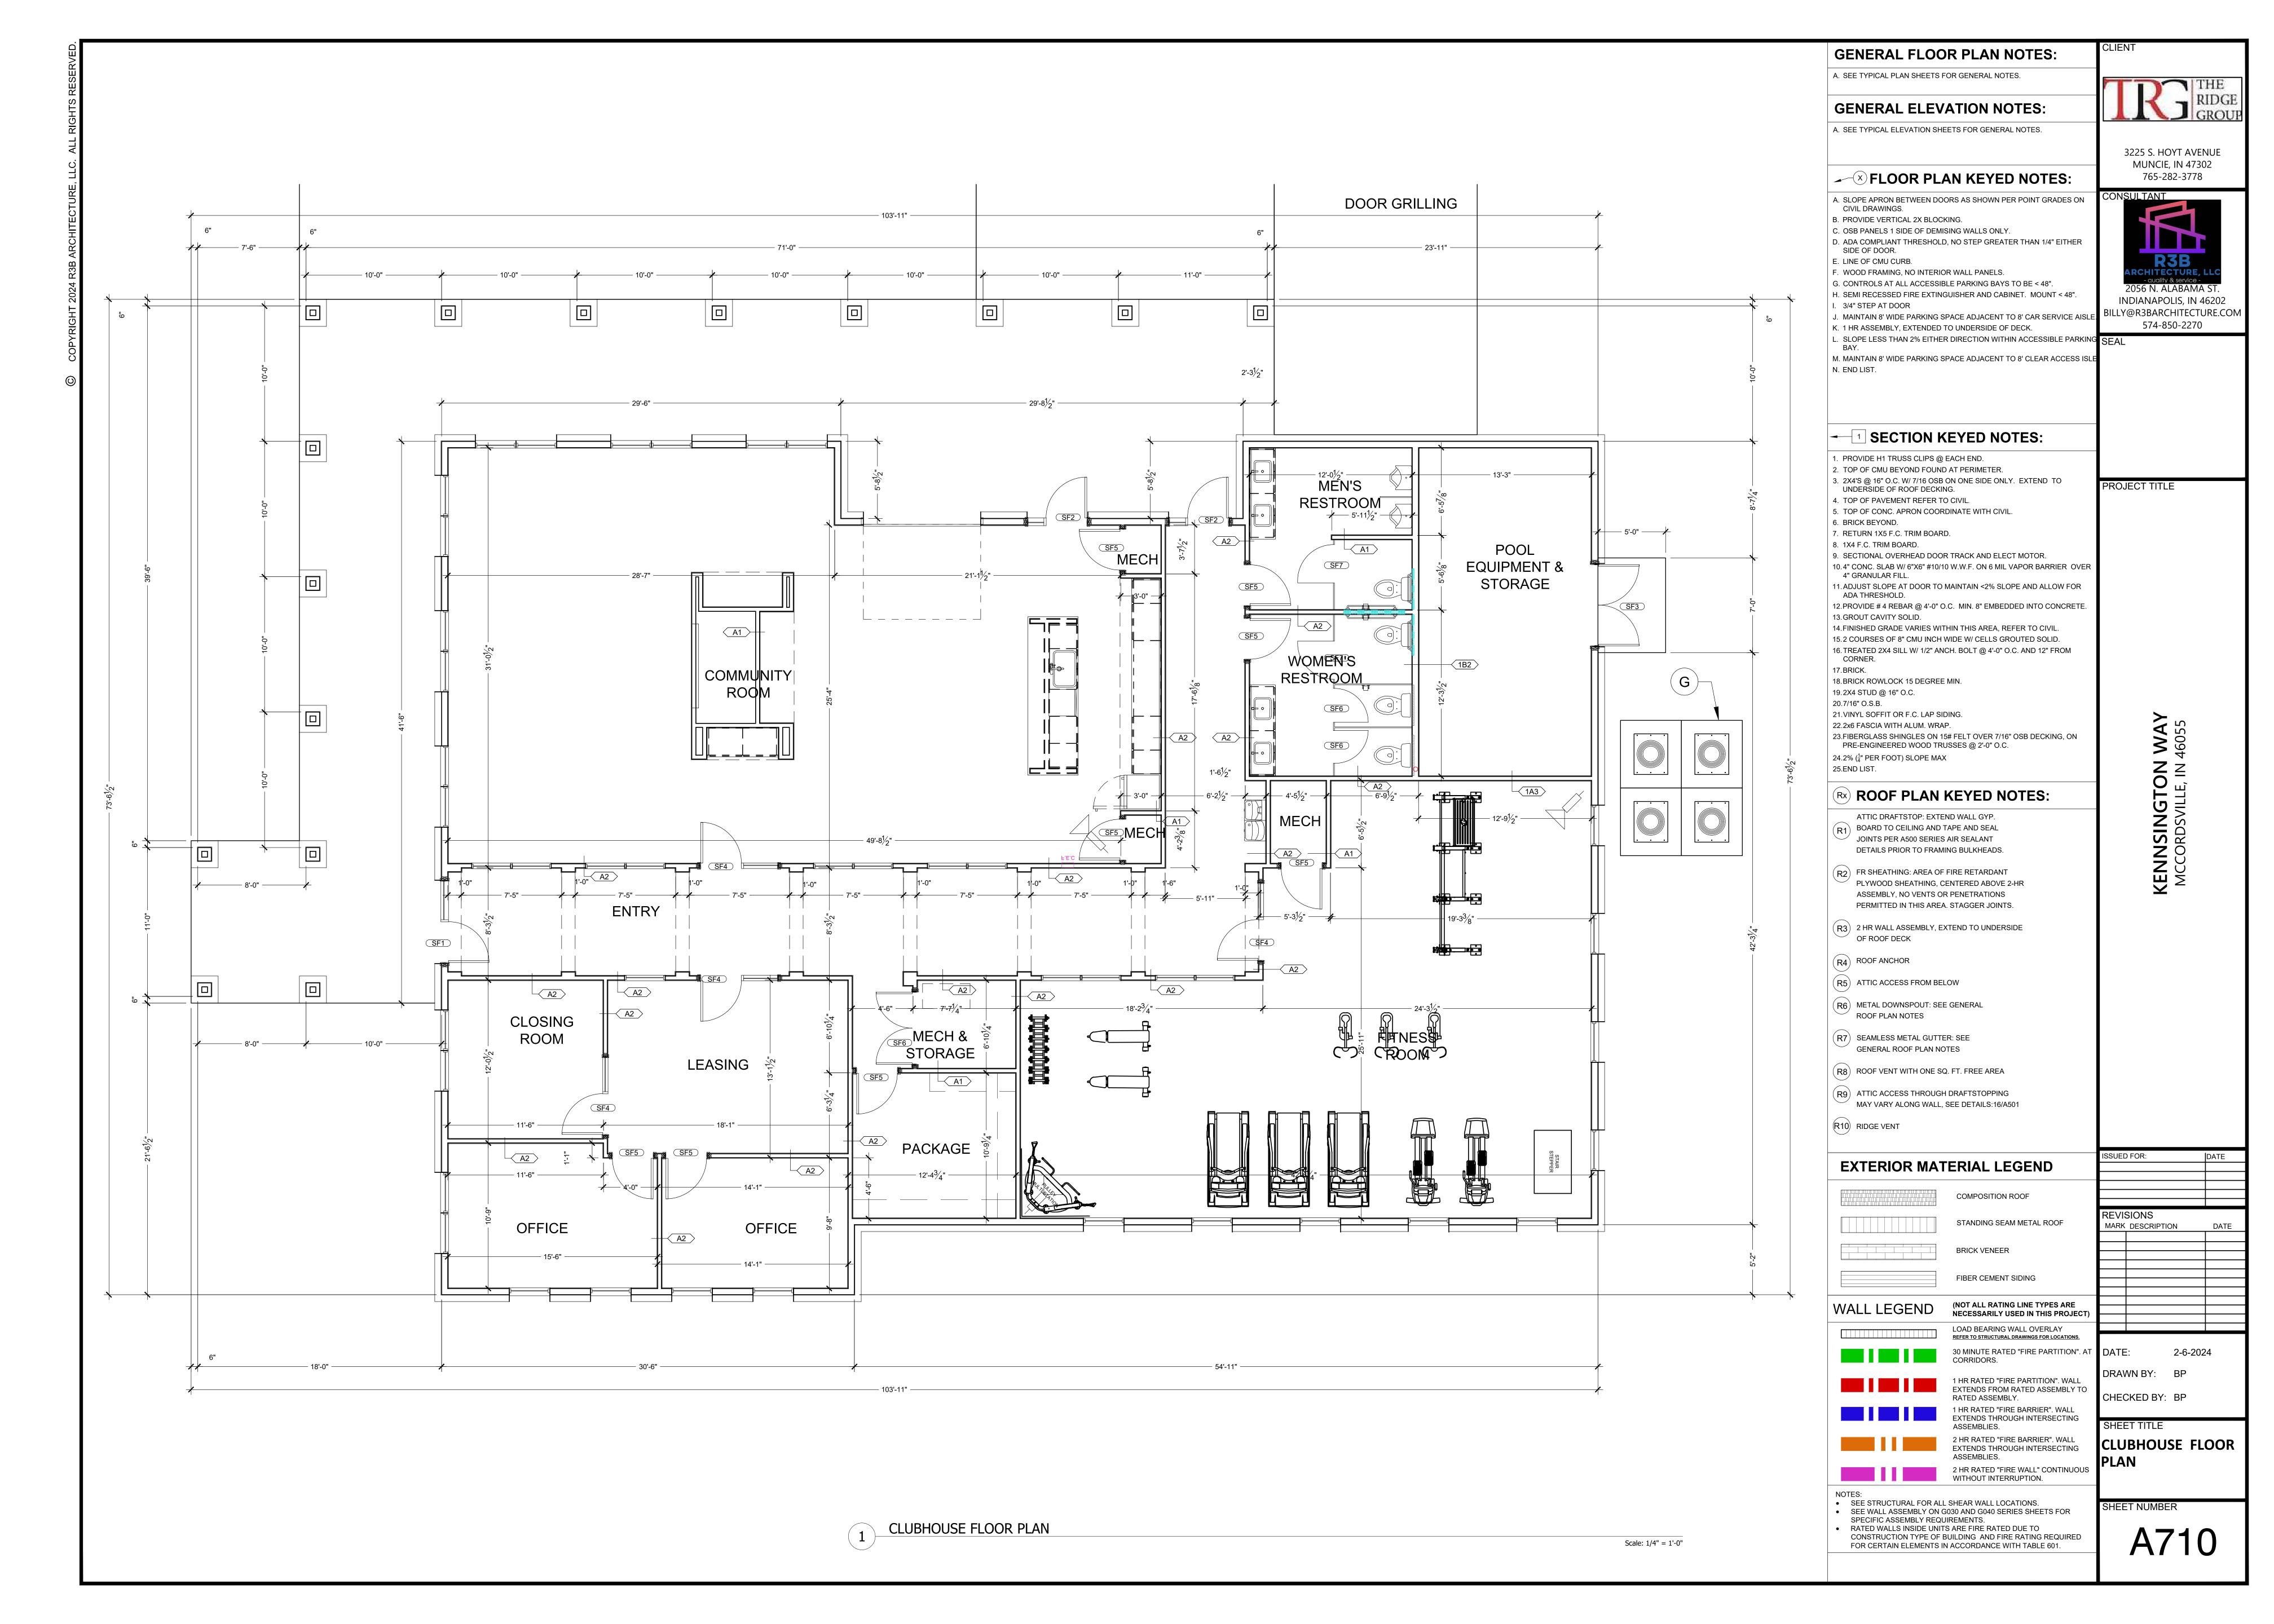

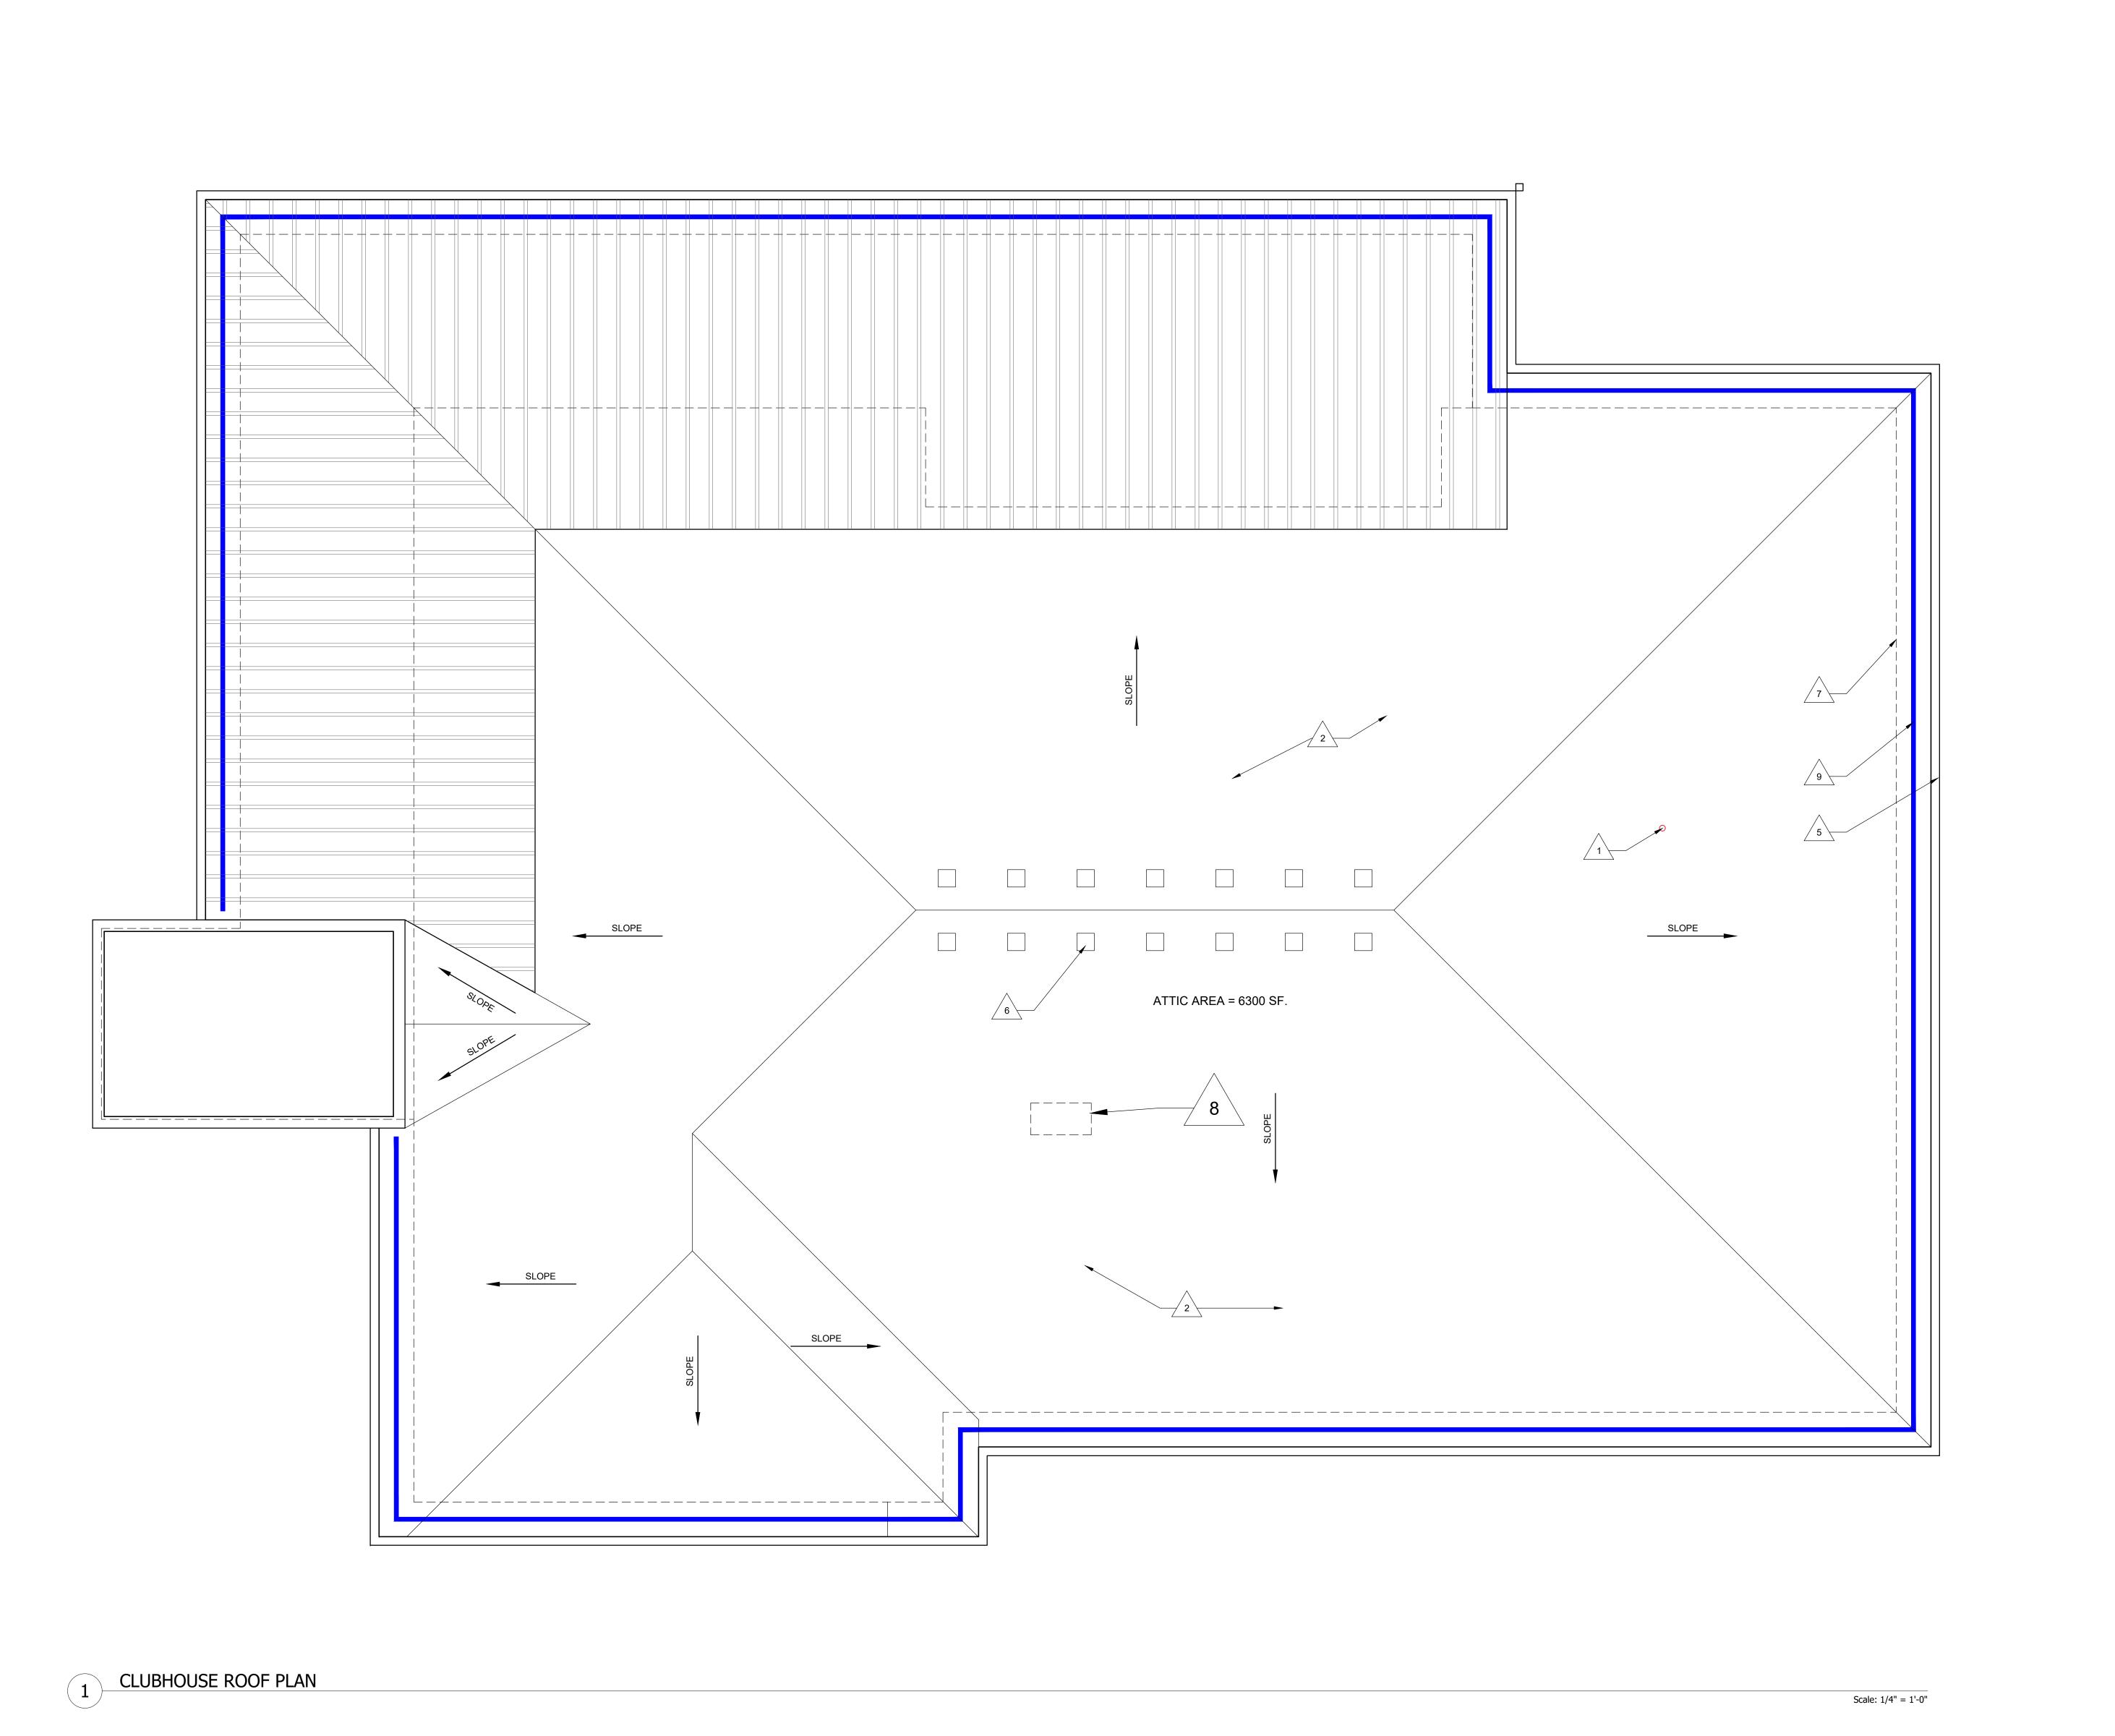GENERAL FLOOR PLAN NOTES:

A. SEE TYPICAL PLAN SHEETS FOR GENERAL NOTES.

GENERAL ELEVATION NOTES:

A. SEE TYPICAL ELEVATION SHEETS FOR GENERAL NOTES.

3225 S. HOYT AVENUE MUNCIE, IN 47302

765-282-3778

2056 N. ALABAMA ST.

INDIANAPOLIS, IN 46202

BILLY@R3BARCHITECTURE.COM

574-850-2270

PROJECT TITLE

KENNSINGTON WAY MCCORDSVILLE, IN 46055

FLOOR PLAN KEYED NOTES:

A. SLOPE APRON BETWEEN DOORS AS SHOWN PER POINT GRADES ON CIVIL DRAWINGS.

- B. PROVIDE VERTICAL 2X BLOCKING.
- C. OSB PANELS 1 SIDE OF DEMISING WALLS ONLY.
- D. ADA COMPLIANT THRESHOLD, NO STEP GREATER THAN 1/4" EITHER SIDE OF DOOR. E. LINE OF CMU CURB.
- F. WOOD FRAMING, NO INTERIOR WALL PANELS.
- G. CONTROLS AT ALL ACCESSIBLE PARKING BAYS TO BE < 48". H. SEMI RECESSED FIRE EXTINGUISHER AND CABINET. MOUNT < 48".
- I. 3/4" STEP AT DOOR
- J. MAINTAIN 8' WIDE PARKING SPACE ADJACENT TO 8' CAR SERVICE AISLE. K. 1 HR ASSEMBLY, EXTENDED TO UNDERSIDE OF DECK.
- L. SLOPE LESS THAN 2% EITHER DIRECTION WITHIN ACCESSIBLE PARKING SEAL

M. MAINTAIN 8' WIDE PARKING SPACE ADJACENT TO 8' CLEAR ACCESS ISLE N. END LIST.

SECTION KEYED NOTES:

- 1. PROVIDE H1 TRUSS CLIPS @ EACH END.
- 2. TOP OF CMU BEYOND FOUND AT PERIMETER. 3. 2X4'S @ 16" O.C. W/ 7/16 OSB ON ONE SIDE ONLY. EXTEND TO
- UNDERSIDE OF ROOF DECKING. 4. TOP OF PAVEMENT REFER TO CIVIL.
- 5. TOP OF CONC. APRON COORDINATE WITH CIVIL.
- 6. BRICK BEYOND. 7. RETURN 1X5 F.C. TRIM BOARD.
- 8. 1X4 F.C. TRIM BOARD.
- 9. SECTIONAL OVERHEAD DOOR TRACK AND ELECT MOTOR.
- 10.4" CONC. SLAB W/ 6"X6" #10/10 W.W.F. ON 6 MIL VAPOR BARRIER OVER 4" GRANULAR FILL. 11. ADJUST SLOPE AT DOOR TO MAINTAIN <2% SLOPE AND ALLOW FOR
- ADA THRESHOLD. 12.PROVIDE # 4 REBAR @ 4'-0" O.C. MIN. 8" EMBEDDED INTO CONCRETE.
- 13. GROUT CAVITY SOLID.
- 14. FINISHED GRADE VARIES WITHIN THIS AREA, REFER TO CIVIL. 15.2 COURSES OF 8" CMU INCH WIDE W/ CELLS GROUTED SOLID.
- 16. TREATED 2X4 SILL W/ 1/2" ANCH. BOLT @ 4'-0" O.C. AND 12" FROM
- 17.BRICK.
- 18.BRICK ROWLOCK 15 DEGREE MIN. 19.2X4 STUD @ 16" O.C.
- 20.7/16" O.S.B.
- 21.VINYL SOFFIT OR F.C. LAP SIDING.
- 22.2x6 FASCIA WITH ALUM. WRAP. 23.FIBERGLASS SHINGLES ON 15# FELT OVER 7/16" OSB DECKING, ON
- PRE-ENGINEERED WOOD TRUSSES @ 2'-0" O.C. 24.2% ($\frac{1}{4}$ " PER FOOT) SLOPE MAX
- 25.END LIST.

RX ROOF PLAN KEYED NOTES:

- ATTIC DRAFTSTOP: EXTEND WALL GYP. (R1) BOARD TO CEILING AND TAPE AND SEAL JOINTS PER A500 SERIES AIR SEALANT
- (R2) FR SHEATHING: AREA OF FIRE RETARDANT PLYWOOD SHEATHING, CENTERED ABOVE 2-HR ASSEMBLY, NO VENTS OR PENETRATIONS

DETAILS PRIOR TO FRAMING BULKHEADS.

(R3) 2 HR WALL ASSEMBLY, EXTEND TO UNDERSIDE OF ROOF DECK

PERMITTED IN THIS AREA. STAGGER JOINTS.

- R4 ROOF ANCHOR
- (R5) ATTIC ACCESS FROM BELOW
- (R6) METAL DOWNSPOUT: SEE GENERAL ROOF PLAN NOTES
- (R7) SEAMLESS METAL GUTTER: SEE
- GENERAL ROOF PLAN NOTES
- (R8) ROOF VENT WITH ONE SQ. FT. FREE AREA
- (R9) ATTIC ACCESS THROUGH DRAFTSTOPPING MAY VARY ALONG WALL, SEE DETAILS:16/A501
- R10 RIDGE VENT

EXTERIOR MATERIAL LEGEND

STANDING SEAM METAL ROOF

BRICK VENEER

COMPOSITION ROOF

FIBER CEMENT SIDING

(NOT ALL RATING LINE TYPES ARE NECESSARILY USED IN THIS PROJECT) WALL LEGEND

1 HR RATED "FIRE BARRIER". WALL

30 MINUTE RATED "FIRE PARTITION". AT CORRIDORS. 1 HR RATED "FIRE PARTITION". WALL EXTENDS FROM RATED ASSEMBLY TO RATED ASSEMBLY.

LOAD BEARING WALL OVERLAY REFER TO STRUCTURAL DRAWINGS FOR LOCATIONS.

EXTENDS THROUGH INTERSECTING ASSEMBLIES. 2 HR RATED "FIRE BARRIER". WALL EXTENDS THROUGH INTERSECTING ASSEMBLIES.

RATED WALLS INSIDE UNITS ARE FIRE RATED DUE TO

2 HR RATED "FIRE WALL" CONTINUOUS 2 HR RATED FINE WILL WITHOUT INTERRUPTION.

 SEE STRUCTURAL FOR ALL SHEAR WALL LOCATIONS. SEE WALL ASSEMBLY ON G030 AND G040 SERIES SHEETS FOR SPECIFIC ASSEMBLY REQUIREMENTS.

CONSTRUCTION TYPE OF BUILDING AND FIRE RATING REQUIRED

FOR CERTAIN ELEMENTS IN ACCORDANCE WITH TABLE 601.

CLUBHOUSE ROOF

REVISIONS


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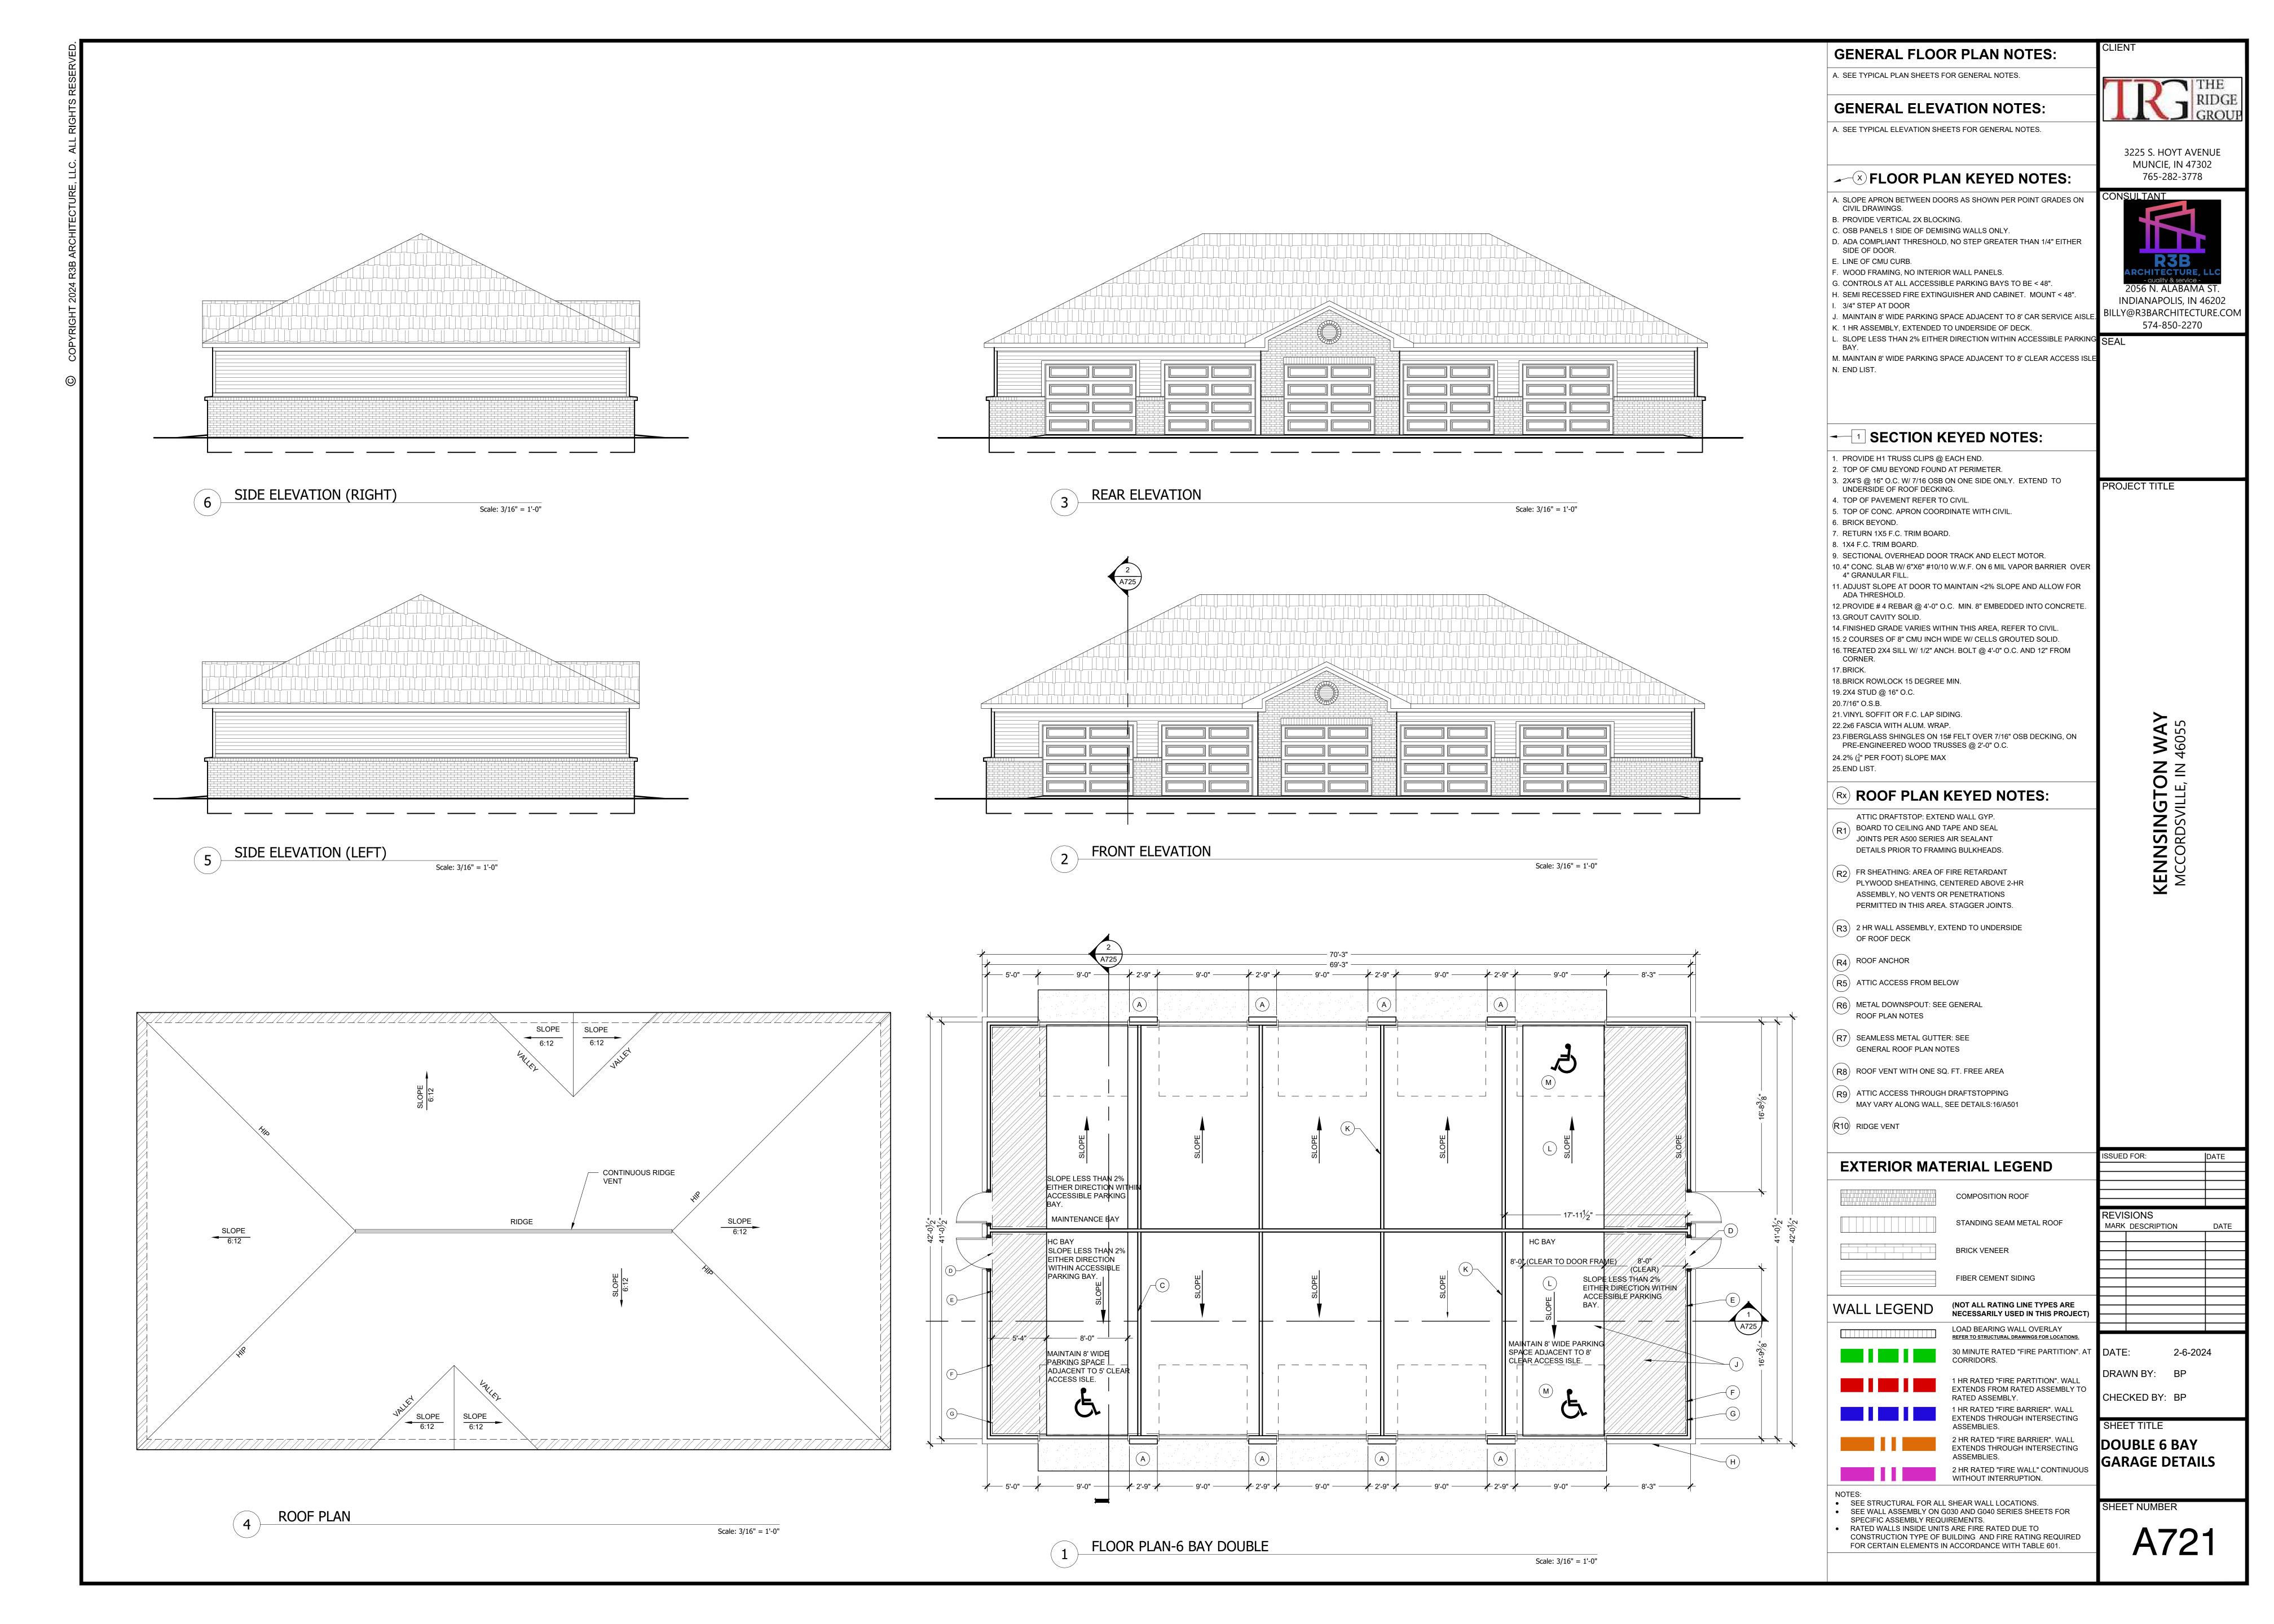
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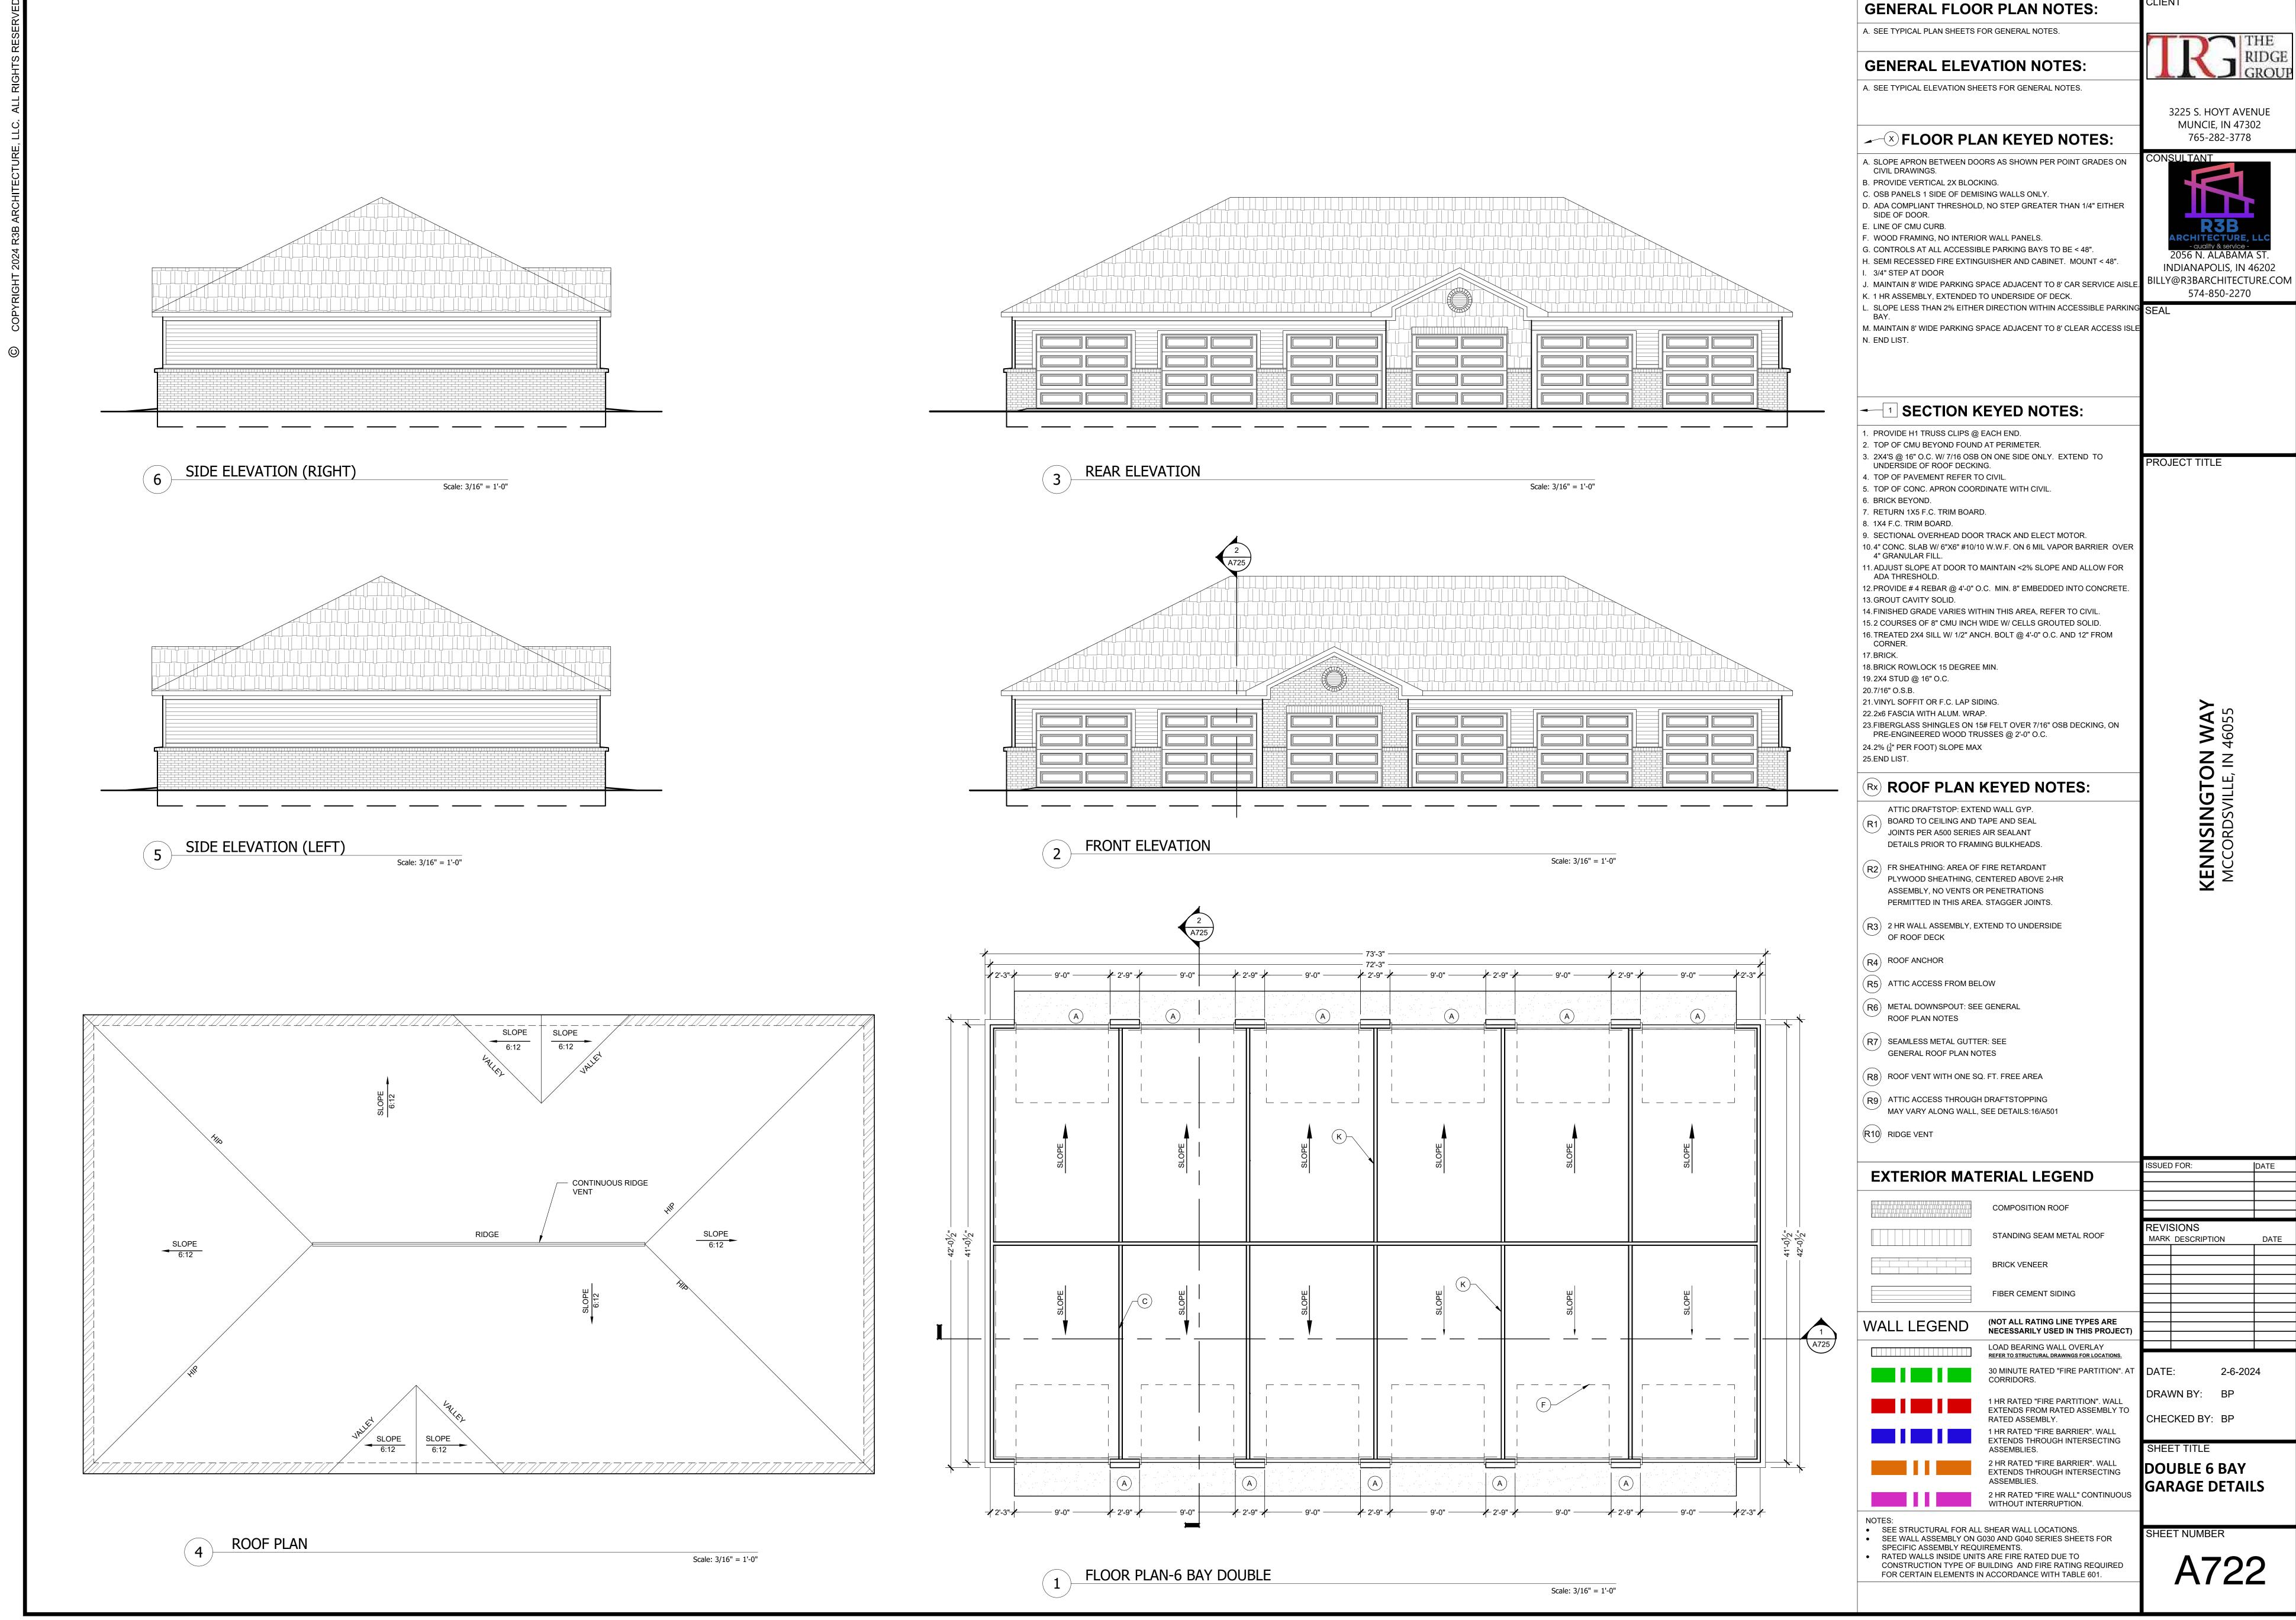
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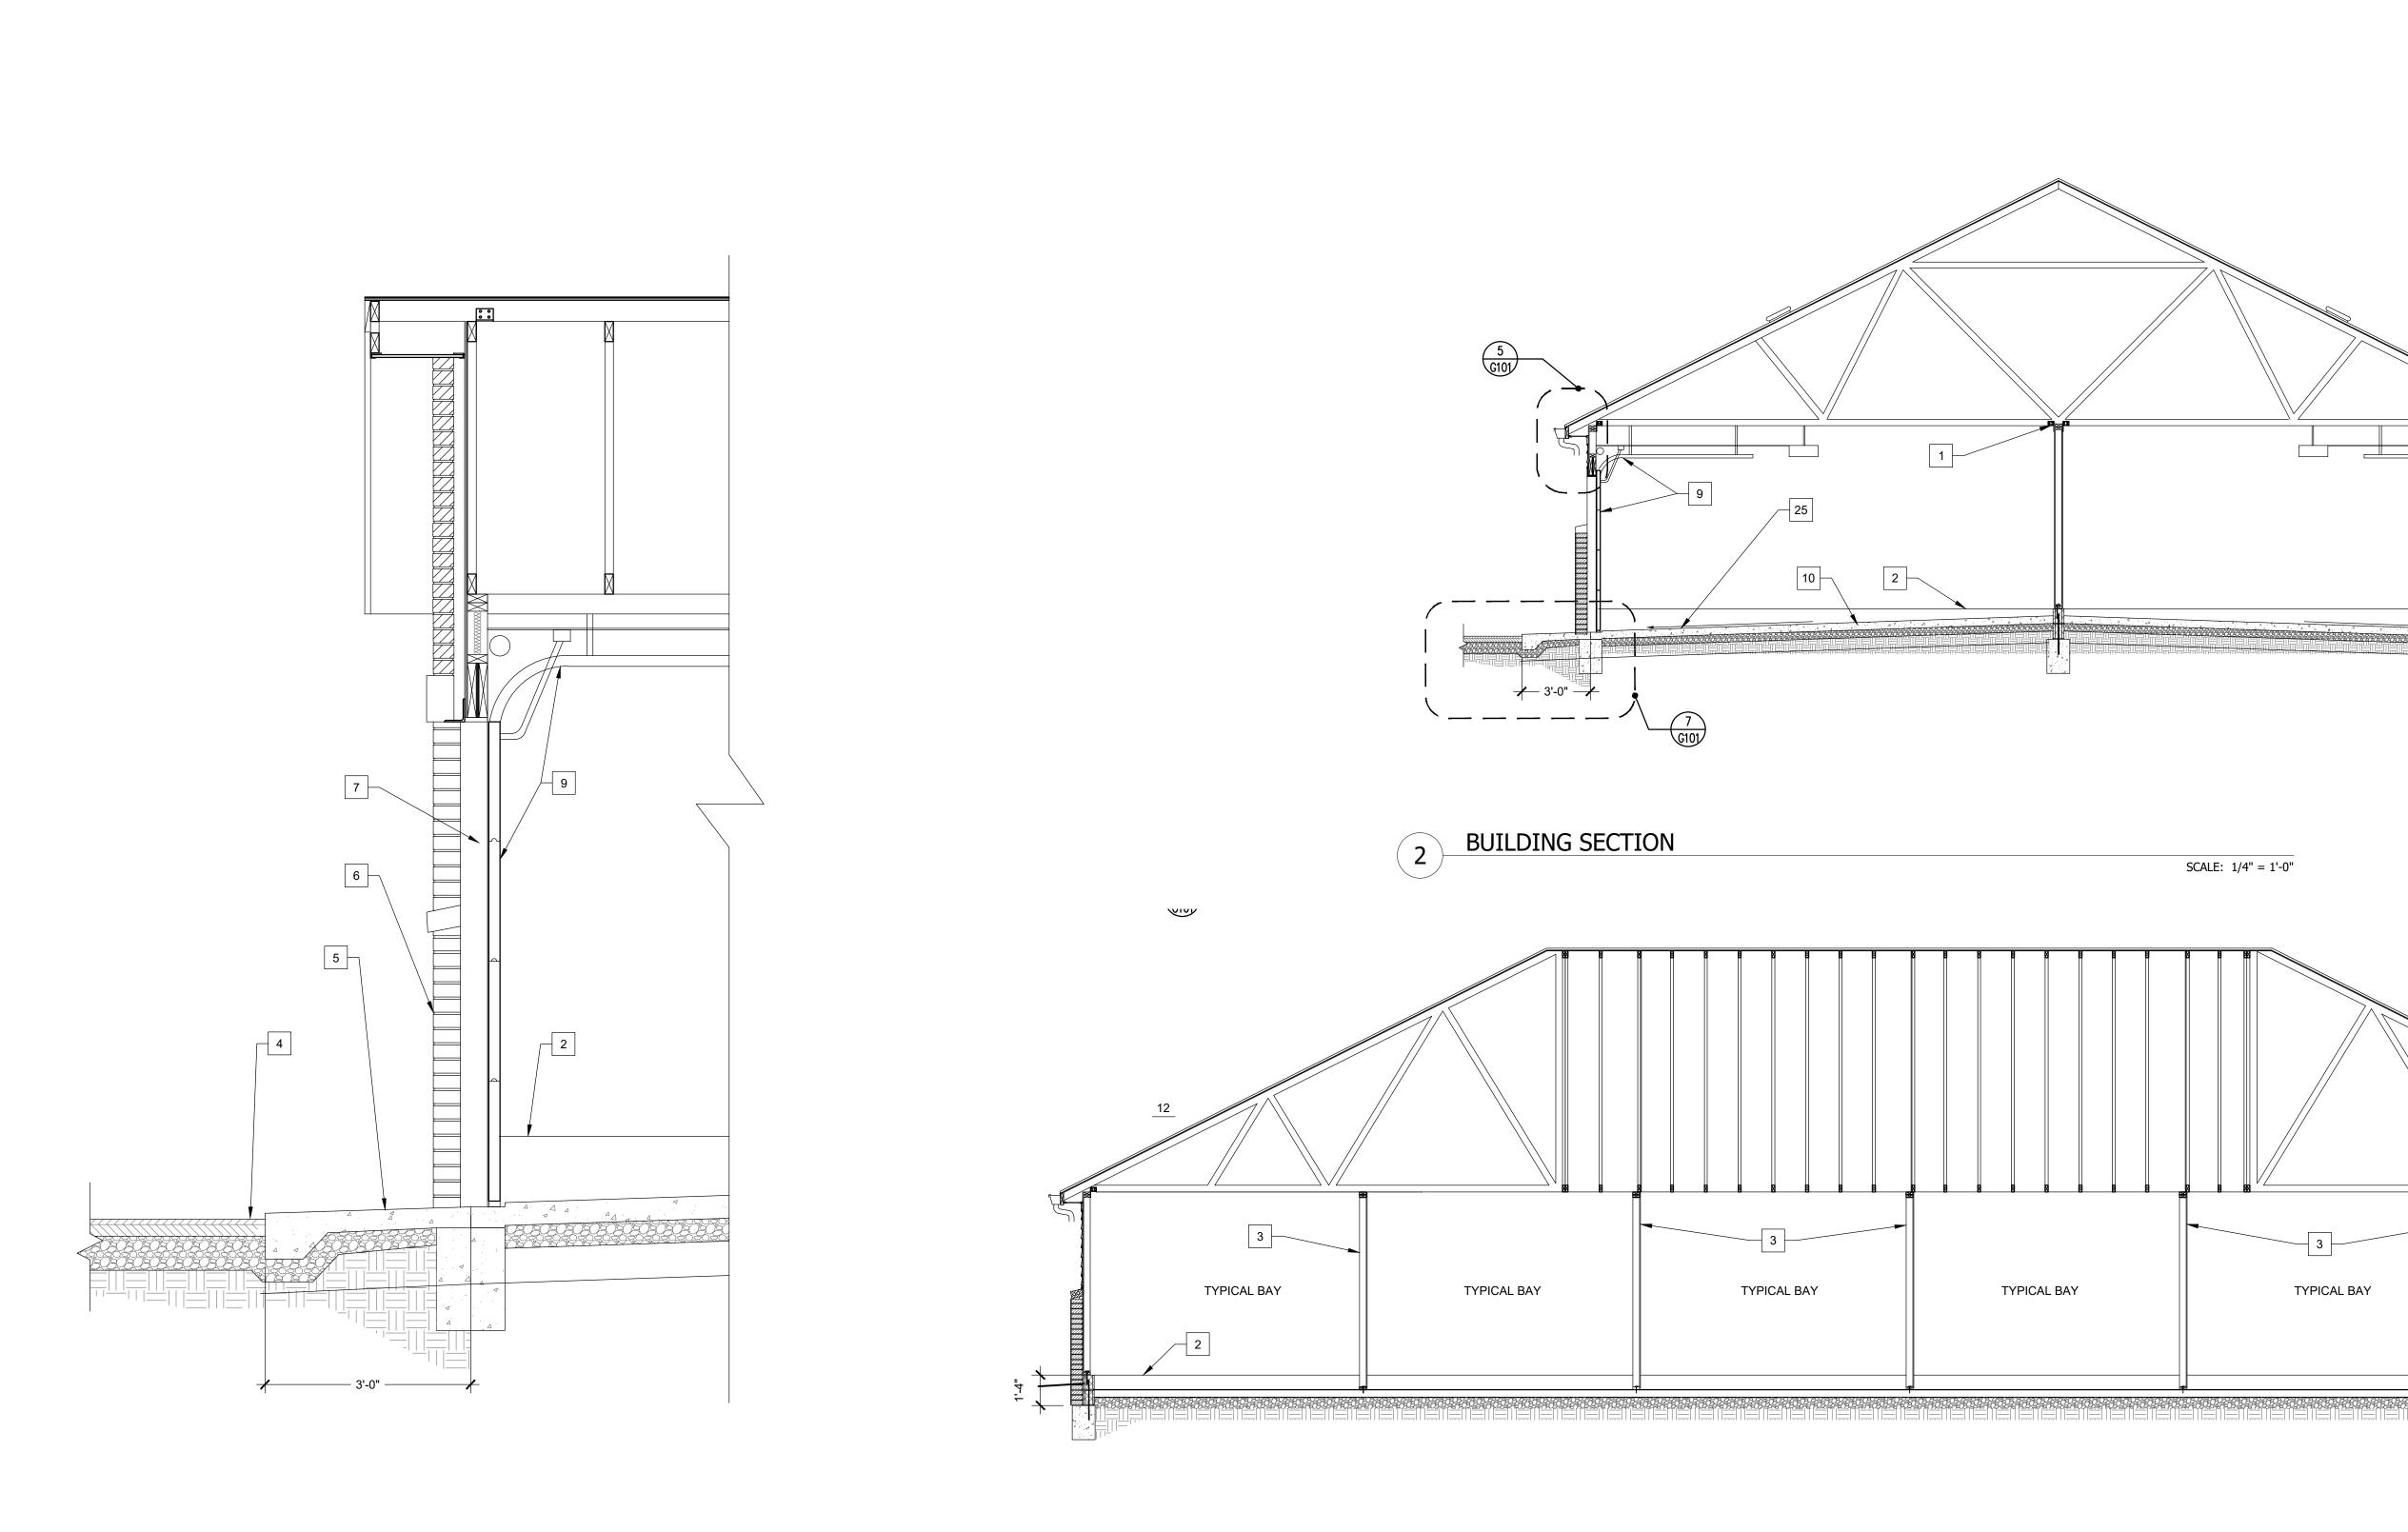
SHEET TITLE

SHEET NUMBER







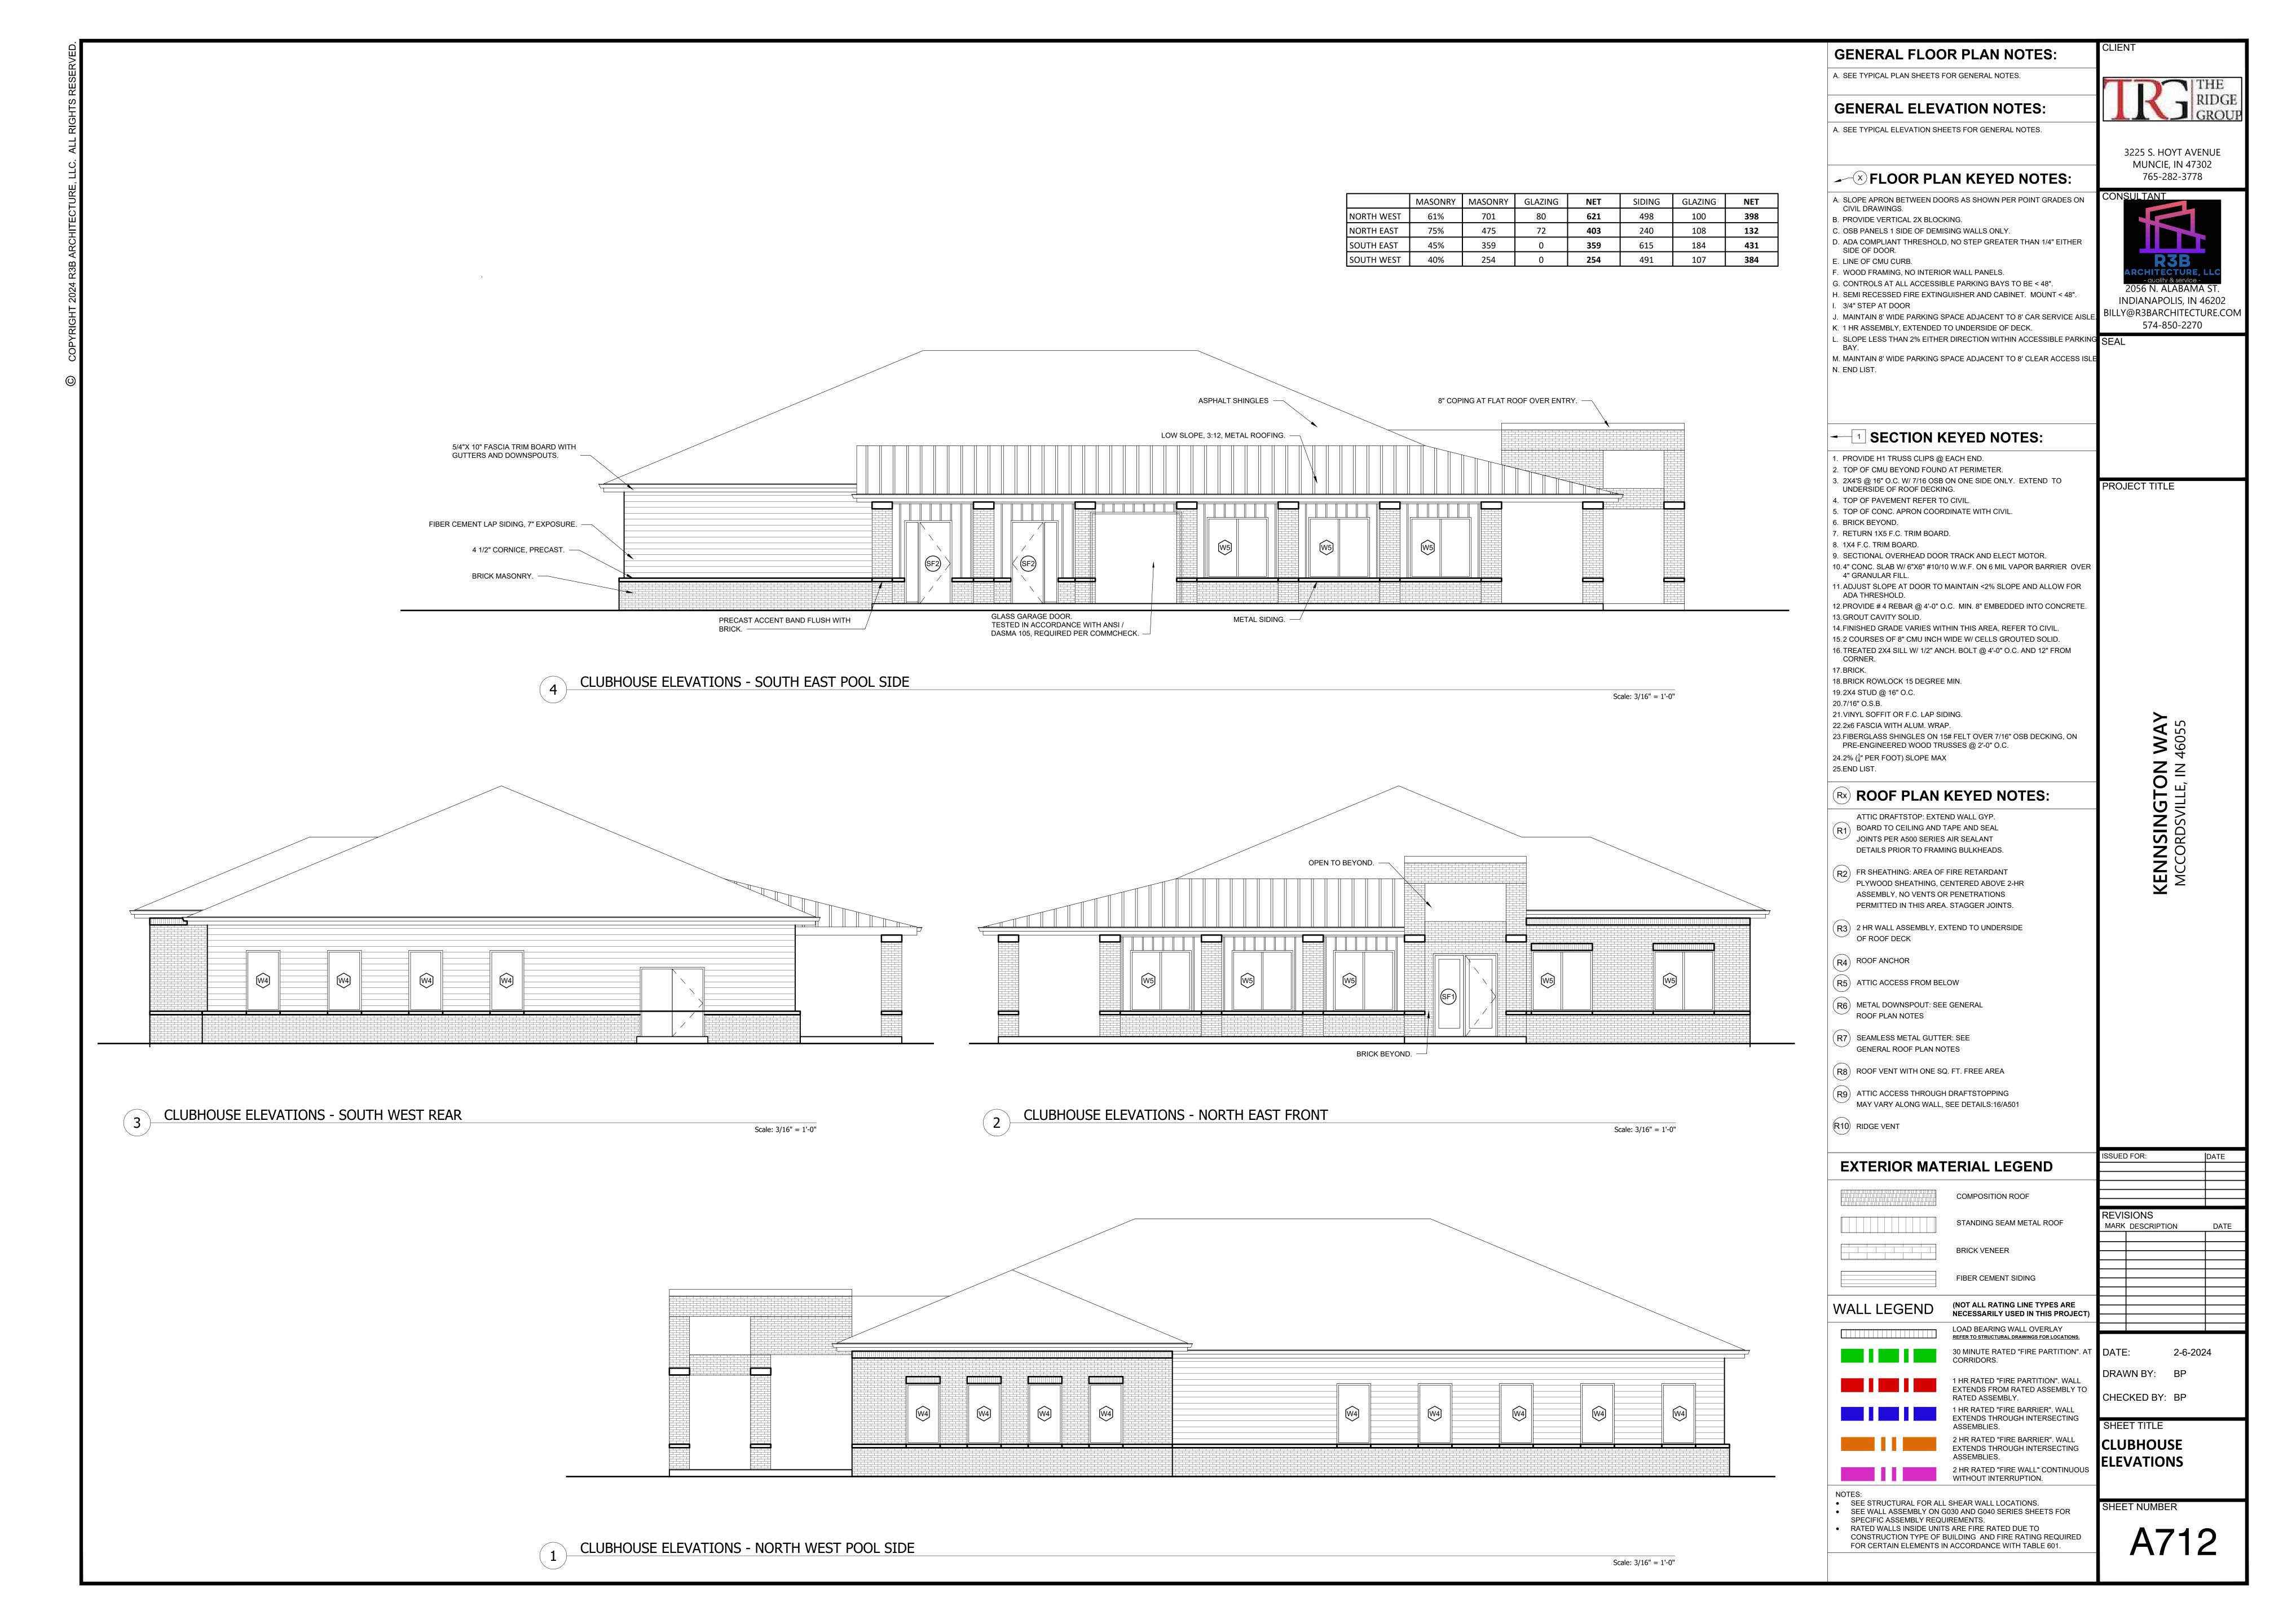

WALL SECTION

Scale: 3/4" = 1'-0"

GENERAL ELEVATION NOTES: A. SEE TYPICAL ELEVATION SHEETS FOR GENERAL NOTES. 3225 S. HOYT AVENUE MUNCIE, IN 47302 FLOOR PLAN KEYED NOTES: 765-282-3778 CONSULTANT A. SLOPE APRON BETWEEN DOORS AS SHOWN PER POINT GRADES ON CIVIL DRAWINGS. B. PROVIDE VERTICAL 2X BLOCKING. C. OSB PANELS 1 SIDE OF DEMISING WALLS ONLY. D. ADA COMPLIANT THRESHOLD, NO STEP GREATER THAN 1/4" EITHER SIDE OF DOOR. E. LINE OF CMU CURB. F. WOOD FRAMING, NO INTERIOR WALL PANELS. G. CONTROLS AT ALL ACCESSIBLE PARKING BAYS TO BE < 48". 2056 N. ALABAMA ST. H. SEMI RECESSED FIRE EXTINGUISHER AND CABINET. MOUNT < 48". INDIANAPOLIS, IN 46202 I. 3/4" STEP AT DOOR BILLY@R3BARCHITECTURE.COM J. MAINTAIN 8' WIDE PARKING SPACE ADJACENT TO 8' CAR SERVICE AISLE. 574-850-2270 K. 1 HR ASSEMBLY, EXTENDED TO UNDERSIDE OF DECK. L. SLOPE LESS THAN 2% EITHER DIRECTION WITHIN ACCESSIBLE PARKING SEAL M. MAINTAIN 8' WIDE PARKING SPACE ADJACENT TO 8' CLEAR ACCESS ISLE N. END LIST. SECTION KEYED NOTES: 1. PROVIDE H1 TRUSS CLIPS @ EACH END. 2. TOP OF CMU BEYOND FOUND AT PERIMETER. 3. 2X4'S @ 16" O.C. W/ 7/16 OSB ON ONE SIDE ONLY. EXTEND TO PROJECT TITLE UNDERSIDE OF ROOF DECKING. 4. TOP OF PAVEMENT REFER TO CIVIL. 5. TOP OF CONC. APRON COORDINATE WITH CIVIL. 6. BRICK BEYOND. 7. RETURN 1X5 F.C. TRIM BOARD. 8. 1X4 F.C. TRIM BOARD. 9. SECTIONAL OVERHEAD DOOR TRACK AND ELECT MOTOR. 10.4" CONC. SLAB W/ 6"X6" #10/10 W.W.F. ON 6 MIL VAPOR BARRIER OVER 4" GRANULAR FILL. 11. ADJUST SLOPE AT DOOR TO MAINTAIN <2% SLOPE AND ALLOW FOR ADA THRESHOLD. 12.PROVIDE # 4 REBAR @ 4'-0" O.C. MIN. 8" EMBEDDED INTO CONCRETE. 13. GROUT CAVITY SOLID. 14. FINISHED GRADE VARIES WITHIN THIS AREA, REFER TO CIVIL. 15.2 COURSES OF 8" CMU INCH WIDE W/ CELLS GROUTED SOLID. 16. TREATED 2X4 SILL W/ 1/2" ANCH. BOLT @ 4'-0" O.C. AND 12" FROM 17.BRICK. 18. BRICK ROWLOCK 15 DEGREE MIN. 19.2X4 STUD @ 16" O.C. 20.7/16" O.S.B. 21.VINYL SOFFIT OR F.C. LAP SIDING. KENNSINGTON WAY MCCORDSVILLE, IN 46055 22.2x6 FASCIA WITH ALUM. WRAP. 23.FIBERGLASS SHINGLES ON 15# FELT OVER 7/16" OSB DECKING, ON PRE-ENGINEERED WOOD TRUSSES @ 2'-0" O.C. 24.2% ($\frac{1}{4}$ " PER FOOT) SLOPE MAX 25.END LIST. (RX) ROOF PLAN KEYED NOTES: ATTIC DRAFTSTOP: EXTEND WALL GYP. (R1) BOARD TO CEILING AND TAPE AND SEAL JOINTS PER A500 SERIES AIR SEALANT DETAILS PRIOR TO FRAMING BULKHEADS. (R2) FR SHEATHING: AREA OF FIRE RETARDANT PLYWOOD SHEATHING, CENTERED ABOVE 2-HR ASSEMBLY, NO VENTS OR PENETRATIONS PERMITTED IN THIS AREA. STAGGER JOINTS. (R3) 2 HR WALL ASSEMBLY, EXTEND TO UNDERSIDE OF ROOF DECK (R4) ROOF ANCHOR (R5) ATTIC ACCESS FROM BELOW (R6) METAL DOWNSPOUT: SEE GENERAL ROOF PLAN NOTES (R7) SEAMLESS METAL GUTTER: SEE GENERAL ROOF PLAN NOTES (R8) ROOF VENT WITH ONE SQ. FT. FREE AREA (R9) ATTIC ACCESS THROUGH DRAFTSTOPPING MAY VARY ALONG WALL, SEE DETAILS:16/A501 R10 RIDGE VENT **EXTERIOR MATERIAL LEGEND** COMPOSITION ROOF STANDING SEAM METAL ROOF

GENERAL FLOOR PLAN NOTES:

A. SEE TYPICAL PLAN SHEETS FOR GENERAL NOTES.

REVISIONS MARK DESCRIPTION BRICK VENEER FIBER CEMENT SIDING (NOT ALL RATING LINE TYPES ARE NECESSARILY USED IN THIS PROJECT LOAD BEARING WALL OVERLAY REFER TO STRUCTURAL DRAWINGS FOR LOCATIONS. 30 MINUTE RATED "FIRE PARTITION". AT CORRIDORS. DRAWN BY: BP 1 HR RATED "FIRE PARTITION". WALL EXTENDS FROM RATED ASSEMBLY TO RATED ASSEMBLY.

ASSEMBLIES.

ASSEMBLIES.

SPECIFIC ASSEMBLY REQUIREMENTS.

RATED WALLS INSIDE UNITS ARE FIRE RATED DUE TO

CONSTRUCTION TYPE OF BUILDING AND FIRE RATING REQUIRED FOR CERTAIN ELEMENTS IN ACCORDANCE WITH TABLE 601.

EXTENDS THROUGH INTERSECTING

WITHOUT INTERRUPTION.

1

TYPICAL BAY

SCALE: 1/4" = 1'-0"

CHECKED BY: BP 1 HR RATED "FIRE BARRIER". WALL EXTENDS THROUGH INTERSECTING SHEET TITLE 2 HR RATED "FIRE BARRIER". WALL

GARAGE SECTION & 2 HR RATED "FIRE WALL" CONTINUOUS

 SEE STRUCTURAL FOR ALL SHEAR WALL LOCATIONS. SHEET NUMBER SEE WALL ASSEMBLY ON G030 AND G040 SERIES SHEETS FOR

BUILDING SECTION

