
CONSTRUCTION PLANS FOR CULVER'S

NW CORNER OF US 36 AND MT COMFORT ROAD MCCORDSVILLE, IN 46055



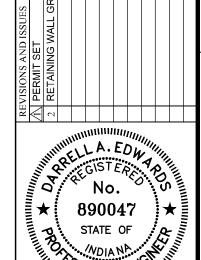

DARRELL A. EDWARDS P.E. #8900

Call before you dig. SHEET NO.

W22.0408

PLANS PREPARED FOR

CULVER'S PO BOX 1478 **MARION, IN 46952** TELEPHONE: (765) 206-0050 CONTACT PERSON: JIM SWAN EMAIL: JIM.SWAN@SSS2020.COM

PLANS PREPARED BY


WEIHE ENGINEERS, INC. 10505 N. COLLEGE AVE. INDIANAPOLIS, INDIANA 46280 TELEPHONE: (317) 846-6611 CONTACT PERSON: SCOTT RUCKER, P.E. EMAIL: RUCKERS@WEIHE.NET




- 1. THE CONTRACTOR SHALL BE RESPONSIBLE FOR OBTAINING, OR VERIFYING THAT ALL PERMITS AND APPROVALS ARE OBTAINED FROM THE RESPECTIVE CITY, COUNTY, AND STATE AGENCIES PRIOR TO
- 2. IT SHALL BE THE CONTRACTORS RESPONSIBILITY TO DETERMINE THE EXACT LOCATION OF ALL EXISTING UTILITIES IN THE VICINITY OF THE CONSTRUCTION AREA PRIOR TO STARTING CONSTRUCTION
- 3. IT SHALL BE THE CONTRACTORS RESPONSIBILITY TO NOTIFY AND COORDINATE CONSTRUCTION WITH ALL
- 4. ALL QUANTITIES GIVEN ON THESE PRINTS, VERBALLY OR IN THE SCOPE OF WORK SECTION ARE ESTIMATES AND SHALL BE CONFIRMED BY THE BIDDING CONTRACTORS.
- 5. OCCUPATIONAL SAFETY AND HEALTH ADMINISTRATION (OSHA) STANDARDS FOR EXCAVATIONS; FINAL RULE 29 CFR PART 1926, SUBPART "P" APPLIES TO ALL EXCAVATIONS EXCEEDING FIVE (5) FEET IN DEPTH.
- 6. IN ADDITION, EXCAVATION EXCEEDING TWENTY (20) FEET IN DEPTH REQUIRE THE DESIGN OF A TRENCH SAFETY SYSTEM BY A REGISTERED PROFESSIONAL ENGINEER.
- 7. IT SHALL BE THE RESPONSIBILITY OF THE DEVELOPER AND CONTRACTOR TO MAINTAIN QUALITY CONTROL
- 8. TEMPORARY TRAFFIC CONTROL DURING CONSTRUCTION TO CONFORM TO APPLICABLE LOCAL

STORM SEWERS AND POSITIVE DRAINAGE PRESERVED.

- 9. THE ENGINEER AND/OR OWNER DISCLAIM ANY ROLE IN THE CONSTRUCTION MEANS AND METHODS
- ASSOCIATED WITH THE PROJECT AS SET FORTH IN THESE PLANS. 10. ANY FIELD TILES ENCOUNTERED DURING EXCAVATION SHALL BE REPAIRED AND CONNECTED TO NEW
- 11. IT SHALL BE THE RESPONSIBILITY OF THE DEVELOPER THAT ALL LANDSCAPE REQUIREMENTS ARE MET
- AND CONFORM TO APPLICABLE LOCAL STANDARDS. 12. THE SITE DOES NOT LIE IN A SPECIAL FLOOD HAZARD AREA AS ESTABLISHED BY THE FEDERAL
- EMERGENCY MANAGEMENT AGENCY NATIONAL FLOOD INSURANCE PROGRAM, WHEN PLOTTED BY SCALE ON FLOOD INSURANCE RATE MAP #18057C0228G, DATED NOVEMBER 19, 2014.
- 13. BEARINGS, DIMENSIONS AND EASEMENTS ARE SHOWN FOR REFERENCE ONLY. SEE RECORD SURVEYS &
- 14. THIS SITE DOES NOT CONTAIN ANY WETLANDS AT SHOWN ON THE U.S. DEPARTMENT OF THE INTERIOR FISH AND WILDLIFE SERVICE; McCORDSVILLE, INDIANA, NATIONAL WETLANDS INVENTORY MAP DATED 1990.

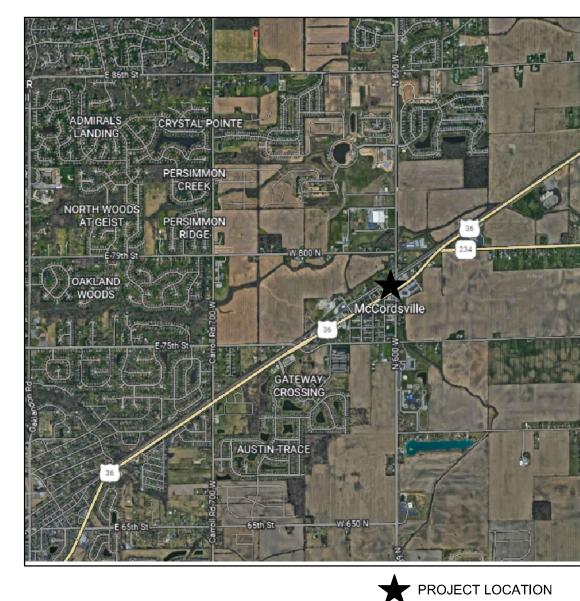

AREA MAP

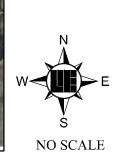



PROJECT LOCATION

LOCATION MAP

OPERATING AUTHORITIES

MCCORDSVILLE PLANNING AND BUILDING CITIZENS ENERGY GROUP 6280 W 800 N MCCORDSVILLE, IN 46055 RYAN CRUM 317 263 6382 TEL: 317.335.3604 VECTREN ENERGY MCCORDSVILLE ENGINEERING DEPARTMENT

6280 W 800 N MCCORDSVILLE, IN 46055 MARK WITTSMAN TEL: 317.335.3604 MCCORDSVILLE VOLUNTEER FIRE DEPARTMENT 7580 N FORM ST

TEL: 317 335 9236 MCCORDSVILLE PUBLIC WOKS DEPARTMENT 6280 W 800 N MCCORDSVILLE, IN 46055 RON CRIDER

MCCORDSVILLE, IN 46055

TEL: 317.335.3493

1220 WATERWAY BLVD INDIANAPOLIS, IN 46202 112 W. SOUTH ST GREENFIELD, IN 46140 TEL: 765.648.3246 COMCAST 9750 E. 150th STREET SUITE 1600 NOBLESVILLE, INDIANA 46060 TEL: 317/776-4495

INDIANAPOLIS POWER AND LIGHT 1230 W. MORRIS ST INDIANAPOLIS, IN 46221 TEL: 317.261.5203 NINESTAR CONNECT 2243 E. MAIN ST GREENFIELD, IN 46140


TEL: 317.323.2087


LAND DESCRIPTION SEE SURVEY

SHEET NUMBER	SHEET TITLE				
C0.0	TITLE SHEET				
C0.5	GENERAL NOTES				
C1.0	SURVEY				
C1.1	SURVEY				
C2.0	SITE DEMO S.E.S.C SWPPP1				
C2.1	SITE STABILIZATION - SWPPP2				
C2.2	SWPPP SPECIFICATIONS				
C3.0	SITE PLAN				
C4.0	GRADING PLAN				
C5.0	UTILITY PLAN				
C5.1	STORM PLAN AND PROFILE				
C6.0	LANDSCAPE PLAN				
C7.0	LIGHTING AND PHOTOMETRIC PLAN				
C8.0	SWPPP DETAILS				
C8.1	SITE DETAILS				
C8.2	UTILITY DETAILS				
C8.3	LANDSCAPE DETAILS				
C8.4	LIGHT POLE DETAILS				
C8.5	TRASH CORRAL DETAILS				
C9.1	GENERAL SPECIFICATIONS				
C9.2	GENERAL SPECIFICATIONS				

Sheet List Table


Know what's **below**. Within Indiana Call 811 or 800-382-5544 24 Hours a Day, 7 Days a Week. PER INDIANA STATE LAW IC 8-1-26. IT IS AGAINST THE LAW TO EXCAVATE WITHOUT NOTIFYING THE UNDERGROUND LOCATION SERVICE TWO (2) WORKING DAYS BEFORE COMMENCING WORK.

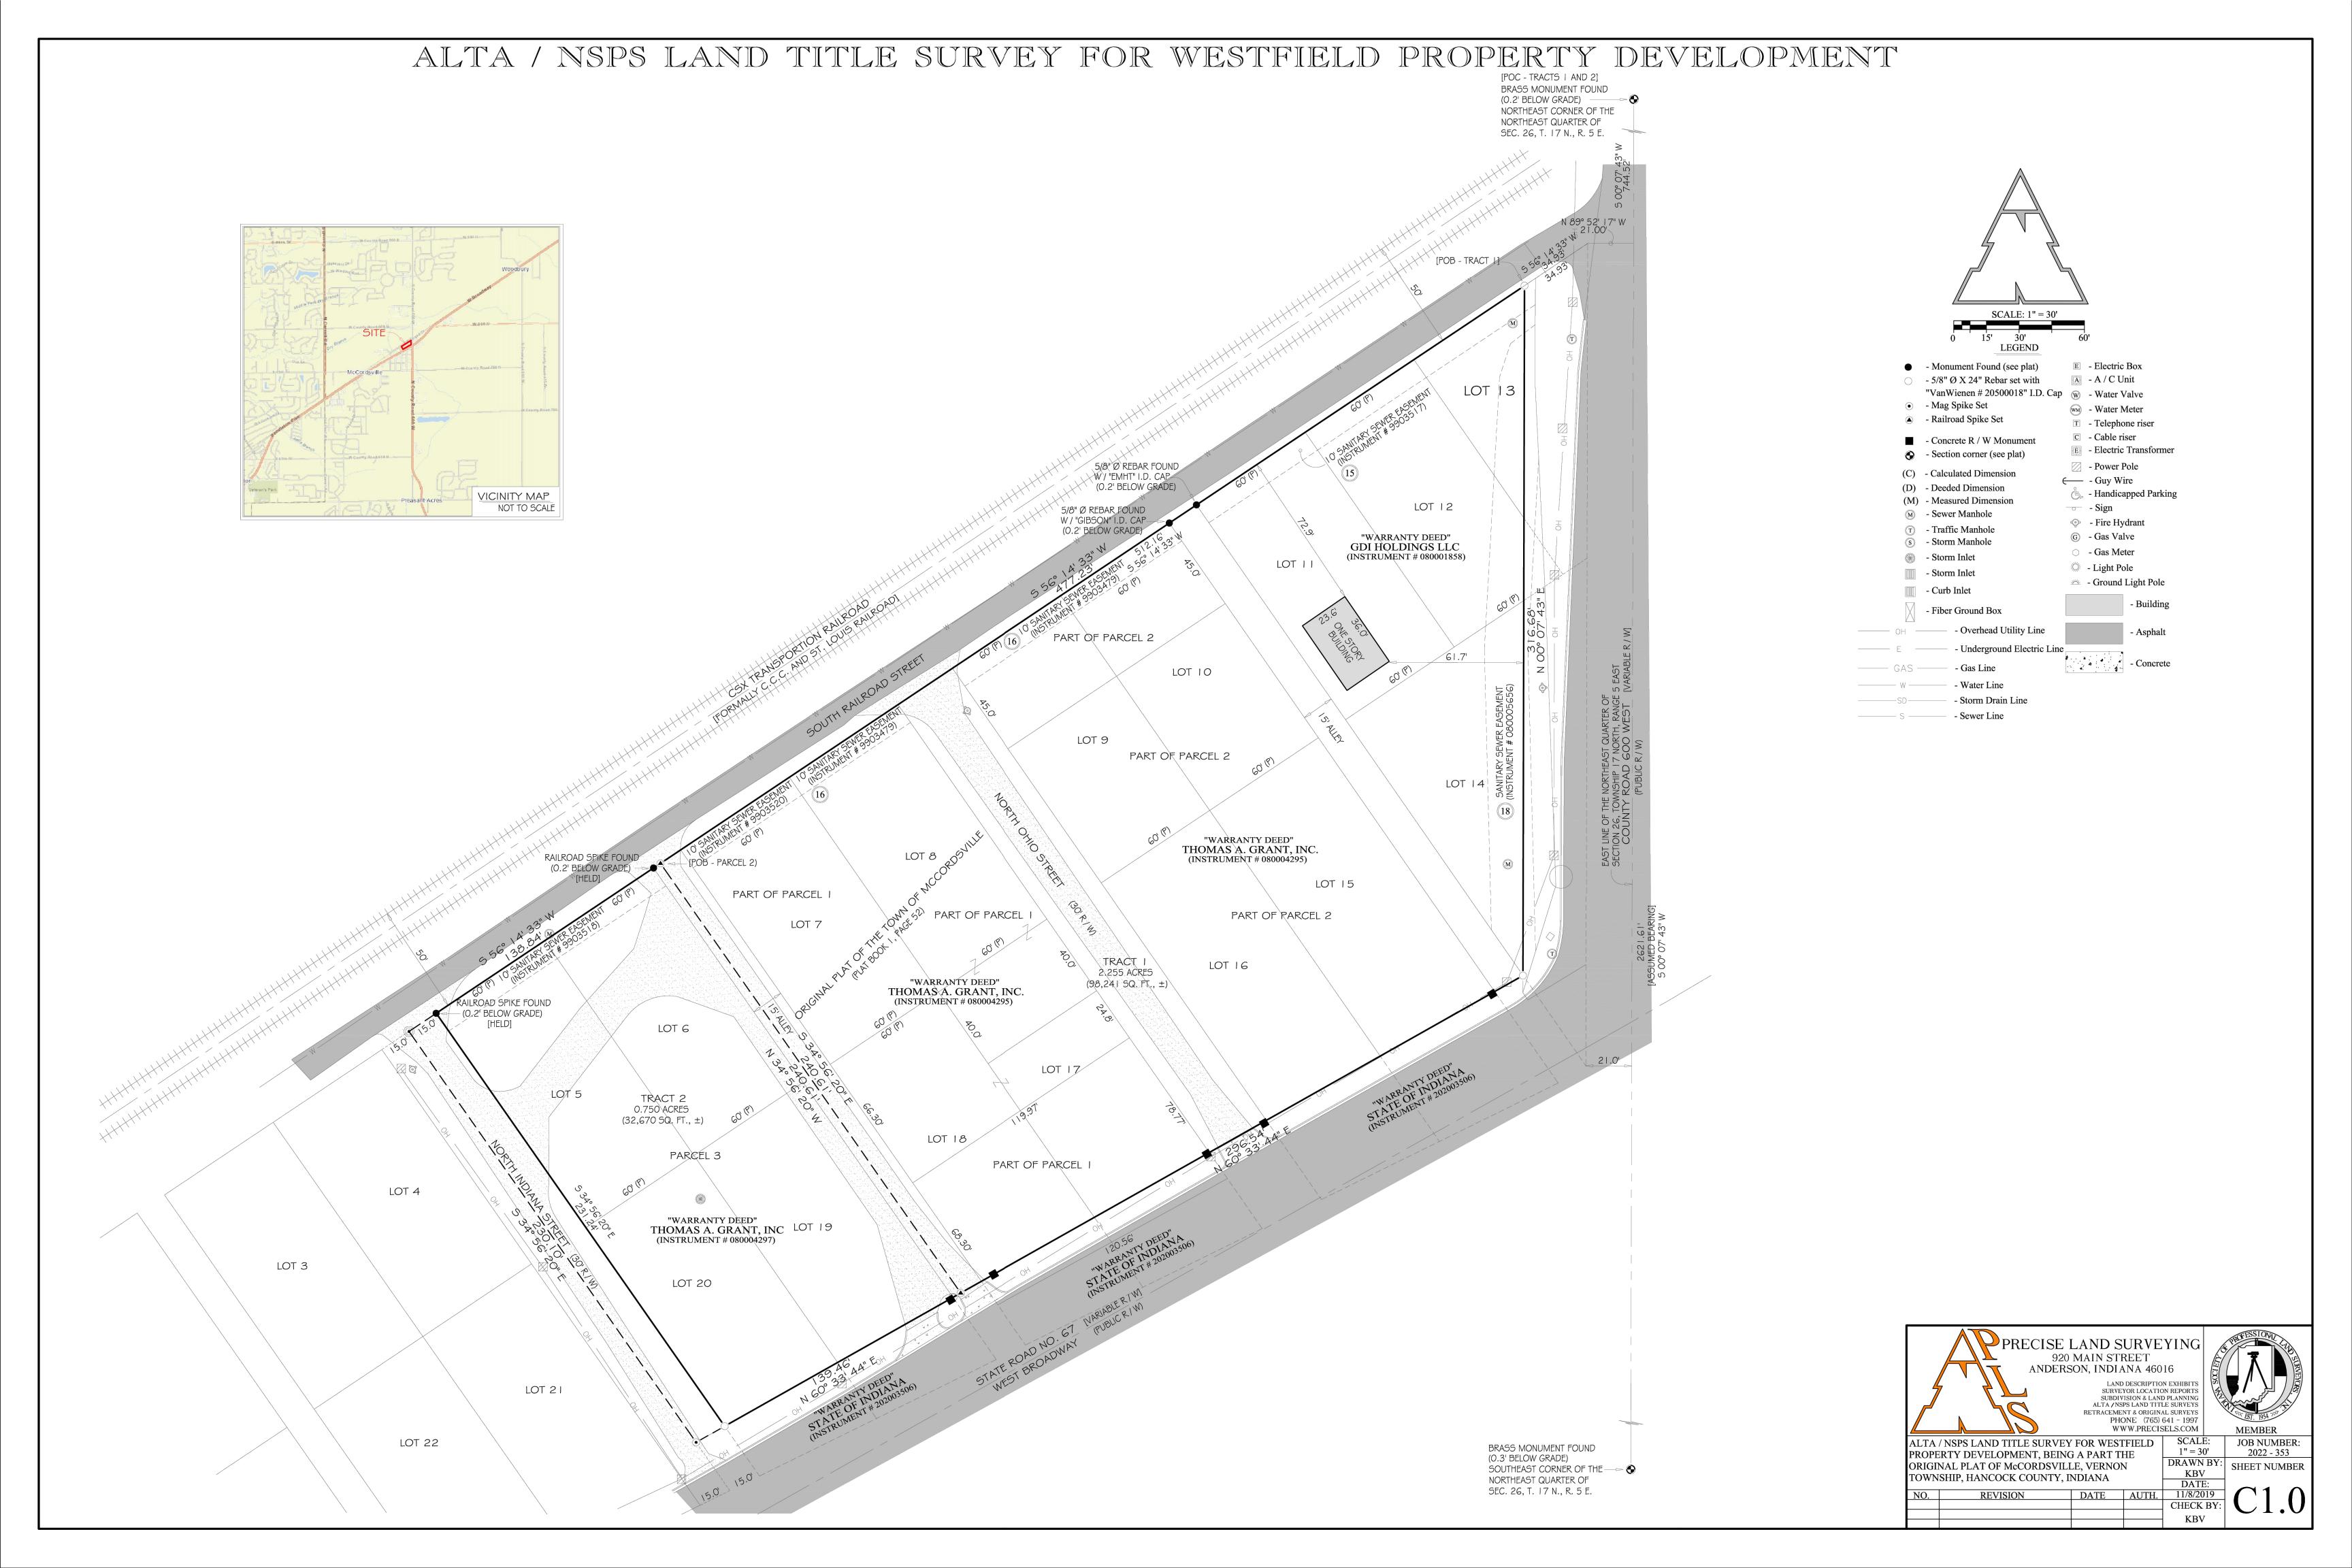

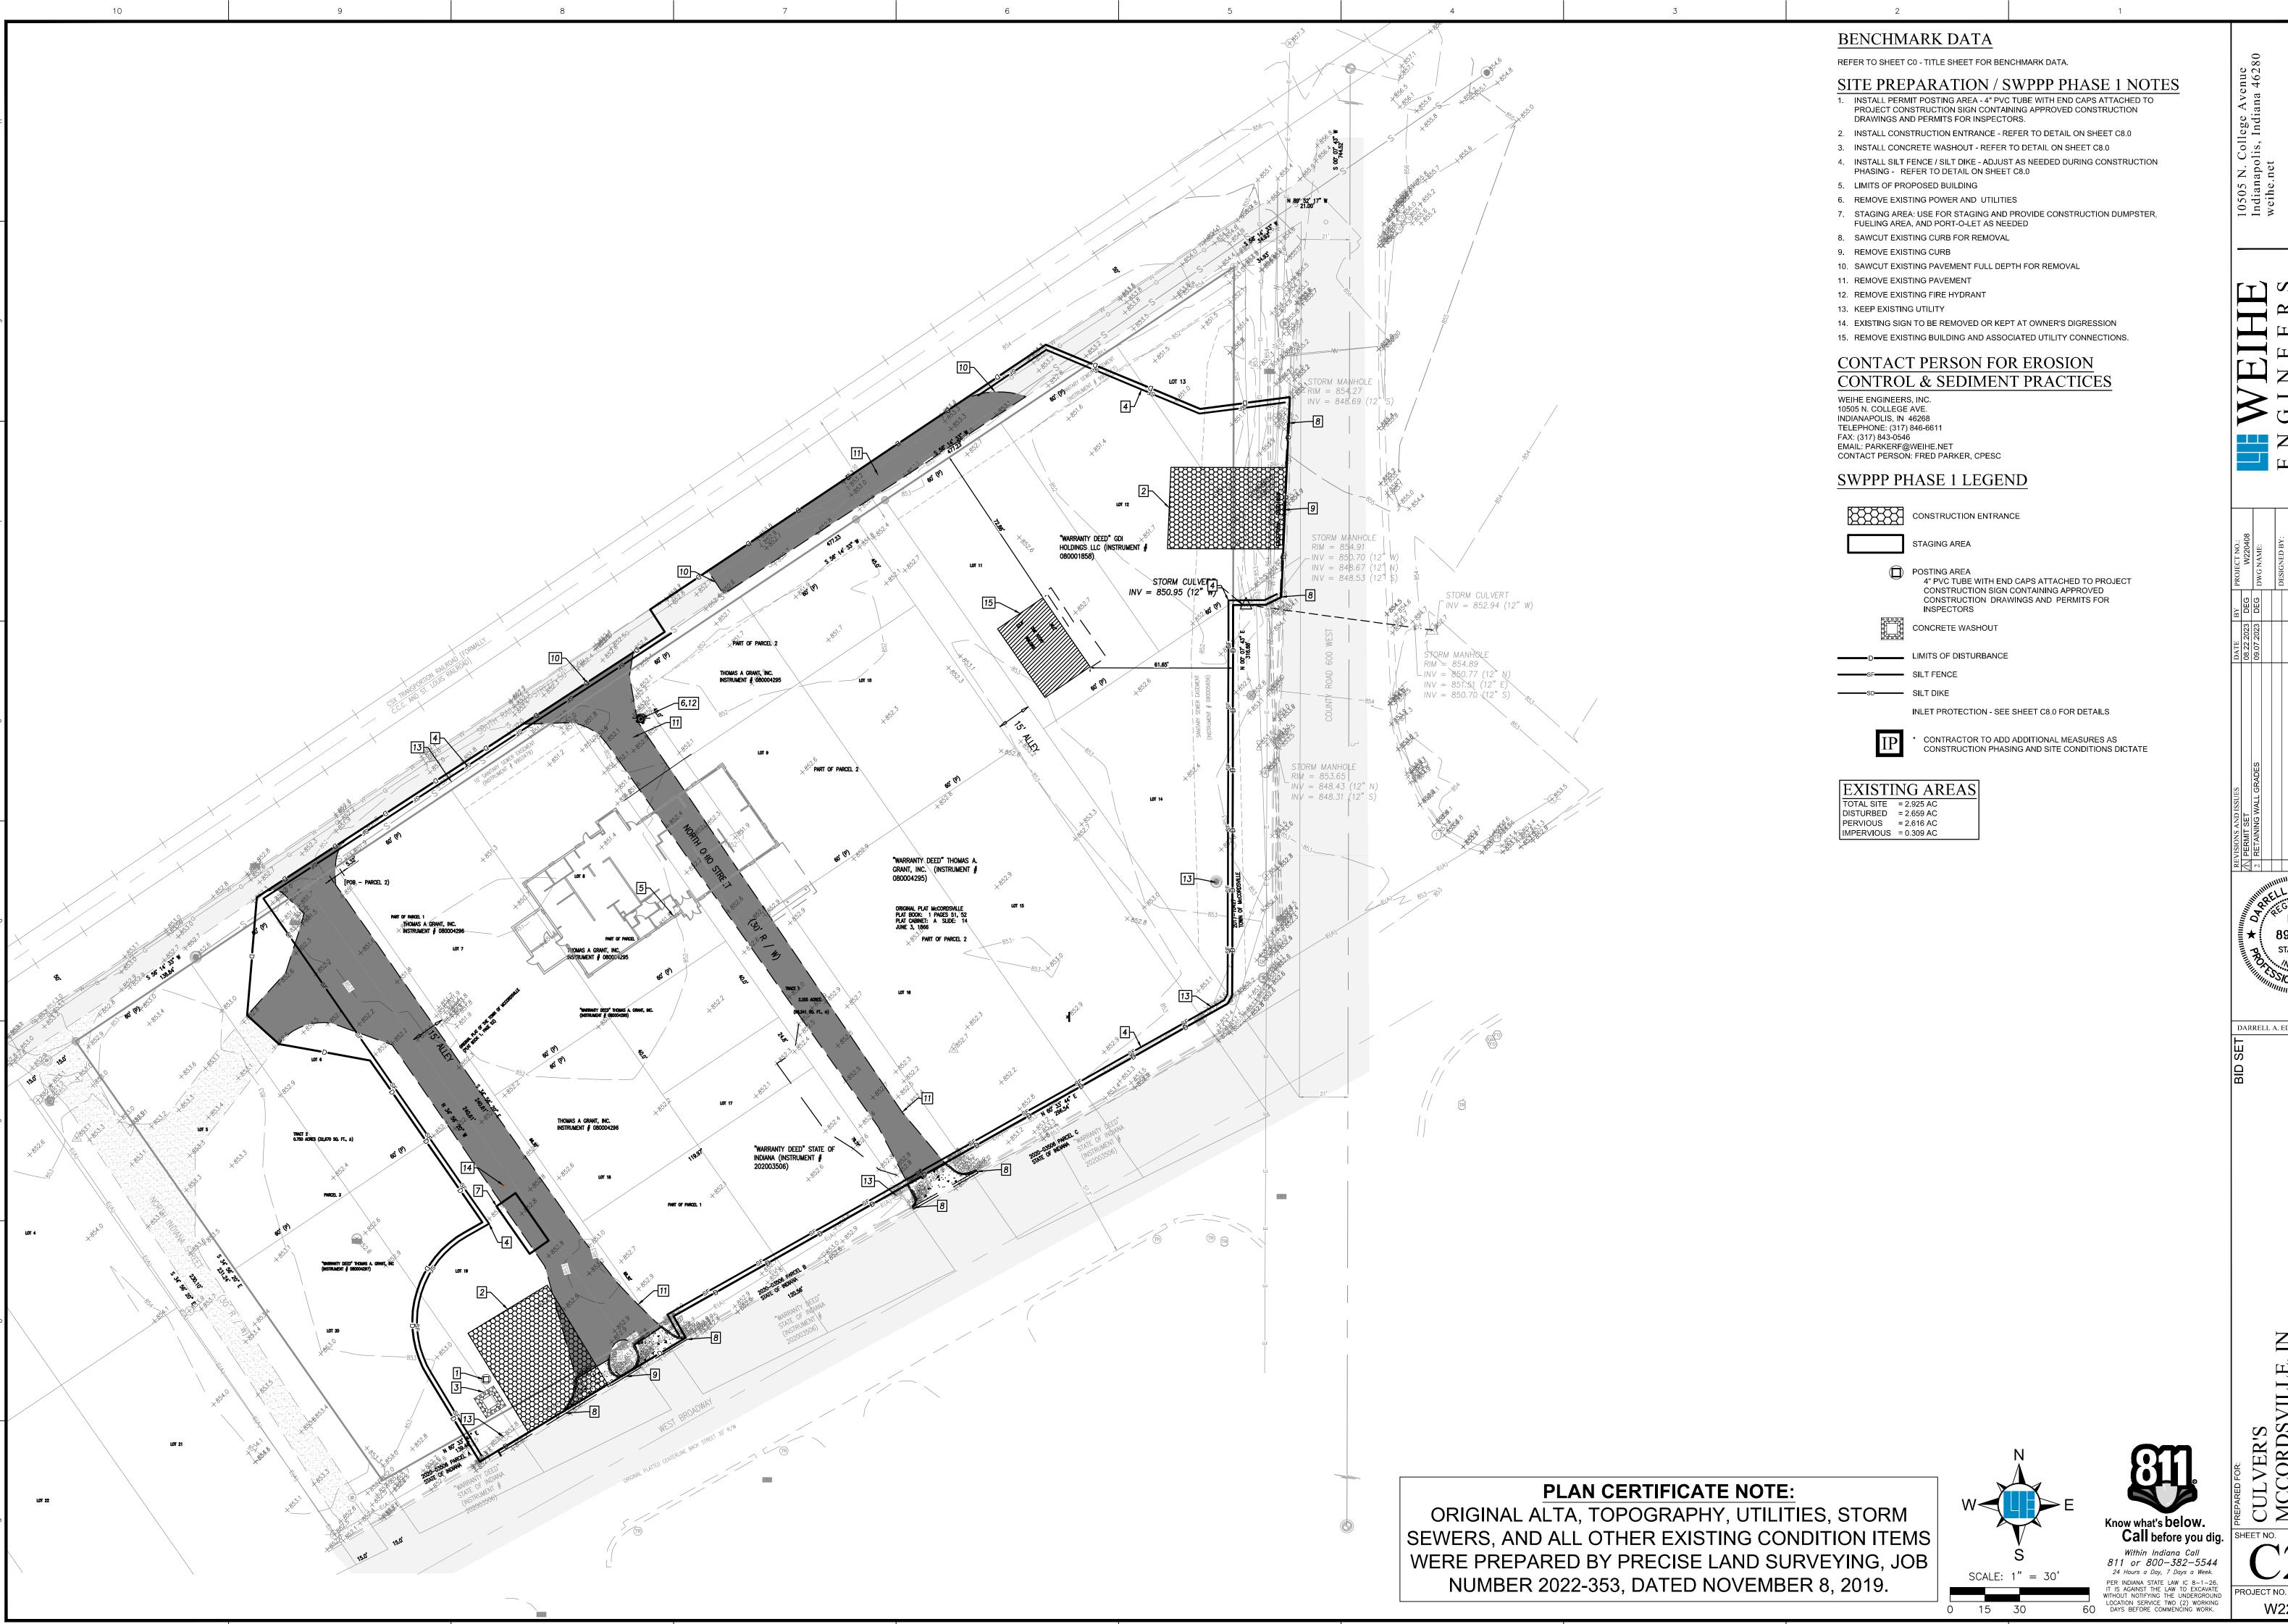


317 | 846 - (800 | 452 - (317 | 843 - (

W22.0408

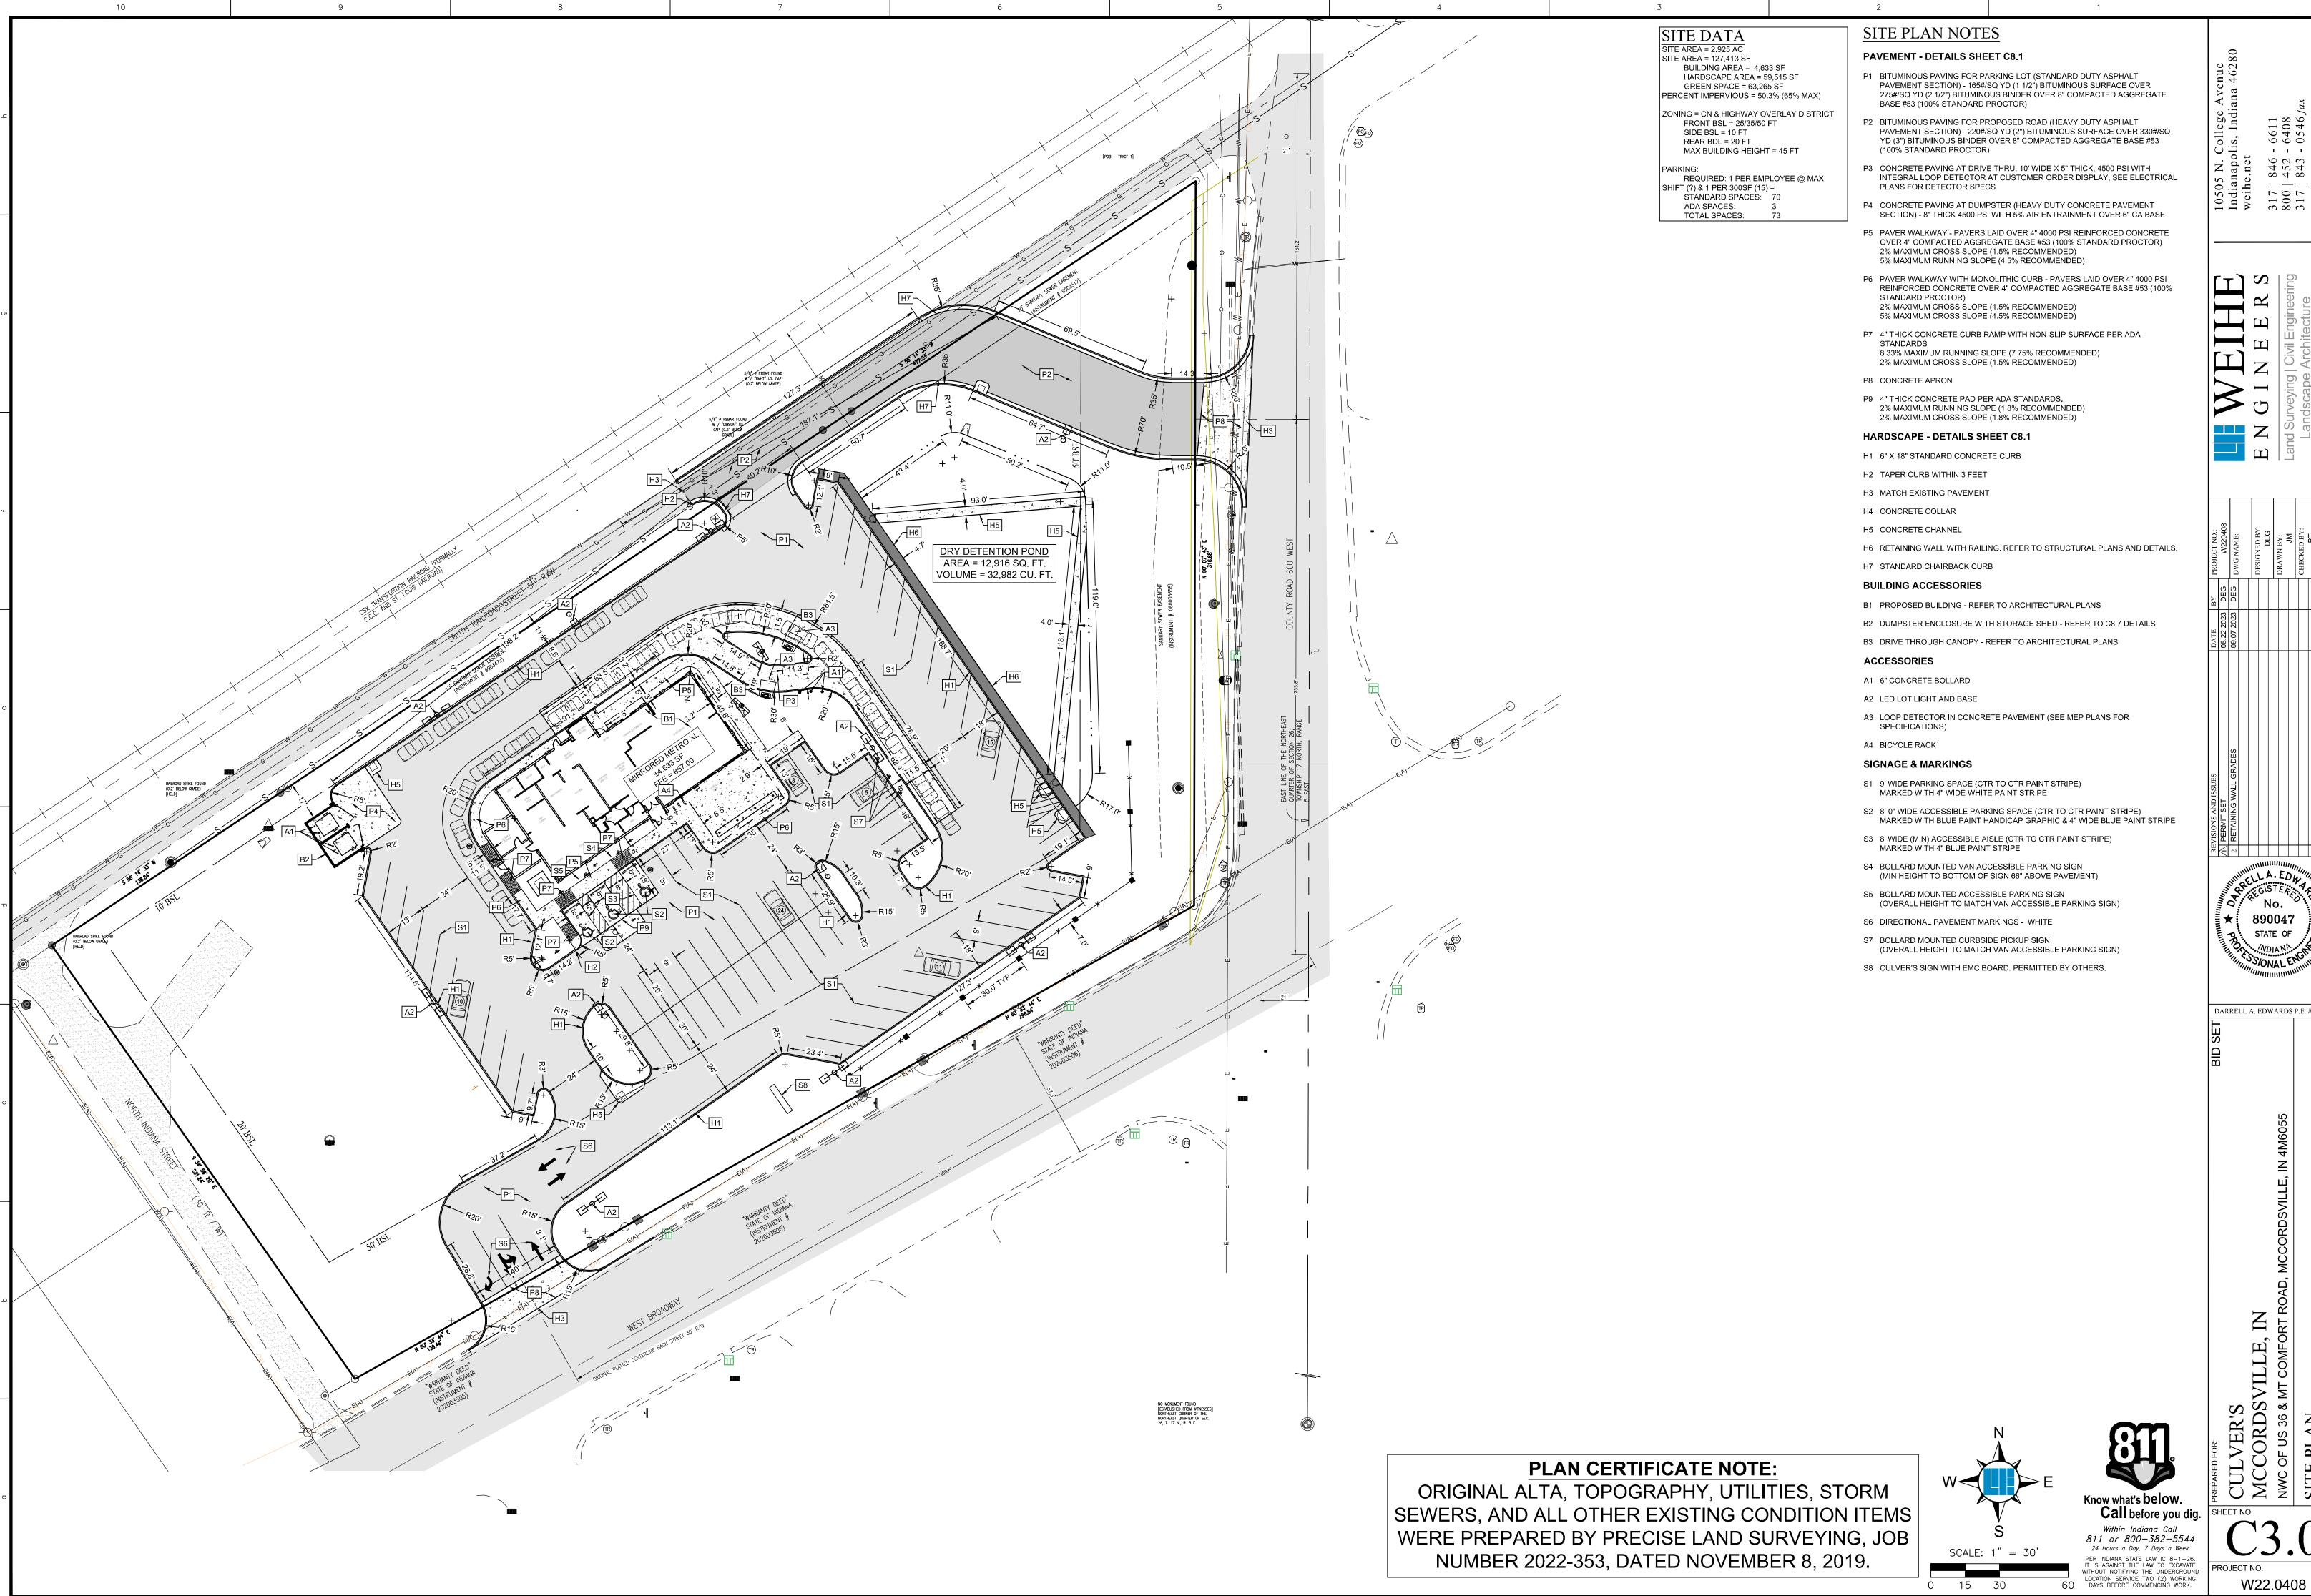

846 452 843

DARRELL A. EDWARDS P.E. #89004

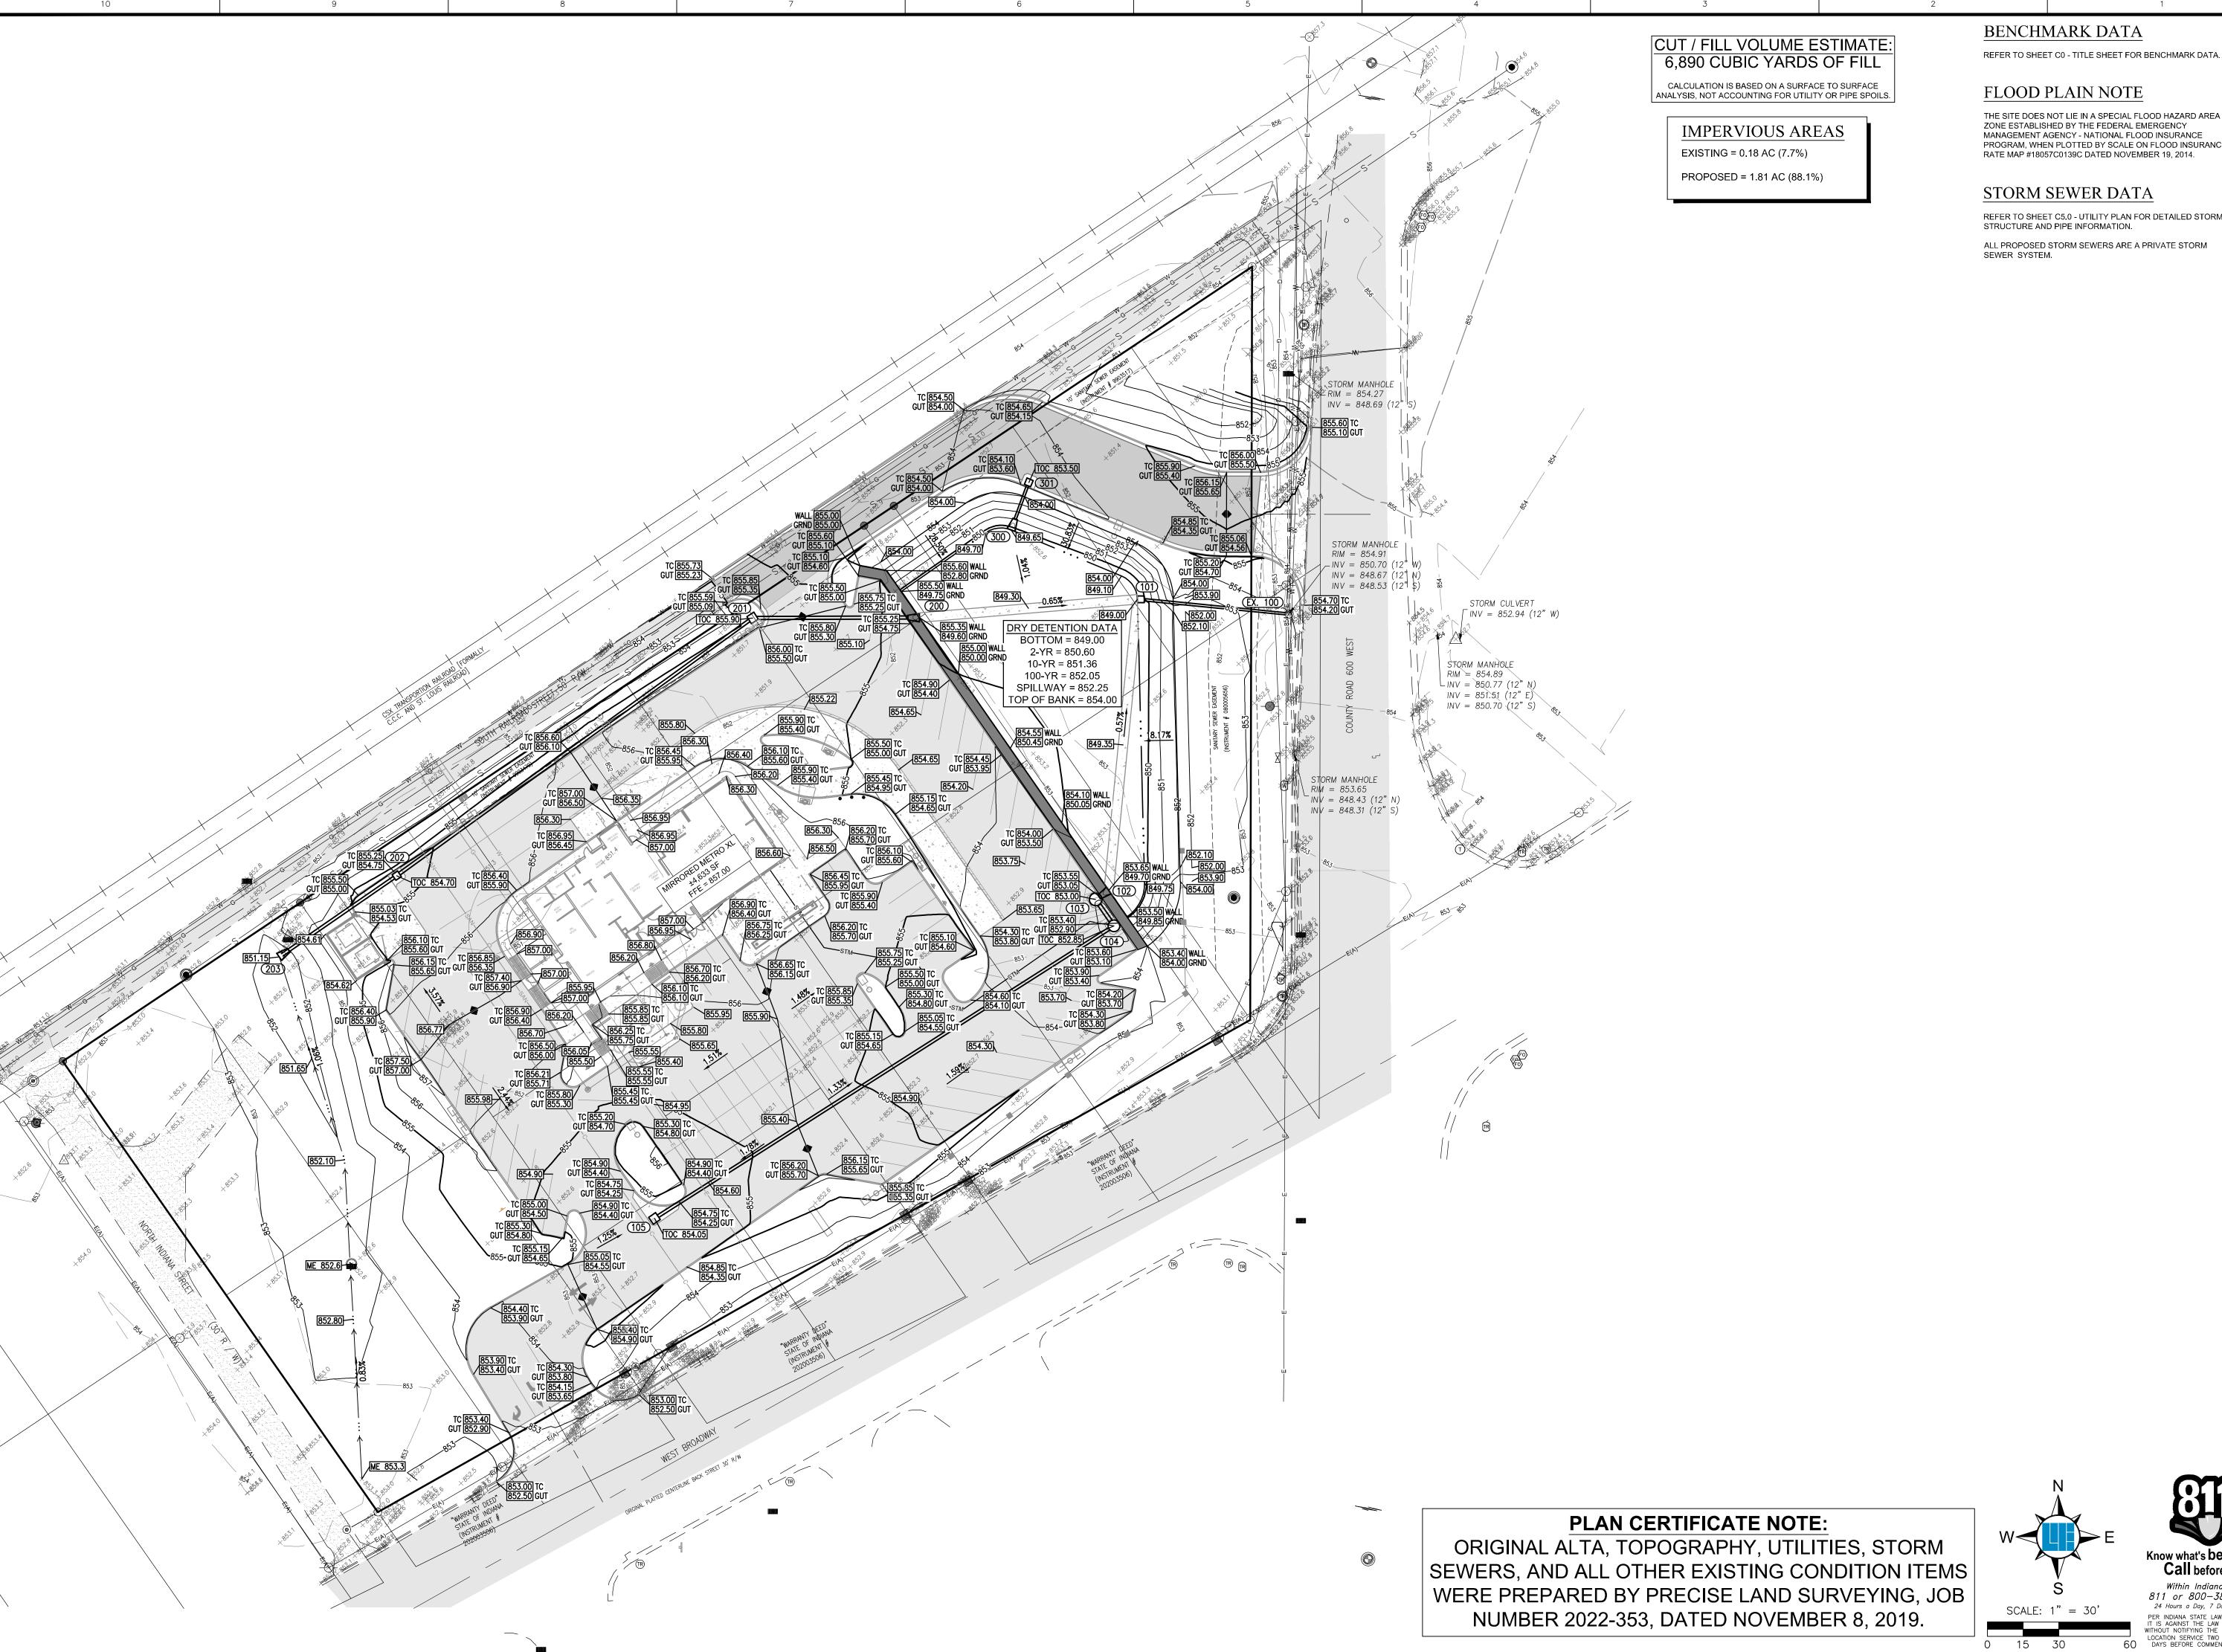

BENCHMARK DATA

FLOOD PLAIN NOTE

THE SITE DOES NOT LIE IN A SPECIAL FLOOD HAZARD AREA ZONE ESTABLISHED BY THE FEDERAL EMERGENCY MANAGEMENT AGENCY - NATIONAL FLOOD INSURANCE PROGRAM, WHEN PLOTTED BY SCALE ON FLOOD INSURANCE RATE MAP #18057C0139C DATED NOVEMBER 19, 2014.

STORM SEWER DATA

REFER TO SHEET C5.0 - UTILITY PLAN FOR DETAILED STORM STRUCTURE AND PIPE INFORMATION.


ALL PROPOSED STORM SEWERS ARE A PRIVATE STORM SEWER SYSTEM.

317 | 846 - 6 800 | 452 - 6 317 | 843 - 6

Know what's below.

Call before you dig. Within Indiana Call 811 or 800—382—5544 24 Hours a Day, 7 Days a Week.

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SS1 CONNECT PROPOSED 6" [SDR-35 PVC] SANITARY SEWER LATERAL TO EXISTING SANITARY SEWER 8" MAIN. COORDINATE CONNECTION WITH MEP. PROVIDE CLEANOUTS AS REQUIRED/SHOWN. VERIFY INVERTS ON EXISTING LINE AND

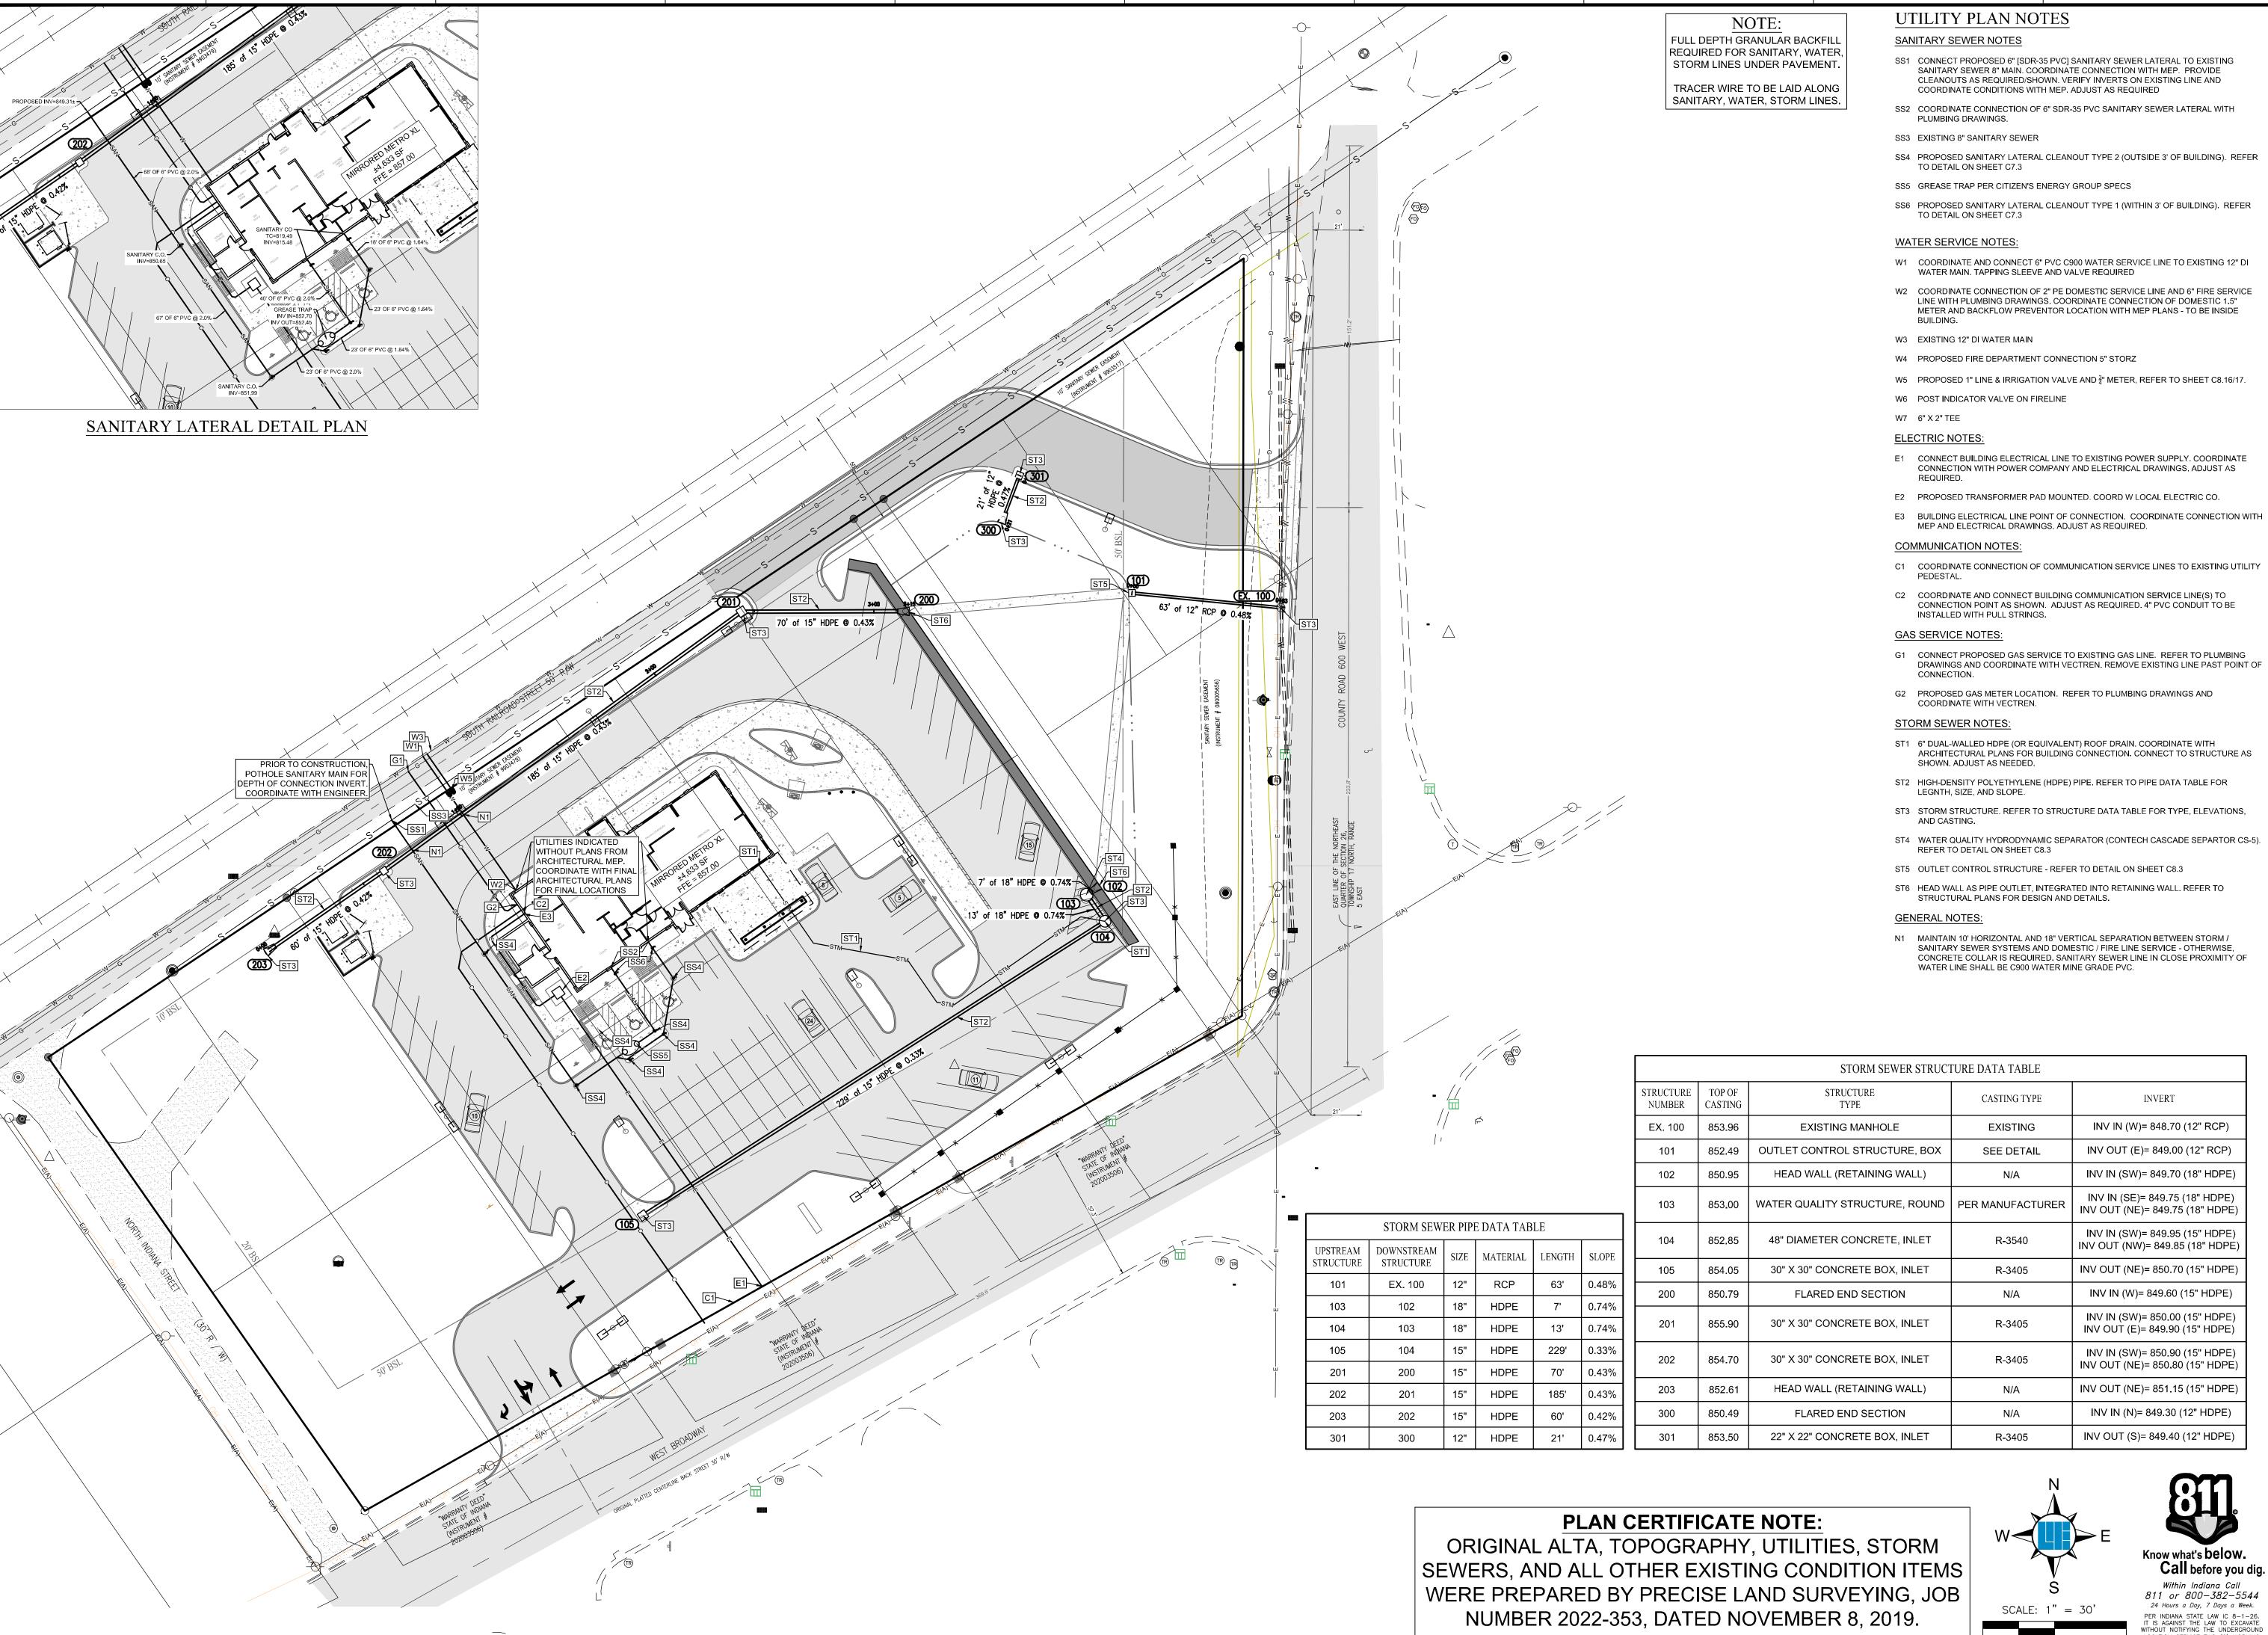SS2 COORDINATE CONNECTION OF 6" SDR-35 PVC SANITARY SEWER LATERAL WITH

SS4 PROPOSED SANITARY LATERAL CLEANOUT TYPE 2 (OUTSIDE 3' OF BUILDING). REFER

SS6 PROPOSED SANITARY LATERAL CLEANOUT TYPE 1 (WITHIN 3' OF BUILDING). REFER

W1 COORDINATE AND CONNECT 6" PVC C900 WATER SERVICE LINE TO EXISTING 12" DI

W2 COORDINATE CONNECTION OF 2" PE DOMESTIC SERVICE LINE AND 6" FIRE SERVICE LINE WITH PLUMBING DRAWINGS. COORDINATE CONNECTION OF DOMESTIC 1.5" METER AND BACKFLOW PREVENTOR LOCATION WITH MEP PLANS - TO BE INSIDE

W5 PROPOSED 1" LINE & IRRIGATION VALVE AND \(\frac{3}{4} \)" METER, REFER TO SHEET C8.16/17.

E1 CONNECT BUILDING ELECTRICAL LINE TO EXISTING POWER SUPPLY. COORDINATE CONNECTION WITH POWER COMPANY AND ELECTRICAL DRAWINGS. ADJUST AS

E2 PROPOSED TRANSFORMER PAD MOUNTED. COORD W LOCAL ELECTRIC CO.

C1 COORDINATE CONNECTION OF COMMUNICATION SERVICE LINES TO EXISTING UTILITY

CONNECTION POINT AS SHOWN. ADJUST AS REQUIRED. 4" PVC CONDUIT TO BE

DRAWINGS AND COORDINATE WITH VECTREN. REMOVE EXISTING LINE PAST POINT OF

ST1 6" DUAL-WALLED HDPE (OR EQUIVALENT) ROOF DRAIN. COORDINATE WITH ARCHITECTURAL PLANS FOR BUILDING CONNECTION. CONNECT TO STRUCTURE AS

ST2 HIGH-DENSITY POLYETHYLENE (HDPE) PIPE. REFER TO PIPE DATA TABLE FOR

ST3 STORM STRUCTURE. REFER TO STRUCTURE DATA TABLE FOR TYPE, ELEVATIONS,

ST4 WATER QUALITY HYDRODYNAMIC SEPARATOR (CONTECH CASCADE SEPARTOR CS-5).

ST5 OUTLET CONTROL STRUCTURE - REFER TO DETAIL ON SHEET C8.3

ST6 HEAD WALL AS PIPE OUTLET, INTEGRATED INTO RETAINING WALL. REFER TO

N1 MAINTAIN 10' HORIZONTAL AND 18" VERTICAL SEPARATION BETWEEN STORM / SANITARY SEWER SYSTEMS AND DOMESTIC / FIRE LINE SERVICE - OTHERWISE, CONCRETE COLLAR IS REQUIRED. SANITARY SEWER LINE IN CLOSE PROXIMITY OF

INVERT INV IN (W)= 848.70 (12" RCP) INV OUT (E)= 849.00 (12" RCP) INV IN (SW)= 849.70 (18" HDPE) INV IN (SE)= 849.75 (18" HDPE) INV OUT (NE)= 849.75 (18" HDPE INV IN (SW)= 849.95 (15" HDPE) INV OUT (NW)= 849.85 (18" HDPE INV OUT (NE)= 850.70 (15" HDPE INV IN (W)= 849.60 (15" HDPE) INV IN (SW)= 850.00 (15" HDPE) INV OUT (E)= 849.90 (15" HDPE) INV IN (SW)= 850.90 (15" HDPE) INV OUT (NE)= 850.80 (15" HDPE INV OUT (NE)= 851.15 (15" HDPE INV IN (N)= 849.30 (12" HDPE) INV OUT (S)= 849.40 (12" HDPE)

15 30

Know what's below.


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SHEET NO. 811 or 800-382-5544 24 Hours a Day, 7 Days a Week. PER INDIANA STATE LAW IC 8-1-26. IT IS AGAINST THE LAW TO EXCAVATE WITHOUT NOTIFYING THE UNDERGROUND

890047

DARRELL A. EDWARDS P.E. #89004


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DARRELL A. EDWARDS P.E. #8900

W22.0408

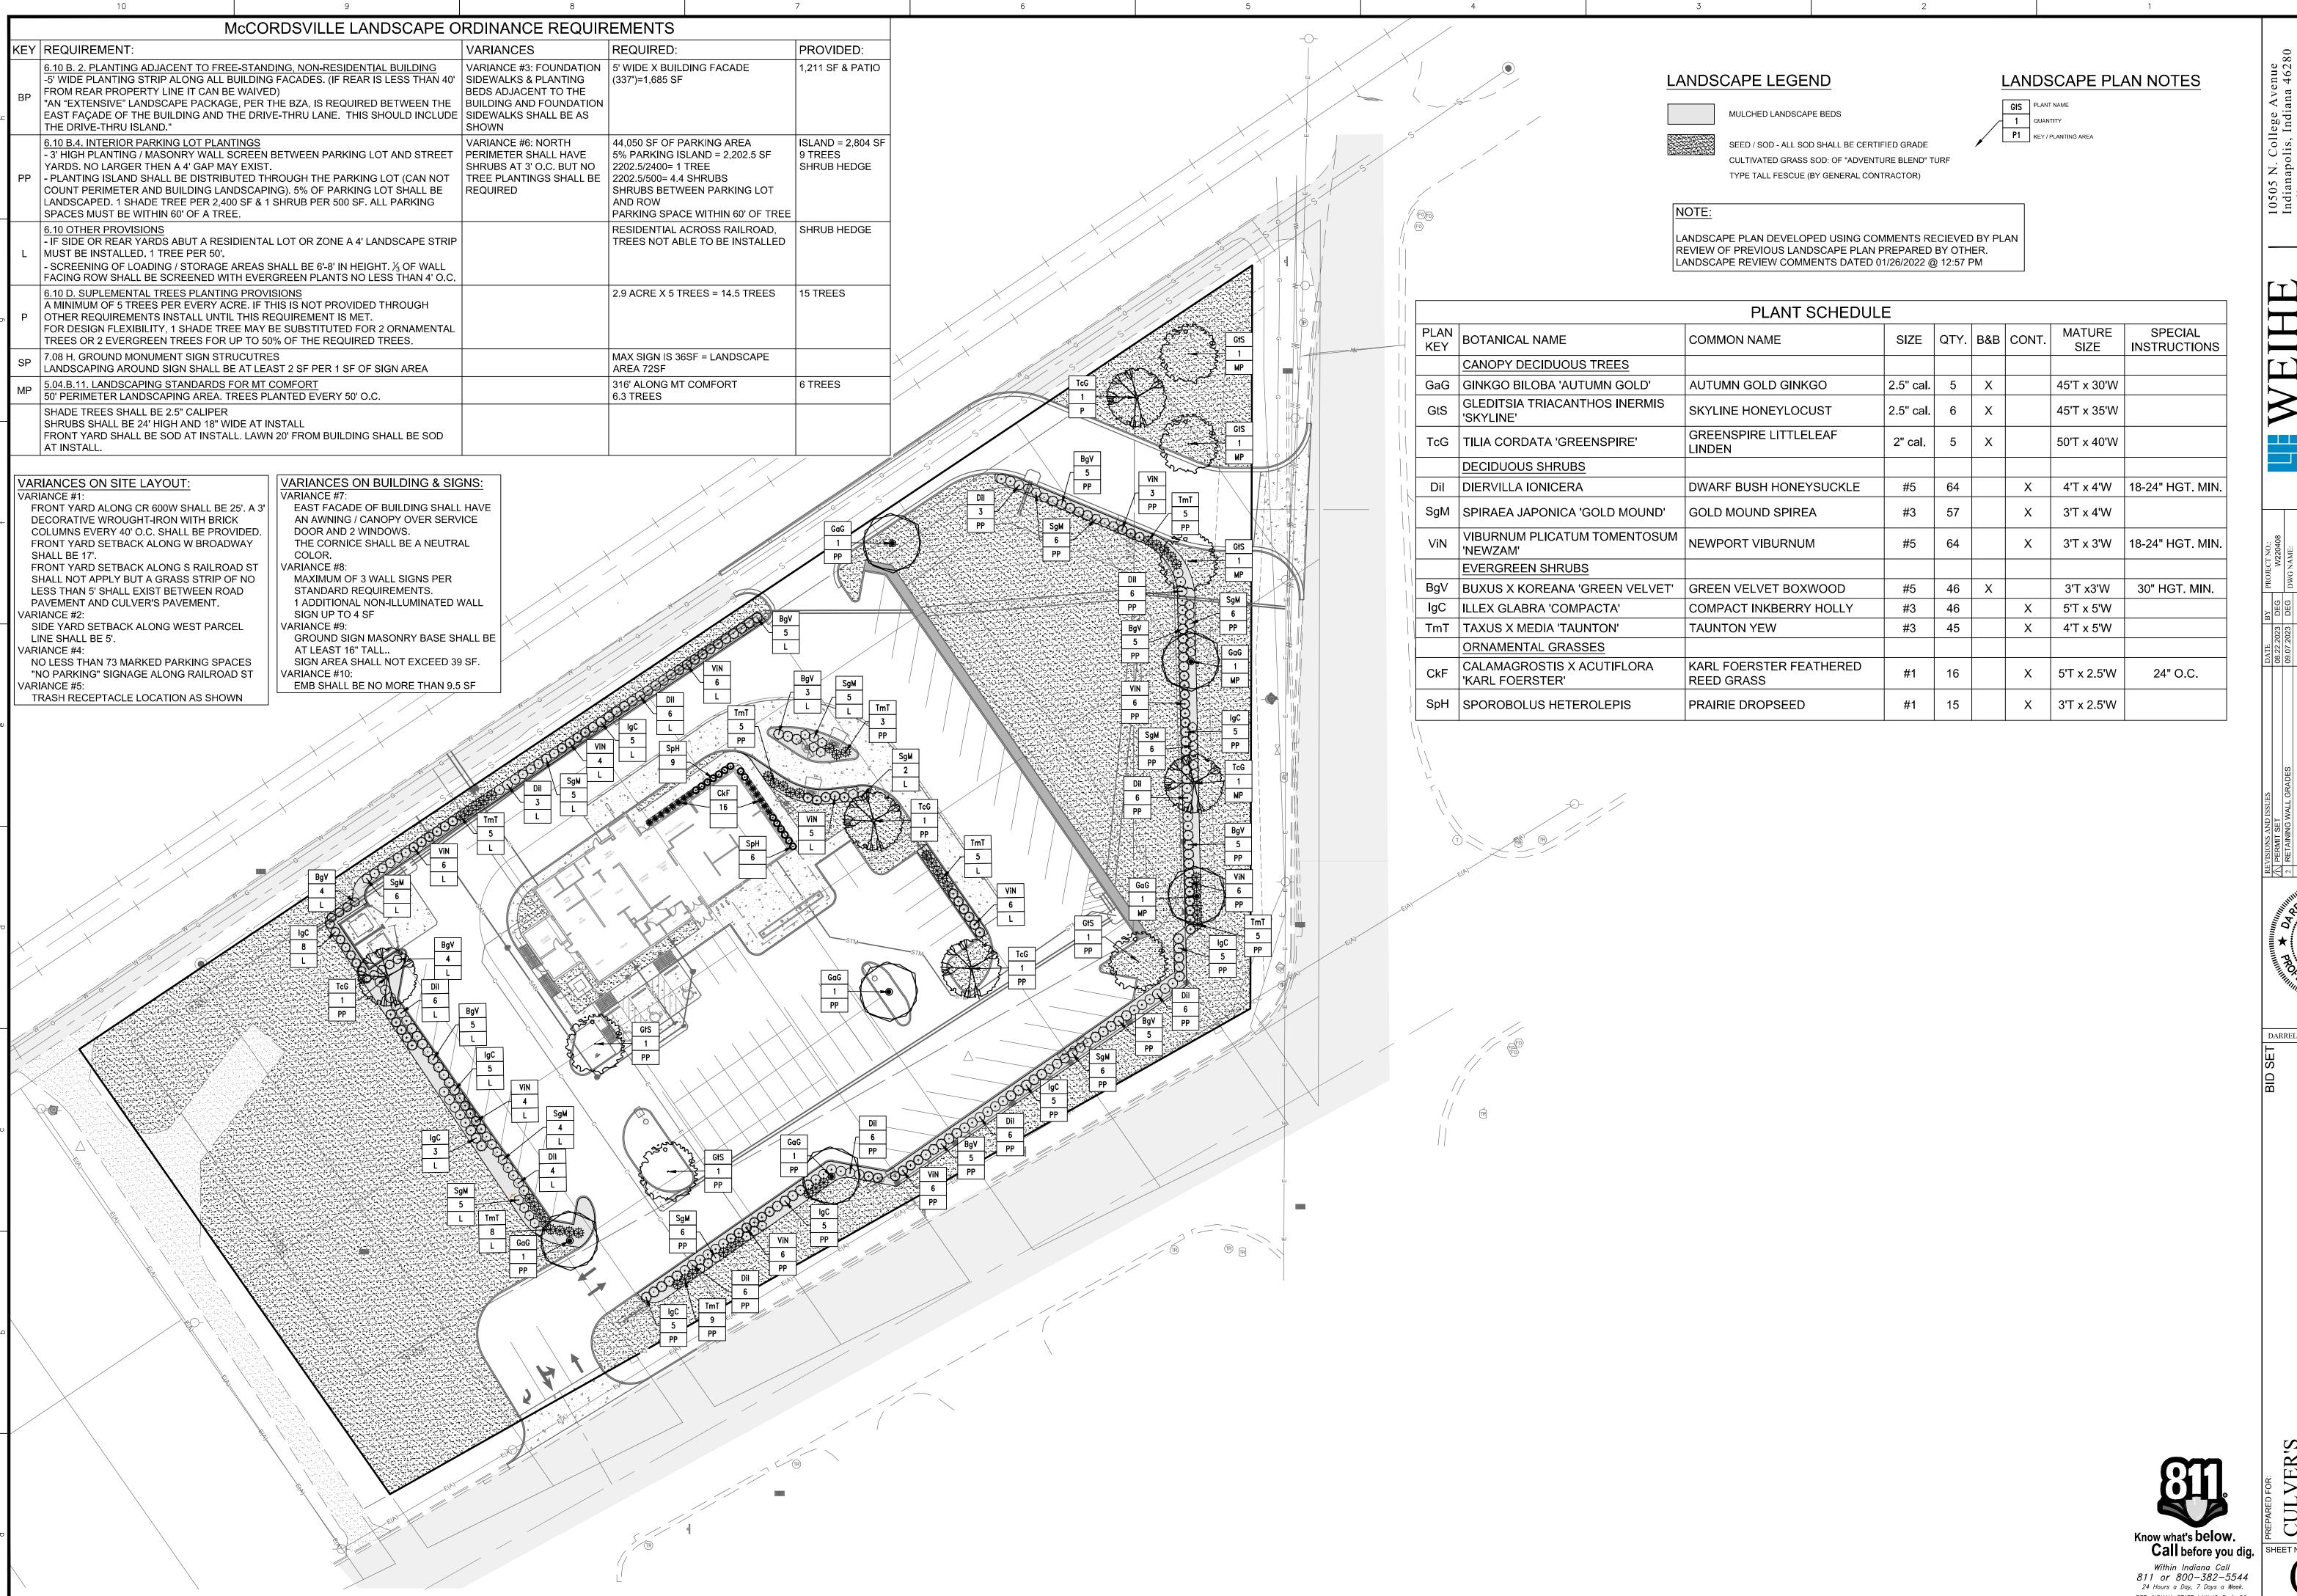PER INDIANA STATE LAW IC 8-1-26. IT IS AGAINST THE LAW TO EXCAVATE WITHOUT NOTIFYING THE UNDERGROUND LOCATION SERVICE TWO (2) WORKING DAYS BEFORE COMMENCING WORK.



Luminaire Schedule								
Symbol	Qty	Label	Arrangement	Lum. Lumens	LLF	Lum. Watts	Description	
	1	X-S4-2	Single	12311	0.900	86	MRS-LED-12L-SIL-FT-50-70CRI	
	1	X-S4-IL	Single	27941	0.900	354	MRM-LED-42L-SIL-FT-50-70CRI-IL	
<u> </u>	5	X-D4-LR-IL	Twin	27941	0.900	354	MRM-LED-42L-SIL-FT-L-R-50-70CRI-IL	
	2	X-D4-LR	Twin	44130	0.900	354	MRM-LED-42L-SIL-FT-L-R-50-70CRI	
	2	X-S4	Single	44130	0.900	354	MRM-LED-42L-SIL-FT-50-70CRI	

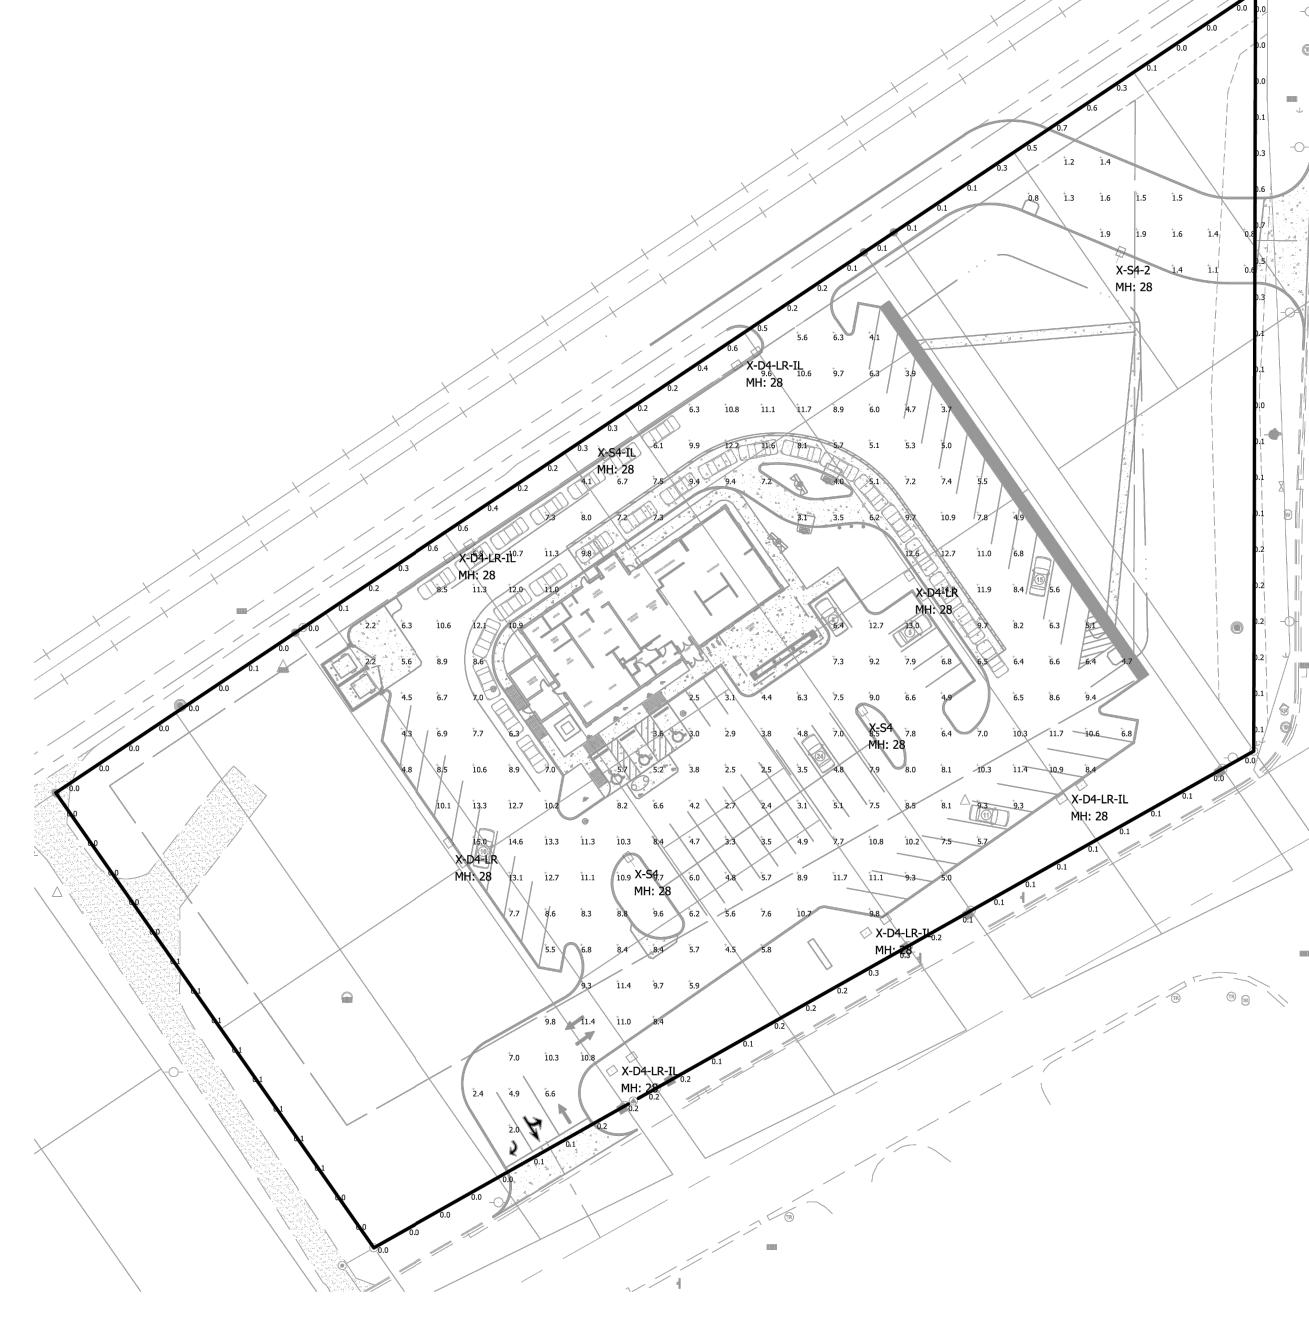Calculation Summary							
Label	CalcType	Units	Avg	Max	Min	Avg/Min	Max/Min
_Property Line	Illuminance	Fc	0.16	0.7	0.0	N.A.	N.A.
Acess Drive	Illuminance	Fc	1.33	1.9	0.6	2.22	3.17
Paved Areas & Drives	Illuminance	Fc	7.69	15.0	2.0	3.85	7.50



LIGHTING NOTES:

- Mounting Height = 25' Poles / 3' Base
- Light Loss Factor = 0.90
- Footcandle Values Calculated @ Grade
- Reflectance Values 80/50/20 (office spaces) 50/30/20 (warehouse areas)

National Lighting Vendor:

For pricing and technical assistance contact: Russ Miller of CBMC INC, tel# 317-697-7510, rmiller@cbmcinc.com

All electrical work shall comply with National, State, and Local codes including and not limited to the National Electric Code, NFPA 101 Life Safety Code, ASHREA and /or IECC Energy Codes.

The information contained in this document is proprietary to CBMC Lighting Solutions. This document is prepared for a specific site and incorporates calculations based on data available from the client at this time. By accepting and using this document, the recipient agrees to protect its contents from further dissemination, (other than that within the organization necessary to evaluate such specification) without the written permission of CBMC Lighting Solutions. the contents of this document are not to be reproduced or copied in whole or in part without the written permission of CBMC Lighting Solutions. copyright © 2018 CBMC Lighting Solutions all rights reserved.



317-780-8350| WWW.CBMCINC.COM

SEE MORE

This lighting pattern represents illumination levels calculated from laboratory data taken under controlled conditions in accordance with IESNA approved methods. Actual performance of any manufacturer's luminaire may vary due to variation in electrical voltage, tolerance in lamps and LED lumen package, location adjustments, and other variable field conditions.


Contractor to check and verify all dimensions on site before commencing any work shown.

Culver's - McCordsville

SITE LAYOUT

Scale:	1" = 40'	Drawing No: LP1	
Date:	8/25/23	Project No:	
Orawn By:	SJM	CR24065-SITF-2	

CDZTUUJ JITL Z

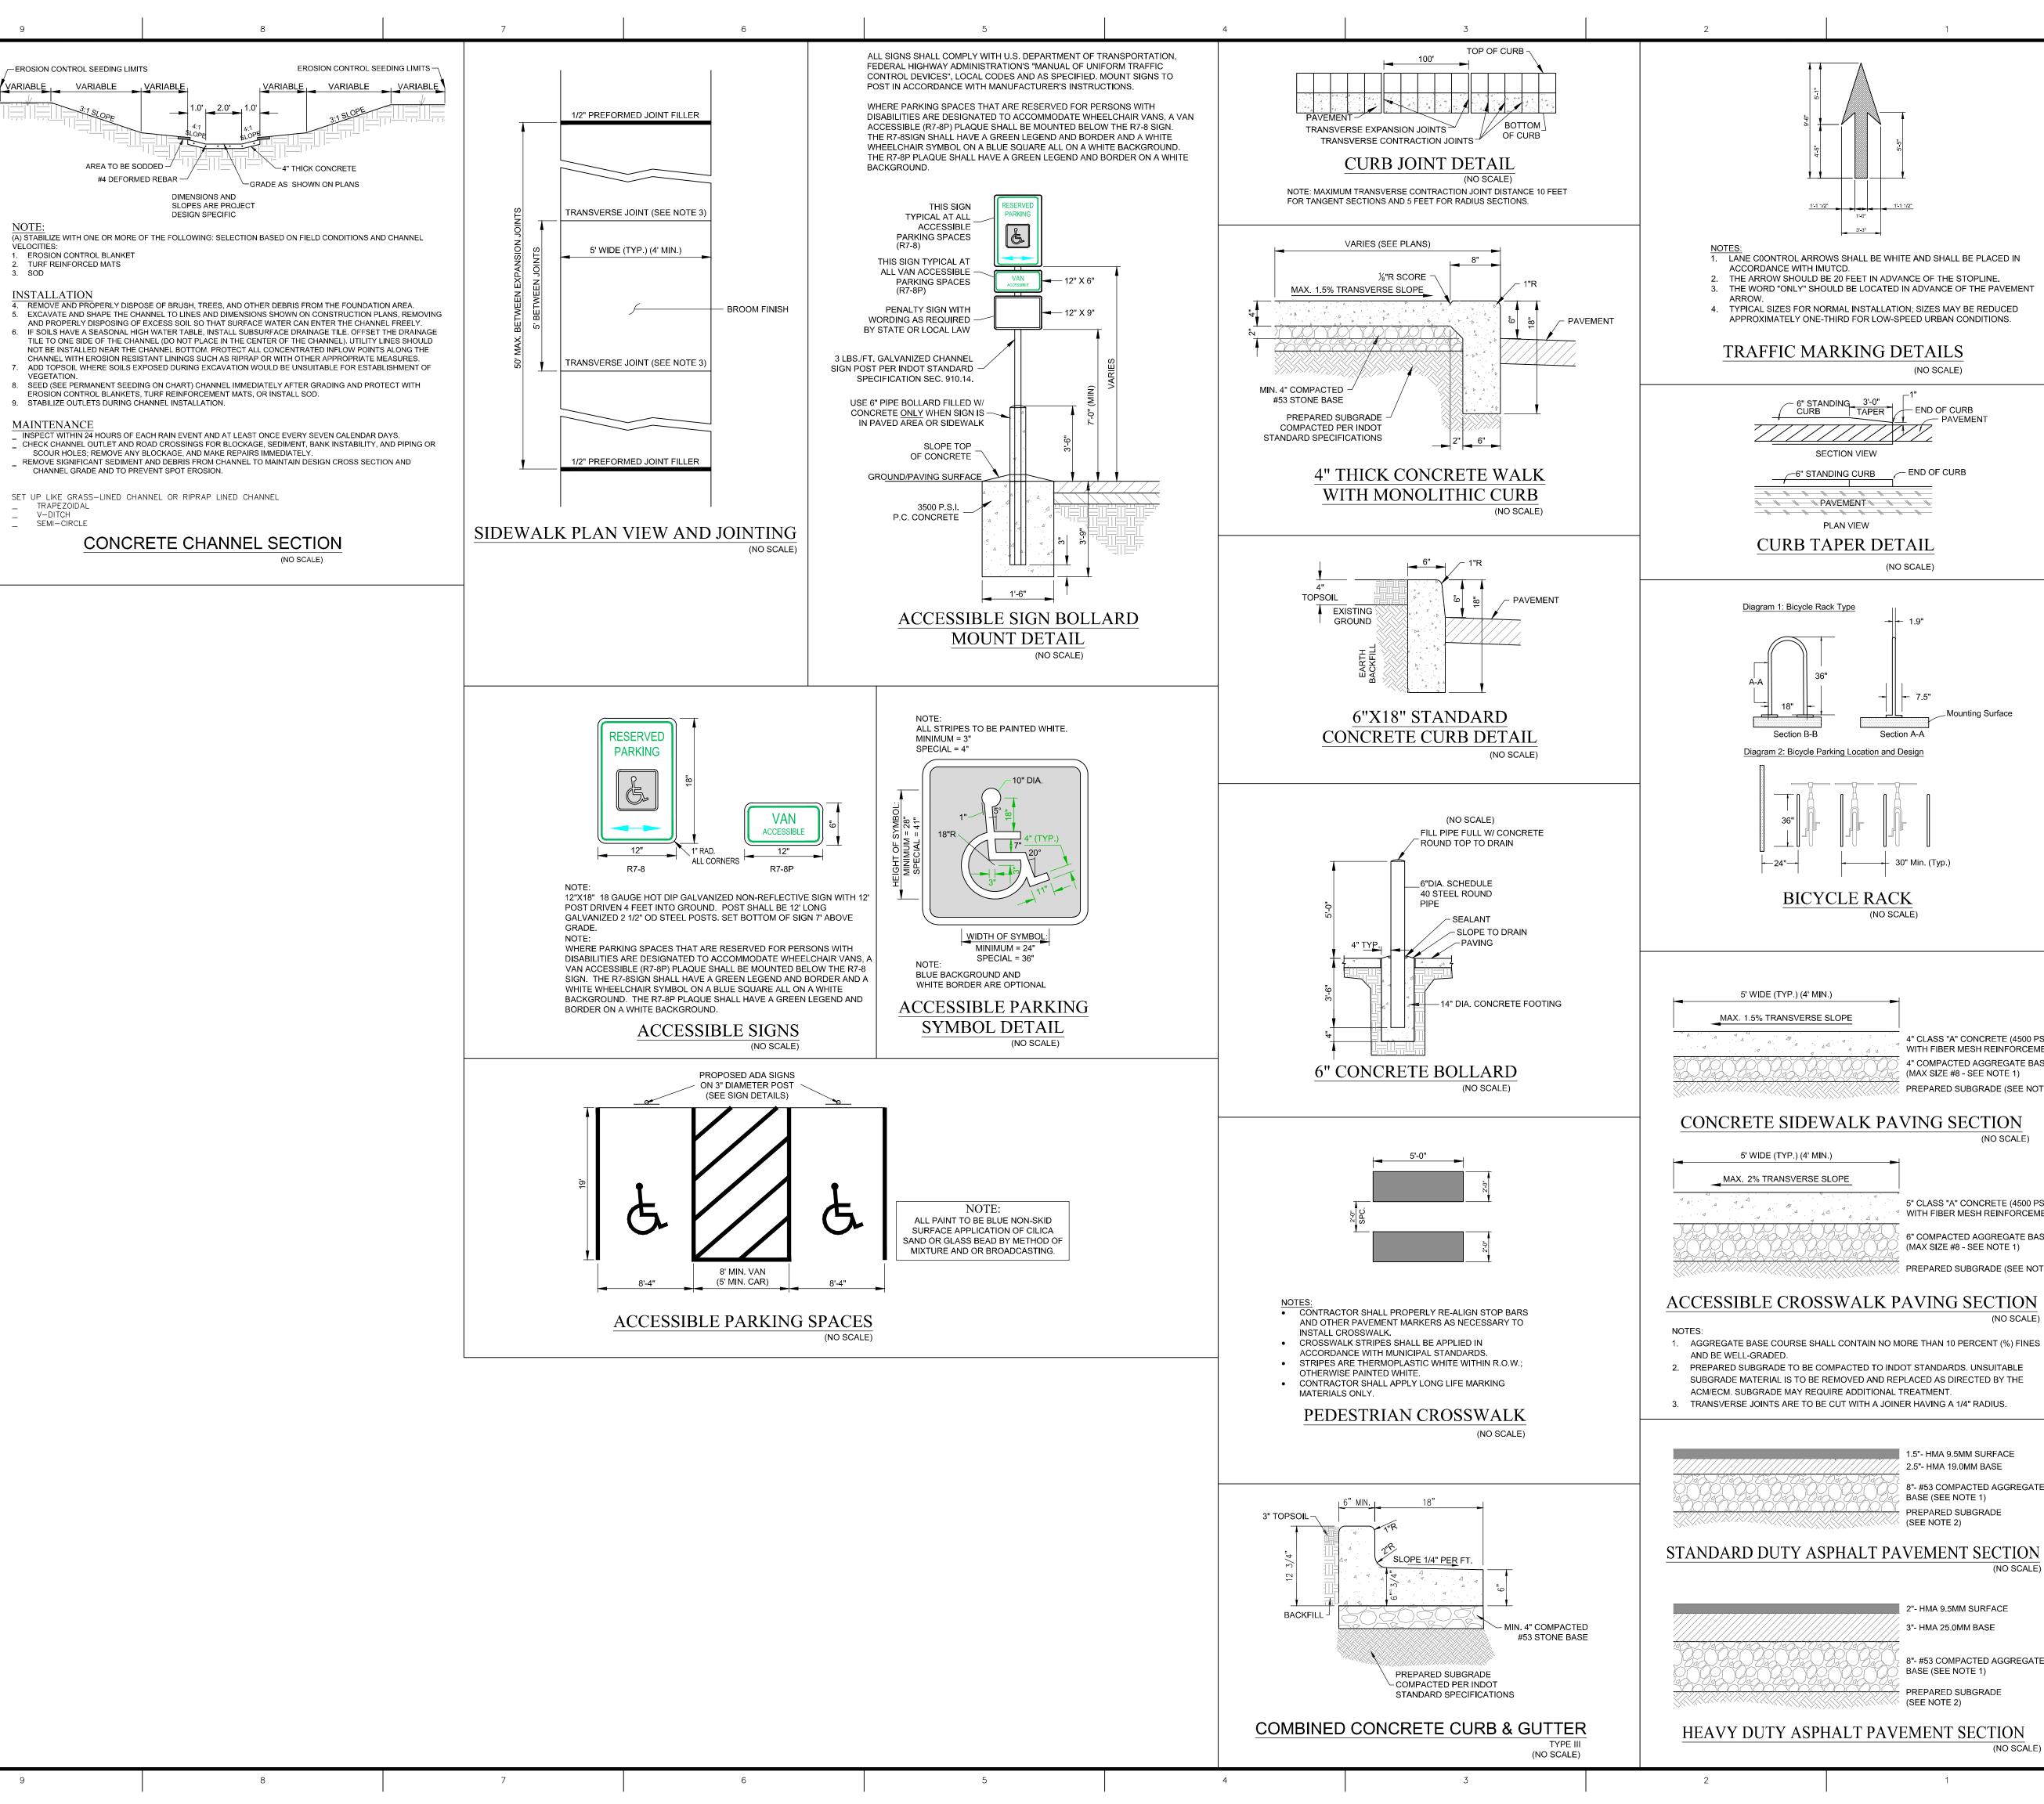

ollege is, Indi

(NO SCALE)

— END OF CURB

PAVEMENT

4" CLASS "A" CONCRETE (4500 PSI)

(MAX SIZE #8 - SEE NOTE 1)

WITH FIBER MESH REINFORCEMENT 4" COMPACTED AGGREGATE BASE

PREPARED SUBGRADE (SEE NOTE 2)

5" CLASS "A" CONCRETE (4500 PSI) WITH FIBER MESH REINFORCEMENT

6" COMPACTED AGGREGATE BASE

PREPARED SUBGRADE (SEE NOTE 2)

(MAX SIZE #8 - SEE NOTE 1)

1.5"- HMA 9.5MM SURFACE 2.5"- HMA 19.0MM BASE

BASE (SEE NOTE 1) PREPARED SUBGRADE

2"- HMA 9.5MM SURFACE

3"- HMA 25.0MM BASE

BASE (SEE NOTE 1)

(SEE NOTE 2)

PREPARED SUBGRADE

8"- #53 COMPACTED AGGREGATE

8"- #53 COMPACTED AGGREGATE

(NO SCALE)

END OF CURB

(NO SCALE)

1 1 1

846 452 843

317 800 317

890047

STATE OF

DARRELL A. EDWARDS P.E. #89004

CUL MCC NWC O SITE


W22.0408

PROJECT NO.

INSTALLATION

MAINTENANCE

TRAPEZOIDAL

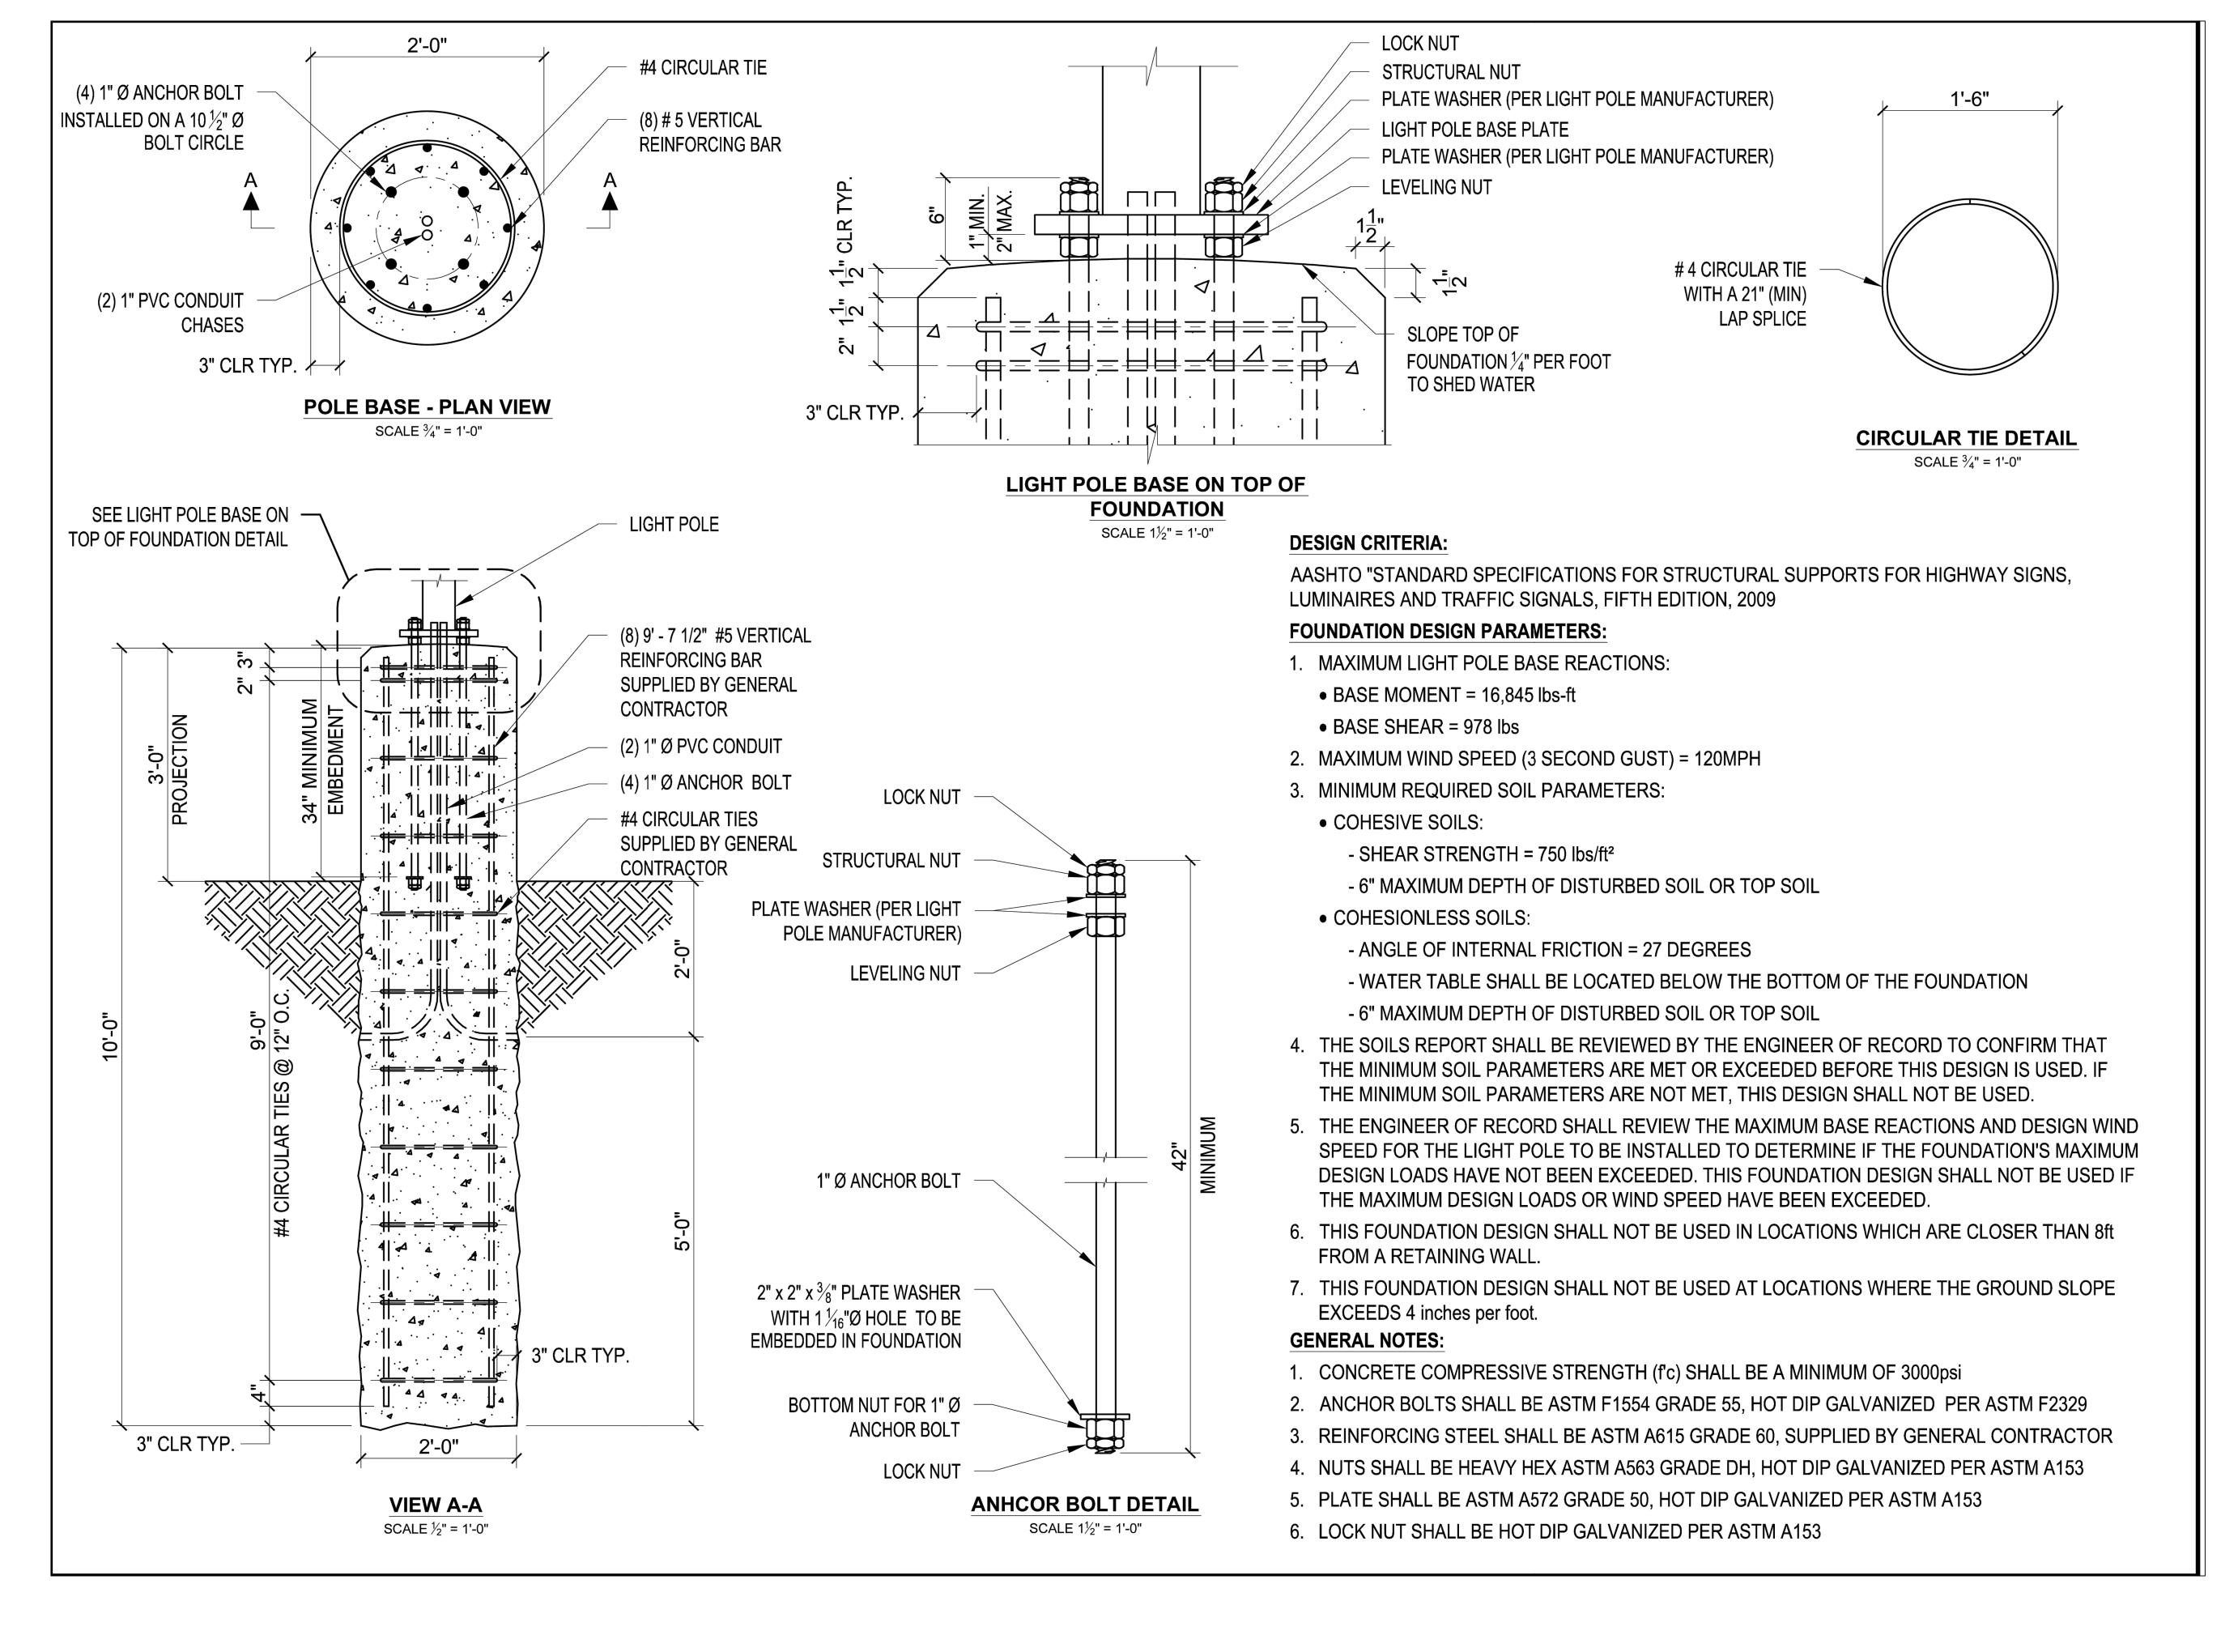

10505 N. College Avenue Indianapolis, Indiana 462 weihe.net 317 | 846 - 6611 800 | 452 - 6408 317 | 843 - 0546 fax

ENGINEERS

Land Surveying | Civil Engineering

Landscape Architecture

 SIONS AND ISSUES
 DATE
 BY
 PROJECT NO.:

 ERMIT SET
 08.22.2023
 DEG
 W220408

 ETAINING WALL GRADES
 09.07.2023
 DEG
 DWG NAME:

 DESIGNED BY:
 DEG
 DEG

 DEG
 DRAWN BY:
 JM

 STAINING WALL GRADES
 DRAWN BY:
 JM

 BT
 BT

A. EDWING No.

890047

STATE OF

WOIANA

WOIAN

DARRELL A. EDWA

SOMFORT ROAD, MCCORDSVILLE, IN 4M6055

MCC NMC OF SECOND SECON

oject no. **W22.0408**

