EOCATION MAP

SCALE 1"= 1 MILE

DEVELOPER:

CARMEL, IN 46032

HWC ENGINEERING

INDIANAPOLIS, IN 46204

keichhorn@hwcengineering.com

ZONED SUMMERTON AMENDED PUD ORDINANCE NO. ____ ORDINANCE AMENDING THE TOWN OF McCORDSVILLE ZONING

317-659-3200

(317) 347-3663

ORDINANCE NO. 121410, AS AMENDED.

DEVELOPMENT STANDARDS

AT BUILDING LINE

MAXIMUM LOT COVERAGE MAXIMUM HEIGHT - PRINCIPAL

DISTURBED AREA: 33 AC

START CONSTRUCTION: SEPTEMBER 2022 END CONSTRUCTION: SEPTEMBER 2027

PLAN COMMISSION APPROVAL

COUNTY ENGINEER APPROVAL

EROSION CONTROL APPROVAL

SITE DATA

MINIMUM FRONT YARD SETBACK MINIMUM SIDE YARD SETBACK MINIMUM REAR YARD SETBACK MINIMUM LIVABLE FLOOR AREA

MIN. GROUND FLOOR LIVING AREA

MINIMUM LOT WIDTH

STUART HUCKELBERRY

LENNAR HOMES OF INDIANA, LLC

11555 N. MERIDIAN ST., SUITE 400

135 N. PENNSYLVANIA ST., SUITE 2800

7,200 SQ. FT

DRAINAGE APPROVAL _____

COUNTY SANITARIAN APPROVAL

COUNTY COMMISSIONERS APPROVAL

ADDRESS APPROVAL _____


1,800 SF (MULTI STORY)

SUMMERTON SECTION 2

CONSTRUCTION PLANS Lennar Homes of Indiana, LLC

STREET NAME

SECTION 2

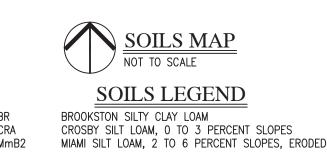



SHEET LIST TABLE

Sheet Title

Sheet Description

Sheet Thie	Sheet Bescription
C1.0	COVER
C1.1	EXISTING CONDITIONS PLAN
C1.2-C1.4	DEVELOPMENT PLAN
C1.5-C1.7	PRE-CONSTRUCTION STORMWATER POLLUTION PREVENTION PLAN
C1.8-C1.10	POST CONSTRUCTION STORMWATER POLLUTION PREVENTION PLAN
C1.11-C1.13	EMERGENCY FLOOD ROUTE PLAN
C1.14	MASTER UTILITY PLAN
C1.15-C1.16	SUBSURFACE DRAIN PLAN
C2.0-C2.2	STREET PLAN & PROFILE
C3.0	ENTRANCE PLAN
C3.1	MAINTENANCE OF TRAFFIC PLAN
C3.2	INTERSECTION & CUL-DE-SAC DETAILS
C3.3	TRAFFIC CONTROL AND LIGHTING PLAN
C4.0-C4.4	SANITARY SEWER PLAN & PROFILE
C6.0-C6.4	STORM SEWER PLAN & PROFILE
C7.0-C7.1	WATER DISTRIBUTION PLAN
C8.0	STORMWATER POLLUTION PREVENTION NOTES
C8.1-C8.4	STORMWATER POLLUTION PREVENTION DETAILS
C8.5	CONSTRUCTION DETAILS
C8.6	CITIZENS WATER DETAILS
L1.0-L1.2	LANDSCAPE PLAN
L1.3	LANDSCAPE DETAILS

CIVIL ENGINEER and SURVEYOR: STREET NAME **SECTION 4** SECTION 5 C.A. "4-E" C.A. "3-A" C.A. "4-E" C.A."1-B" C.A. "3-B" C.A."1-A" SECTION 3

CITIZENS ENERGY GROUP/ CWA AUTHORITY, INC. (WATER) BRAD HOSTETLER

2150 DR. MARTIN LUTHER KING JR. STREET

BHOSTETLER@CITIZENSENERGYGROUP.COM

NINESTAR CONNECT (Electric & Telecom)

INDIANAPOLIS, INDIANA 46202

ERIC MEYER (317) 323-2074

2243 East Main Street

Greenfield, Indiana 46140

P: (317) 927-4351



<u>VECTREN</u> SANDRA CASEY

16000 Allisonville Road

P: (317) 776-5532,

F: (317) 776-5553

matthew_stringer@cable.comcast.com Mailing Address: P.O. Box 1700

Noblesville, Indiana 46061

Noblesville, Indiana 46061

sandra.casey@centerpointenergy.com

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6280 W 800 N

P: (317) 335-3604

rcrum@mccordsville.org

McCordsville, Indiana 46055

<u>COMCAST</u> MATT STRINGER

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McCordsville, IN 46055

rcrider@mccordsville.org


P: (317) 335-3493

Indianapolis, IN 46220

McCORDSVILLE TOWN STANDARDS


SHEET LIST TABLE			
Sheet Title	Sheet Description		
1	DIRECTIONS FOR USE & GENERAL NOTES		
2	RIGHT-OF-WAY SECTIONS & PAVEMENT SPECIFICATIONS		
3	RIGHT-OF-WAY DETAILS		
4	UTILITY LOCATION GUIDELINES		
5	DRIVE WAY & HANDICAP RAMP DETAILS		
6	STORM SEWER STRUCTURE DETAILS		
7	STORM SEWER BEDDING DETAILS AND GENERAL NOTES		
8	SANITARY SEWER SPECIFICATIONS		
9	SANITARY SEWER DETAILS		
10	SANITARY SEWER LIFT STATION		

STANDARDS & GUIDELINES

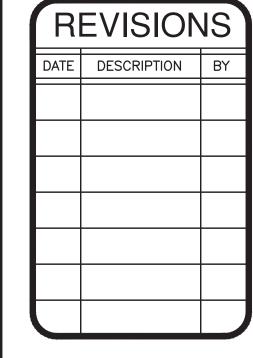





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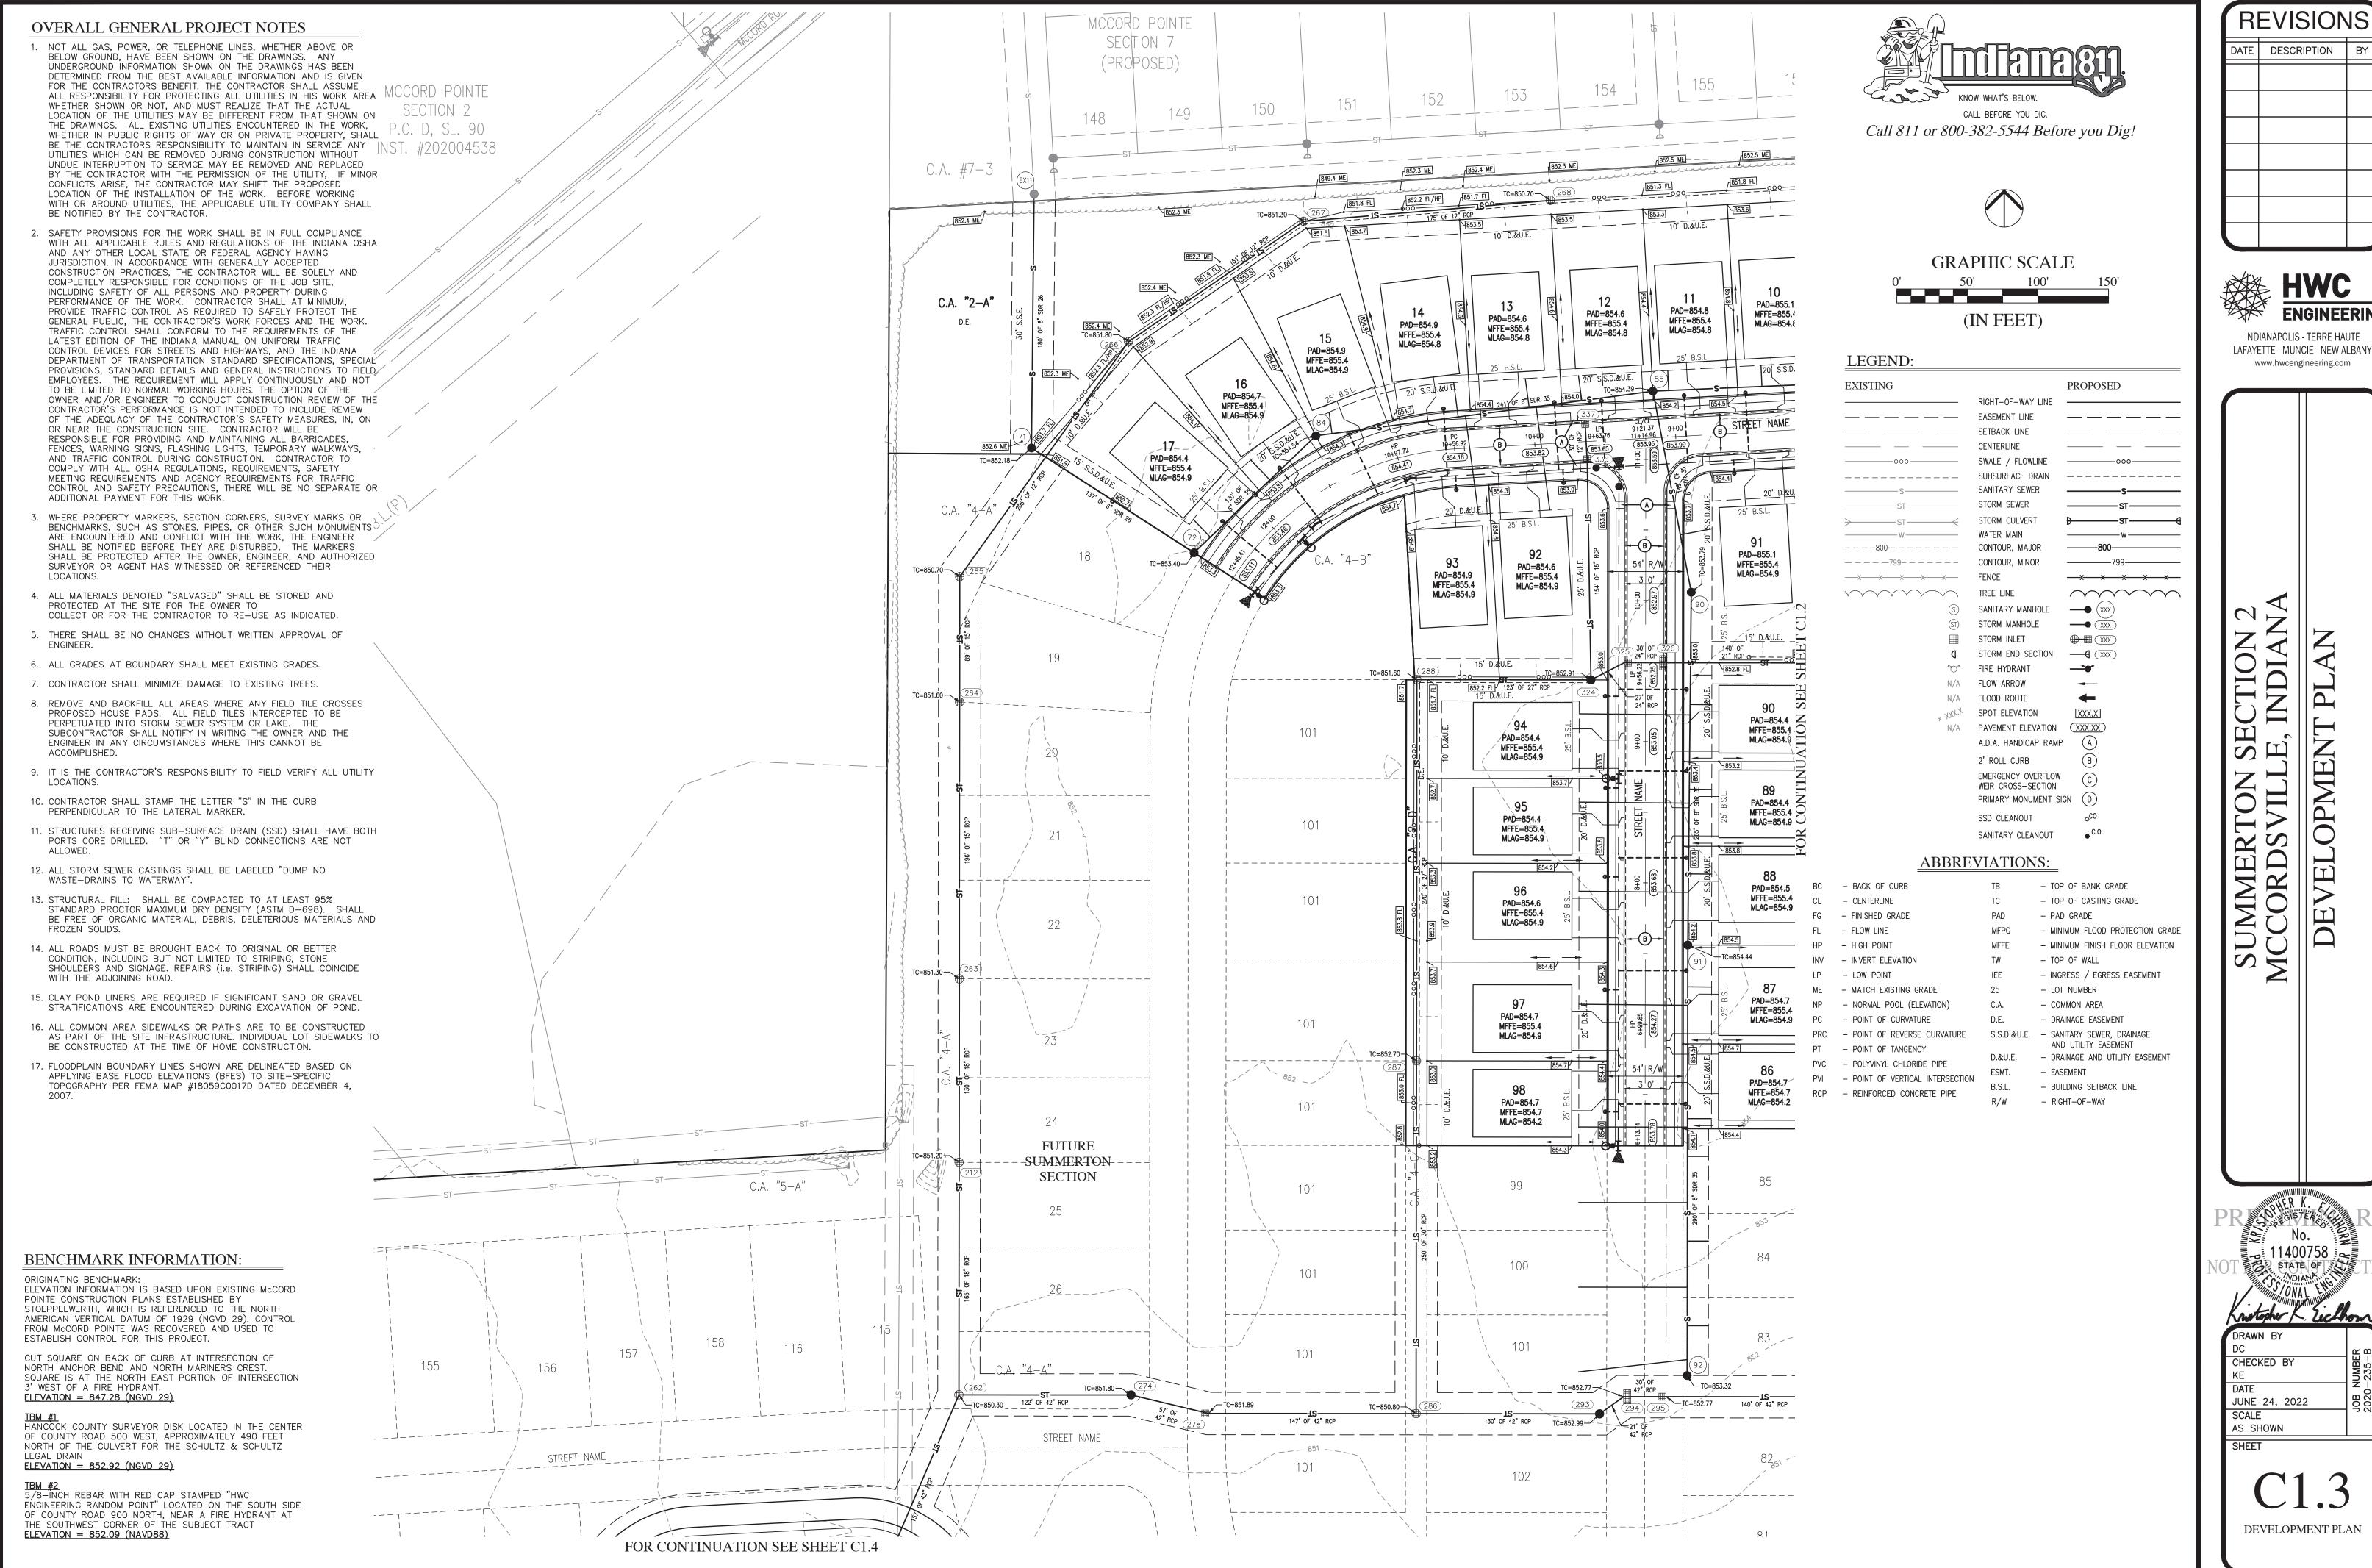
UMMERTON SECTION 2 CCORDSVILLE, INDIANA DEVELOPMENT PLAN
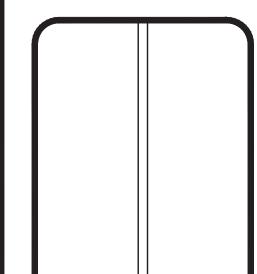
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AS SHOWN

C1.2

DEVELOPMENT PLAN

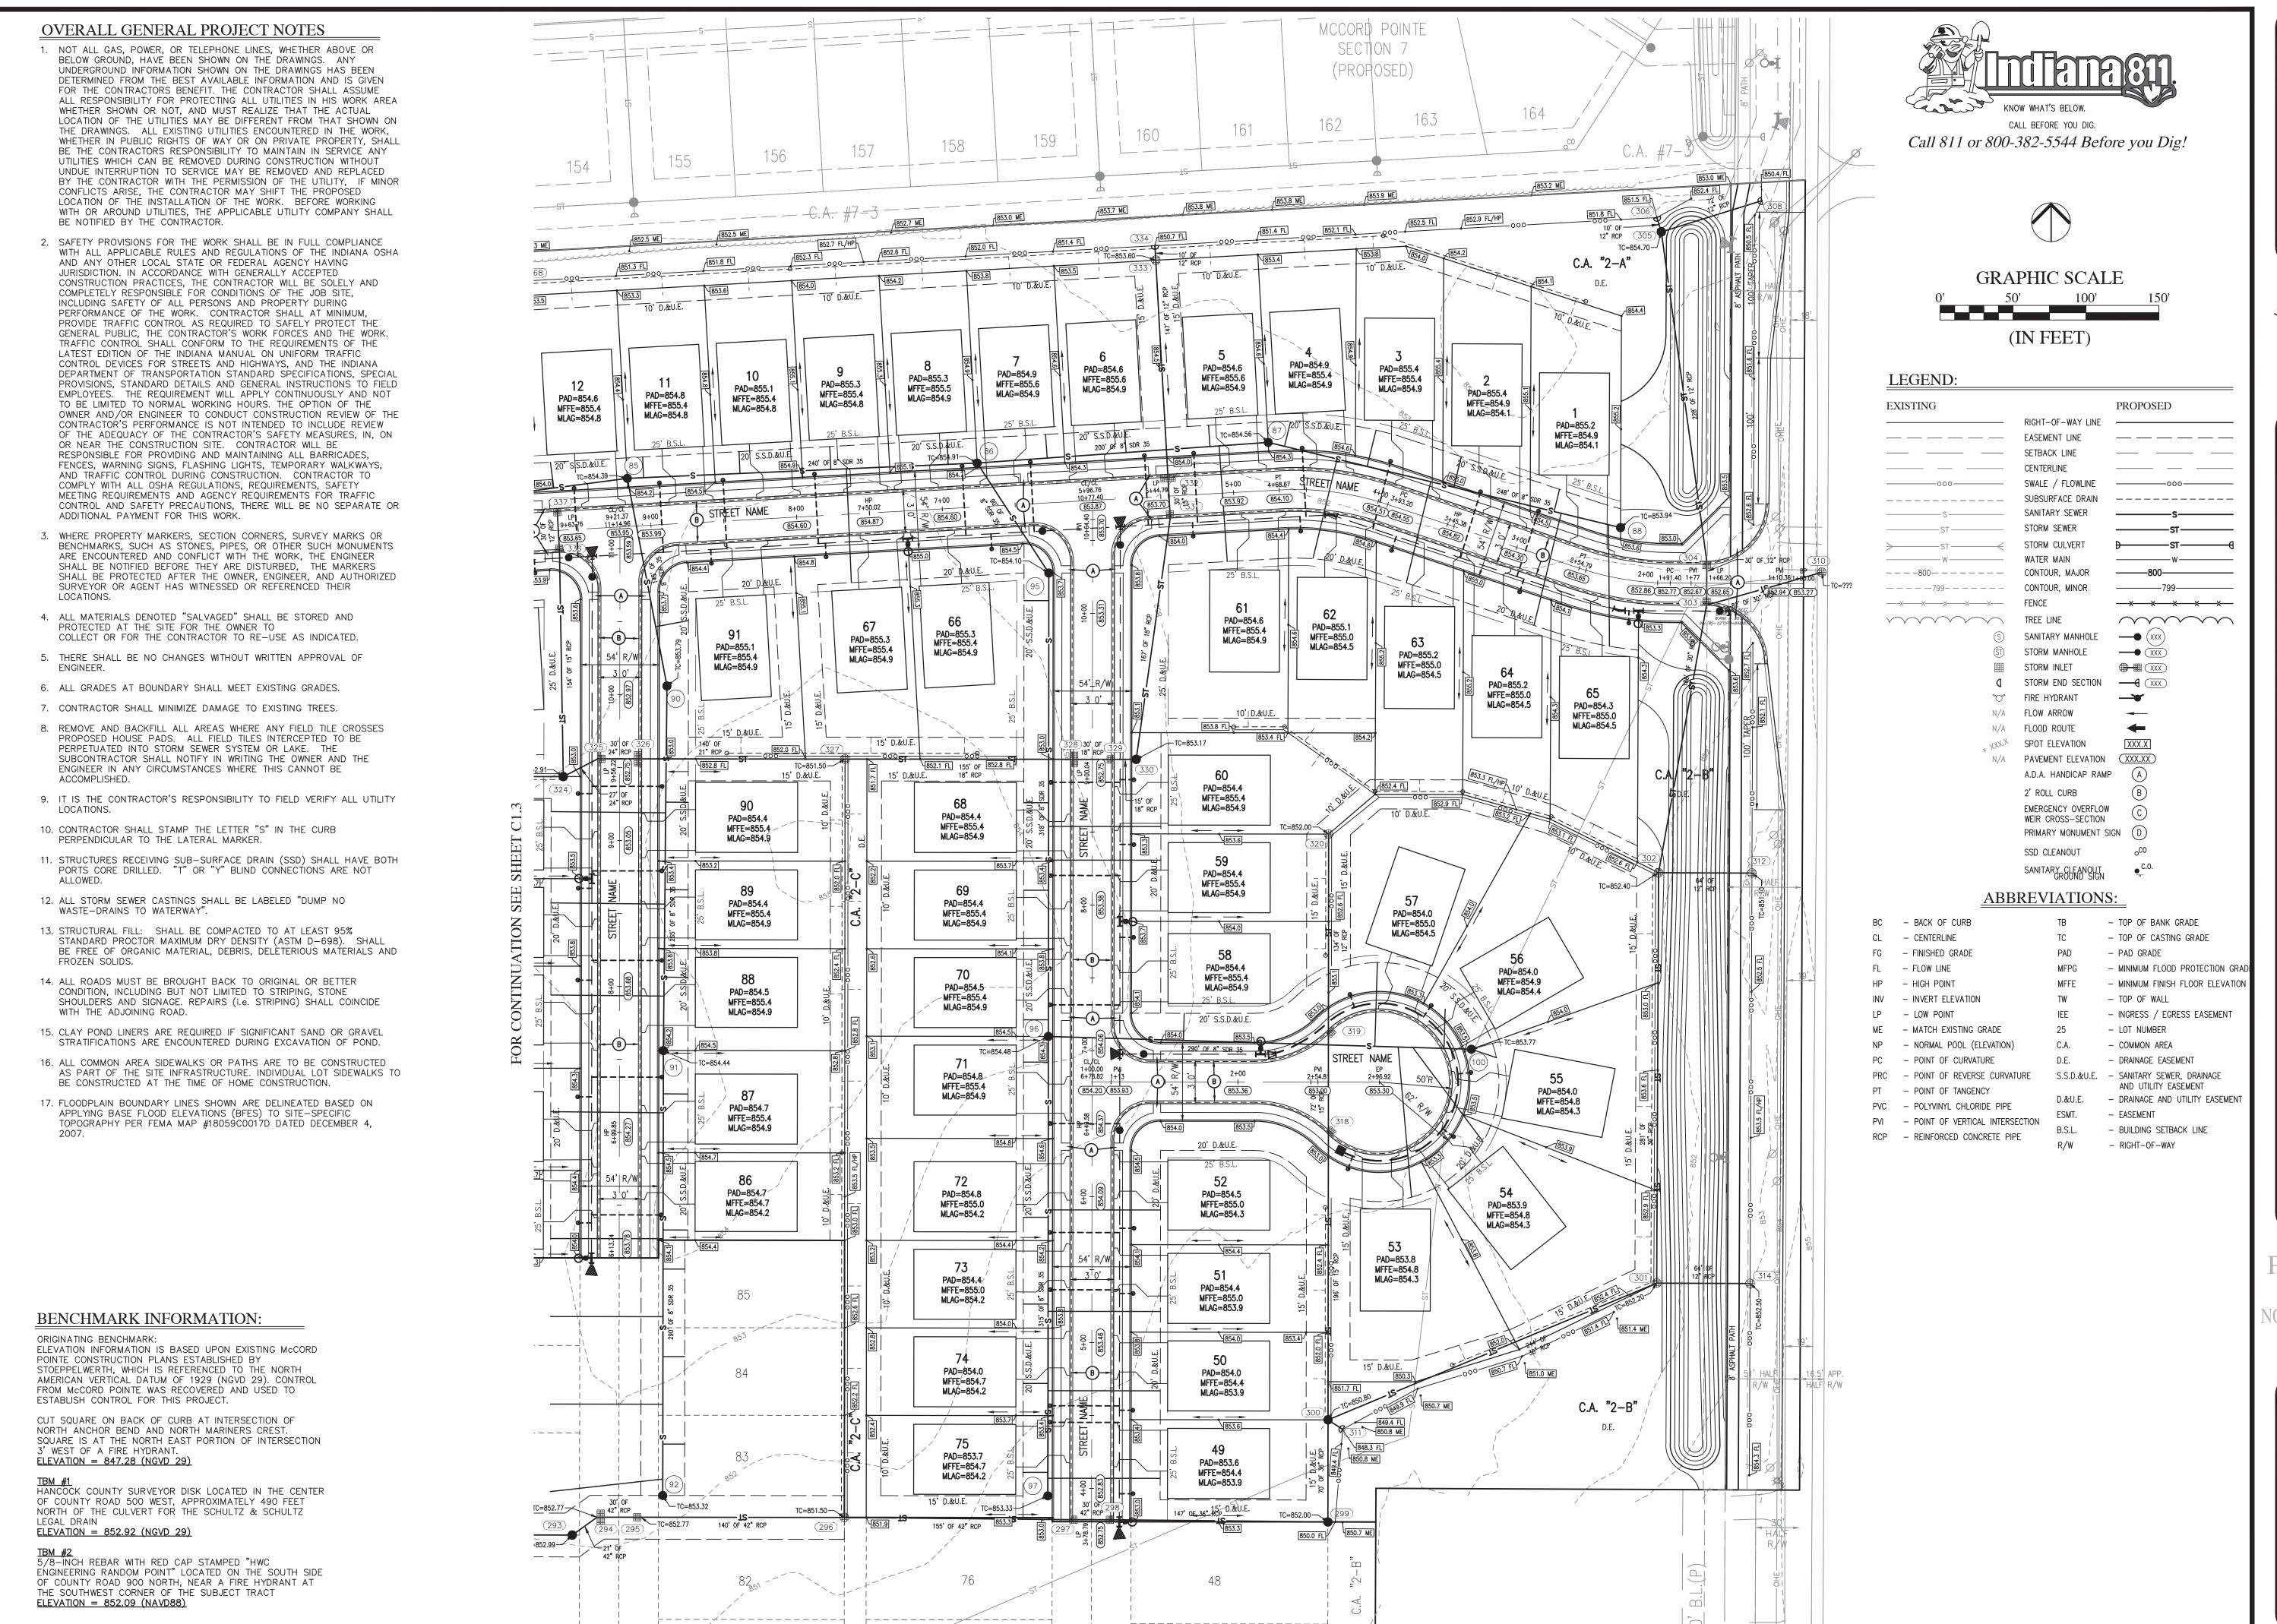© 2022

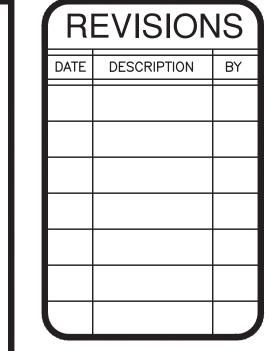

DATE DESCRIPTION BY

INDIANAPOLIS - TERRE HAUTE

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OIL SUMMER

TO ATOM STATE CHECKED BY JUNE 24, 2022 SCALE

DEVELOPMENT PLAN

OVERALL GENERAL PROJECT NOTES 1. NOT ALL GAS. POWER. OR TELEPHONE LINES. WHETHER ABOVE OR BELOW GROUND, HAVE BEEN SHOWN ON THE DRAWINGS. ANY UNDERGROUND INFORMATION SHOWN ON THE DRAWINGS HAS BEEN DETERMINED FROM THE BEST AVAILABLE INFORMATION AND IS GIVEN FOR THE CONTRACTORS BENEFIT. THE CONTRACTOR SHALL ASSUME ALL RESPONSIBILITY FOR PROTECTING ALL UTILITIES IN HIS WORK AREA WHETHER SHOWN OR NOT, AND MUST REALIZE THAT THE ACTUAL LOCATION OF THE UTILITIES MAY BE DIFFERENT FROM THAT SHOWN ON THE DRAWINGS. ALL EXISTING UTILITIES ENCOUNTERED IN THE WORK, WHETHER IN PUBLIC RIGHTS OF WAY OR ON PRIVATE PROPERTY, SHALL BE THE CONTRACTORS RESPONSIBILITY TO MAINTAIN IN SERVICE ANY UTILITIES WHICH CAN BE REMOVED DURING CONSTRUCTION WITHOUT UNDUE INTERRUPTION TO SERVICE MAY BE REMOVED AND REPLACED BY THE CONTRACTOR WITH THE PERMISSION OF THE UTILITY, IF MINOR CONFLICTS ARISE, THE CONTRACTOR MAY SHIFT THE PROPOSED LOCATION OF THE INSTALLATION OF THE WORK. BEFORE WORKING WITH OR AROUND UTILITIES, THE APPLICABLE UTILITY COMPANY SHALL BE NOTIFIED BY THE CONTRACTOR. SAFETY PROVISIONS FOR THE WORK SHALL BE IN FULL COMPLIANCE WITH ALL APPLICABLE RULES AND REGULATIONS OF THE INDIANA OSHA

AND ANY OTHER LOCAL STATE OR FEDERAL AGENCY HAVING JURISDICTION. IN ACCORDANCE WITH GENERALLY ACCEPTED CONSTRUCTION PRACTICES, THE CONTRACTOR WILL BE SOLELY AND COMPLETELY RESPONSIBLE FOR CONDITIONS OF THE JOB SITE, INCLUDING SAFETY OF ALL PERSONS AND PROPERTY DURING PERFORMANCE OF THE WORK. CONTRACTOR SHALL AT MINIMUM, PROVIDE TRAFFIC CONTROL AS REQUIRED TO SAFELY PROTECT THE GENERAL PUBLIC, THE CONTRACTOR'S WORK FORCES AND THE WORK. TRAFFIC CONTROL SHALL CONFORM TO THE REQUIREMENTS OF THE LATEST EDITION OF THE INDIANA MANUAL ON UNIFORM TRAFFIC CONTROL DEVICES FOR STREETS AND HIGHWAYS, AND THE INDIANA DEPARTMENT OF TRANSPORTATION STANDARD SPECIFICATIONS, SPECIAL PROVISIONS, STANDARD DETAILS AND GENERAL INSTRUCTIONS TO FIELD EMPLOYEES. THE REQUIREMENT WILL APPLY CONTINUOUSLY AND NOT TO BE LIMITED TO NORMAL WORKING HOURS. THE OPTION OF THE OWNER AND/OR ENGINEER TO CONDUCT CONSTRUCTION REVIEW OF THE CONTRACTOR'S PERFORMANCE IS NOT INTENDED TO INCLUDE REVIEW OF THE ADEQUACY OF THE CONTRACTOR'S SAFETY MEASURES, IN, ON OR NEAR THE CONSTRUCTION SITE. CONTRACTOR WILL BE RESPONSIBLE FOR PROVIDING AND MAINTAINING ALL BARRICADES, FENCES, WARNING SIGNS, FLASHING LIGHTS, TEMPORARY WALKWAYS, AND TRAFFIC CONTROL DURING CONSTRUCTION. CONTRACTOR TO COMPLY WITH ALL OSHA REGULATIONS, REQUIREMENTS, SAFETY MEETING REQUIREMENTS AND AGENCY REQUIREMENTS FOR TRAFFIC CONTROL AND SAFETY PRECAUTIONS, THERE WILL BE NO SEPARATE OR

ADDITIONAL PAYMENT FOR THIS WORK.

149

FUTURE SUMMERTON

- 3. WHERE PROPERTY MARKERS, SECTION CORNERS, SURVEY MARKS OR BENCHMARKS, SUCH AS STONES, PIPES, OR OTHER SUCH MONUMENTS ARE ENCOUNTERED AND CONFLICT WITH THE WORK, THE ENGINEER SHALL BE NOTIFIED BEFORE THEY ARE DISTURBED, THE MARKERS SHALL BE PROTECTED AFTER THE OWNER, ENGINEER, AND AUTHORIZED SURVEYOR OR AGENT HAS WITNESSED OR REFERENCED THEIR
- 4. ALL MATERIALS DENOTED "SALVAGED" SHALL BE STORED AND PROTECTED AT THE SITE FOR THE OWNER TO COLLECT OR FOR THE CONTRACTOR TO RE-USE AS INDICATED.
- 5. THERE SHALL BE NO CHANGES WITHOUT WRITTEN APPROVAL OF ENGINEER.
- 6. ALL GRADES AT BOUNDARY SHALL MEET EXISTING GRADES.

7. CONTRACTOR SHALL MINIMIZE DAMAGE TO EXISTING TREES.

- 8. REMOVE AND BACKFILL ALL AREAS WHERE ANY FIELD TILE CROSSES PROPOSED HOUSE PADS. ALL FIELD TILES INTERCEPTED TO BE PERPETUATED INTO STORM SEWER SYSTEM OR LAKE. THE SUBCONTRACTOR SHALL NOTIFY IN WRITING THE OWNER AND THE ENGINEER IN ANY CIRCUMSTANCES WHERE THIS CANNOT BE ACCOMPLISHED.
- 9. IT IS THE CONTRACTOR'S RESPONSIBILITY TO FIELD VERIFY ALL UTILITY LOCATIONS.
- 10. CONTRACTOR SHALL STAMP THE LETTER "S" IN THE CURB PERPENDICULAR TO THE LATERAL MARKER.
- 11. STRUCTURES RECEIVING SUB-SURFACE DRAIN (SSD) SHALL HAVE BOTH PORTS CORE DRILLED. "T" OR "Y" BLIND CONNECTIONS ARE NOT
- 12. ALL STORM SEWER CASTINGS SHALL BE LABELED "DUMP NO WASTE-DRAINS TO WATERWAY"
- 13. STRUCTURAL FILL: SHALL BE COMPACTED TO AT LEAST 95% STANDARD PROCTOR MAXIMUM DRY DENSITY (ASTM D-698). SHALL BE FREE OF ORGANIC MATERIAL, DEBRIS, DELÈTERIOUS MATERIALS AND FROZEN SOLIDS.

154

153

155

- 14. ALL ROADS MUST BE BROUGHT BACK TO ORIGINAL OR BETTER CONDITION, INCLUDING BUT NOT LIMITED TO STRIPING, STONE SHOULDERS AND SIGNAGE. REPAIRS (i.e. STRIPING) SHALL COINCIDE WITH THE ADJOINING ROAD.
- 15. CLAY POND LINERS ARE REQUIRED IF SIGNIFICANT SAND OR GRAVEL STRATIFICATIONS ARE ENCOUNTERED DURING EXCAVATION OF POND.
- 16. ALL COMMON AREA SIDEWALKS OR PATHS ARE TO BE CONSTRUCTED AS PART OF THE SITE INFRASTRUCTURE. INDIVIDUAL LOT SIDEWALKS TO BE CONSTRUCTED AT THE TIME OF HOME CONSTRUCTION.
- 17. FLOODPLAIN BOUNDARY LINES SHOWN ARE DELINEATED BASED ON APPLYING BASE FLOOD ELEVATIONS (BFES) TO SITE-SPECIFIC TOPOGRAPHY PER FEMA MAP #18059C0017D DATED DECEMBER 4,

BENCHMARK INFORMATION:

ESTABLISH CONTROL FOR THIS PROJECT.

ELEVATION = 847.28 (NGVD 29)

ORIGINATING BENCHMARK: ELEVATION INFORMATION IS BASED UPON EXISTING McCORD POINTE CONSTRUCTION PLANS ESTABLISHED BY STOEPPELWERTH, WHICH IS REFERENCED TO THE NORTH AMERICAN VERTICAL DATUM OF 1929 (NGVD 29). CONTROL

FROM McCORD POINTE WAS RECOVERED AND USED TO

CUT SQUARE ON BACK OF CURB AT INTERSECTION OF NORTH ANCHOR BEND AND NORTH MARINERS CREST. SQUARE IS AT THE NORTH EAST PORTION OF INTERSECTION 3' WEST OF A FIRE HYDRANT.

HANCOCK COUNTY SURVEYOR DISK LOCATED IN THE CENTER OF COUNTY ROAD 500 WEST, APPROXIMATELY 490 FEET NORTH OF THE CULVERT FOR THE SCHULTZ & SCHULTZ ELEVATION = 852.92 (NGVD 29)

TBM #2 5/8-INCH REBAR WITH RED CAP STAMPED "HWC ENGINEERING RANDOM POINT" LOCATED ON THE SOUTH SIDE OF COUNTY ROAD 900 NORTH, NEAR A FIRE HYDRANT AT THE SOUTHWEST CORNER OF THE SUBJECT TRACT ELEVATION = 852.09 (NAVD88)

100 YEAR ELEV = 848.06

C.A. "5-A"

116

ABBREVIATIONS:

BC - BACK OF CURB TOP OF BANK GRADE CL – CENTERLINE TOP OF CASTING GRADE FG - FINISHED GRADE PAD GRADE FL - FLOW LINE - MINIMUM FLOOD PROTECTION GRADE - MINIMUM FINISH FLOOR ELEVATION HP - HIGH POINT INV - INVERT ELEVATION TOP OF WALL - INGRESS / EGRESS EASEMENT LP - LOW POINT ME - MATCH EXISTING GRADE LOT NUMBER NP - NORMAL POOL (ELEVATION) COMMON AREA PC - POINT OF CURVATURE DRAINAGE EASEMENT PRC - POINT OF REVERSE CURVATURE S.S.D.&U.E. - SANITARY SEWER, DRAINAGE AND UTILITY EASEMENT PT — POINT OF TANGENCY D.&U.E. DRAINAGE AND UTILITY EASEMENT PVC - POLYVINYL CHLORIDE PIPE ESMT. EASEMENT PVI - POINT OF VERTICAL INTERSECTION

RCP - REINFORCED CONCRETE PIPE

<u>-</u> _ _ _ _ _ _

 \vdash - - - - -

FOR CONTINUATION SEE SHEET C1.3

TC=851.80 -

STREET NAME

FUTURE

SECTION

TC=850.30 122' OF 42" RCP

-SUMMERTON---


BUILDING SETBACK LINE


- RIGHT-OF-WAY







GRAPHIC SCALE (IN FEET)

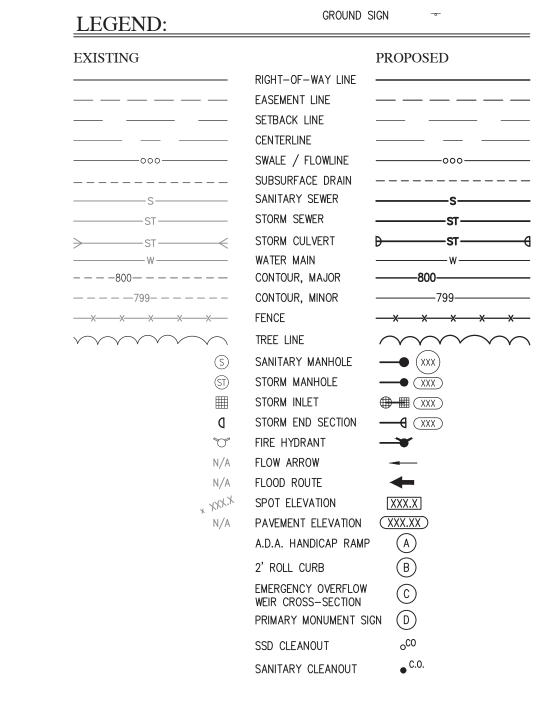

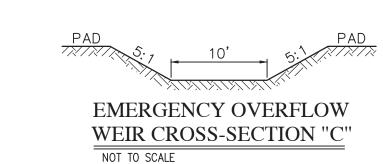

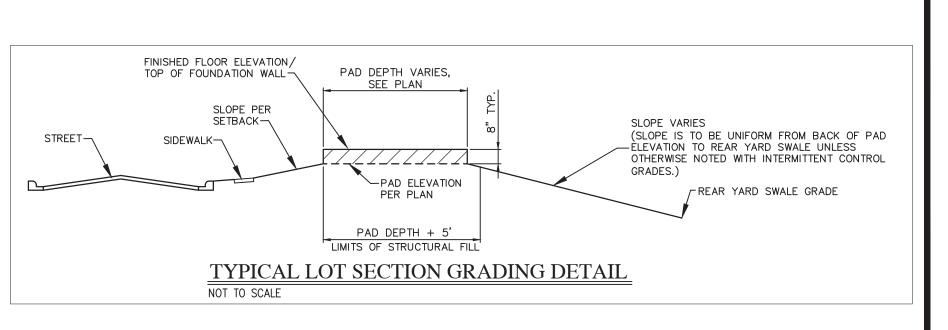


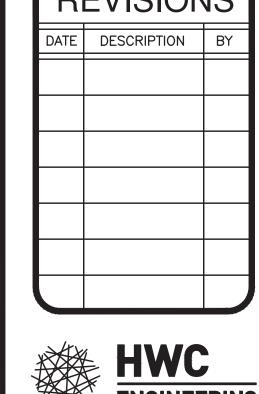



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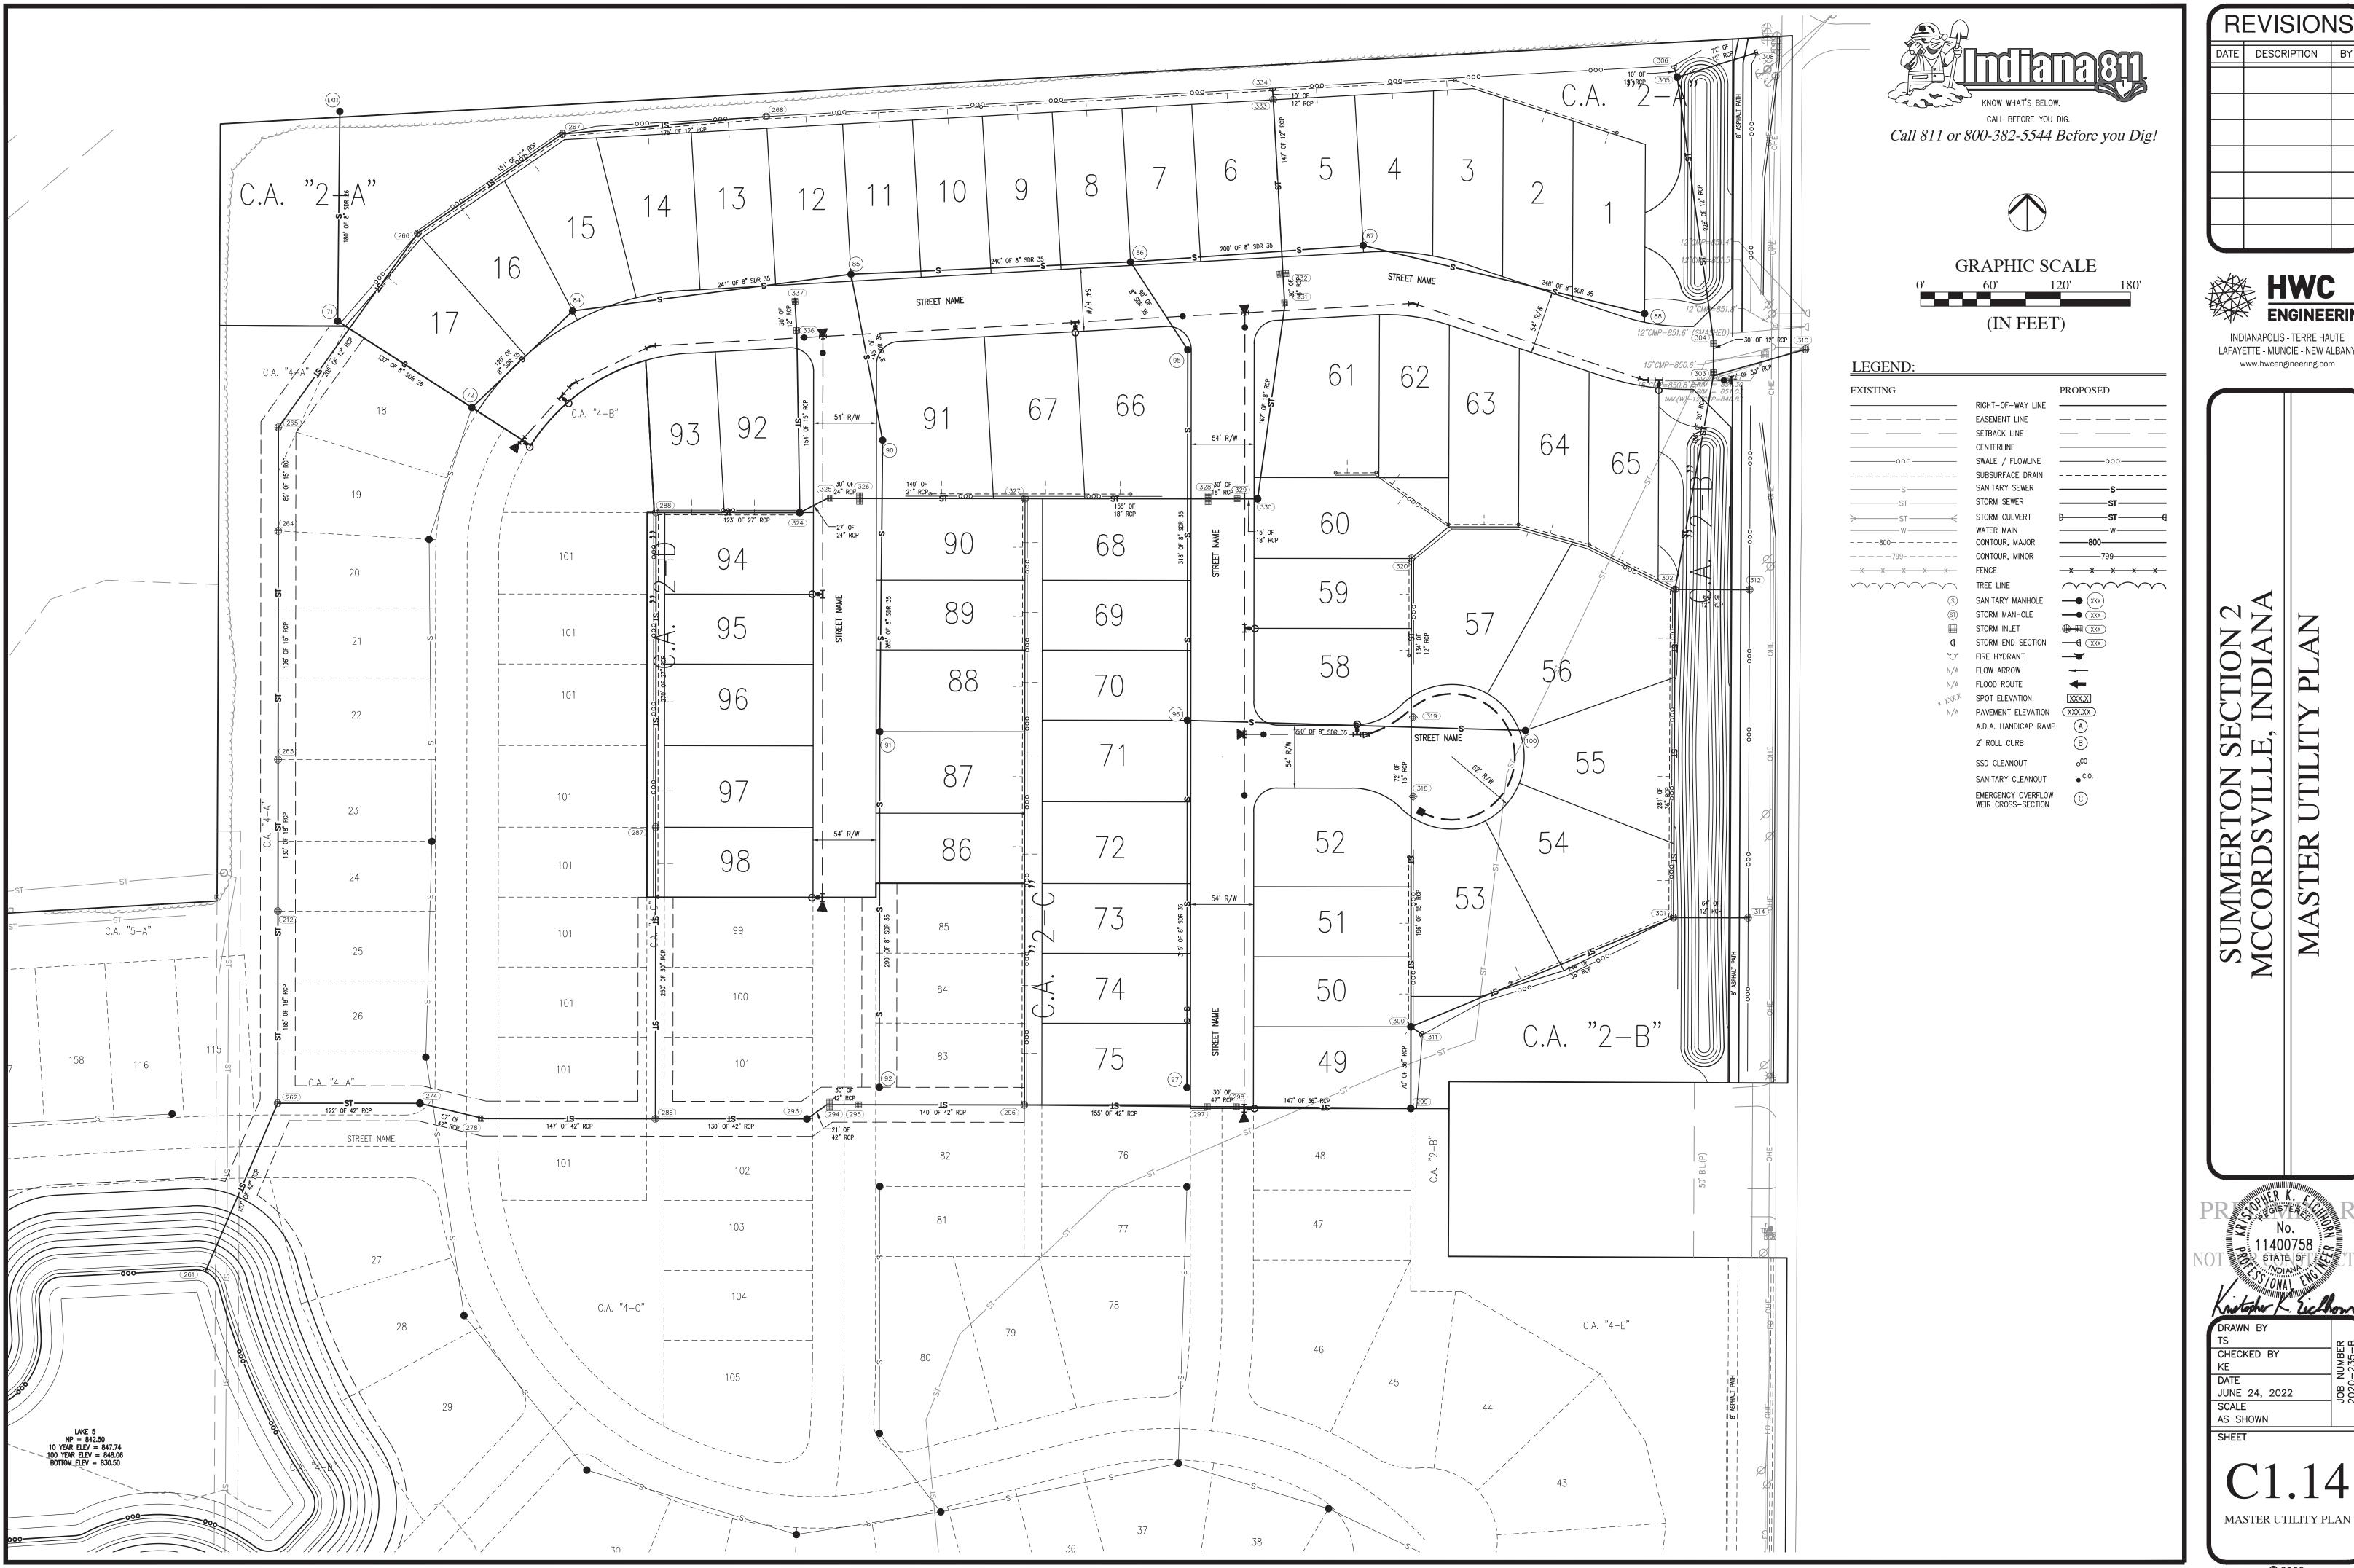
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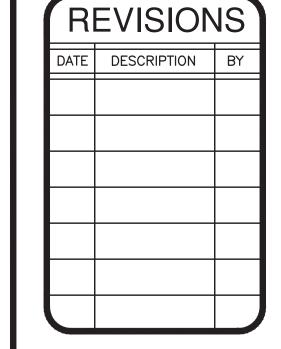


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CHECKED BY JUNE 24, 2022 SCALE AS SHOWN

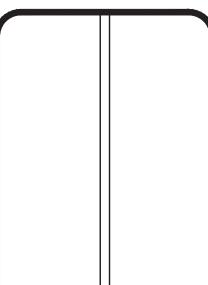DEVELOPMENT PLAN







INDIANAPOLIS - TERRE HAUTE LAFAYETTE - MUNCIE - NEW ALBANY www.hwcengineering.com

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KE] 53 [53 [
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JUNE 24, 2022	JOB NUMBER 2020-235-B
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