

DATE	DESCRIPTION	BY
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MCCORD POINTE SECTION 7 MCCORDSVILLE, INDIANA

COVER SHEET



DRAWN BY TS	CHECKED BY KE
DATE NOVEMBER 2020	SCALE AS SHOWN
JOB NUMBER 2019-263-C	
SHEET	

C1.0
COVER SHEET



SOILS MAP
NOT TO SCALE


SOILS LEGEND
BR BROOKSTON SILTY CLAY LOAM
CRA CROSBY SILT LOAM, 0 TO 3 PERCENT SLOPES

SHEET LIST TABLE

Sheet Title	Sheet Description
C1.0	COVER
T1.1-T1.2	EXISTING CONDITIONS PLAN
C1.1-C1.2	DEVELOPMENT PLAN
C1.3-C1.4	PRE-CONSTRUCTION STORMWATER POLLUTION PREVENTION & DEMOLITION PLAN
C1.5-C1.6	POST CONSTRUCTION STORMWATER POLLUTION PREVENTION PLAN
C1.7-C1.8	EMERGENCY FLOOD ROUTE PLAN
C1.9	MASTER UTILITY PLAN
C1.10-C1.11	SUBSURFACE DRAIN PLAN
C2.0-C2.3	STREET PLAN & PROFILE
C3.0-C3.1	INTERSECTION & CUL-DE-SAC DETAILS
C3.2	CR 500 W ROAD WIDENING PLAN
C3.3	TRAFFIC CONTROL AND LIGHTING PLAN
C4.0-C4.2	SANITARY SEWER PLAN & PROFILE
C6.0-C6.4	STORM SEWER PLAN & PROFILE
C7.0-C7.1	WATER DISTRIBUTION PLAN
C8.0	STORMWATER POLLUTION PREVENTION NOTES
C8.1-C8.4	STORMWATER POLLUTION PREVENTION DETAILS
C8.5	CONSTRUCTION DETAILS
C8.6	CITIZENS WATER DETAILS
L1.0-L1.1	LANDSCAPE PLAN
L1.2	LANDSCAPE DETAILS

McCORDSVILLE TOWN STANDARDS SHEET LIST TABLE

Sheet Title	Sheet Description
1	DIRECTIONS FOR USE & GENERAL NOTES
2	RIGHT-OF-WAY SECTIONS & PAVEMENT SPECIFICATIONS
3	RIGHT-OF-WAY DETAILS
4	UTILITY LOCATION GUIDELINES
5	DRIVE WAY & HANDICAP RAMP DETAILS
6	STORM SEWER STRUCTURE DETAILS
7	STORM SEWER BEDDING DETAILS AND GENERAL NOTES
8	SANITARY SEWER SPECIFICATIONS
9	SANITARY SEWER DETAILS
10	SANITARY SEWER LIFT STATION STANDARDS & GUIDELINES

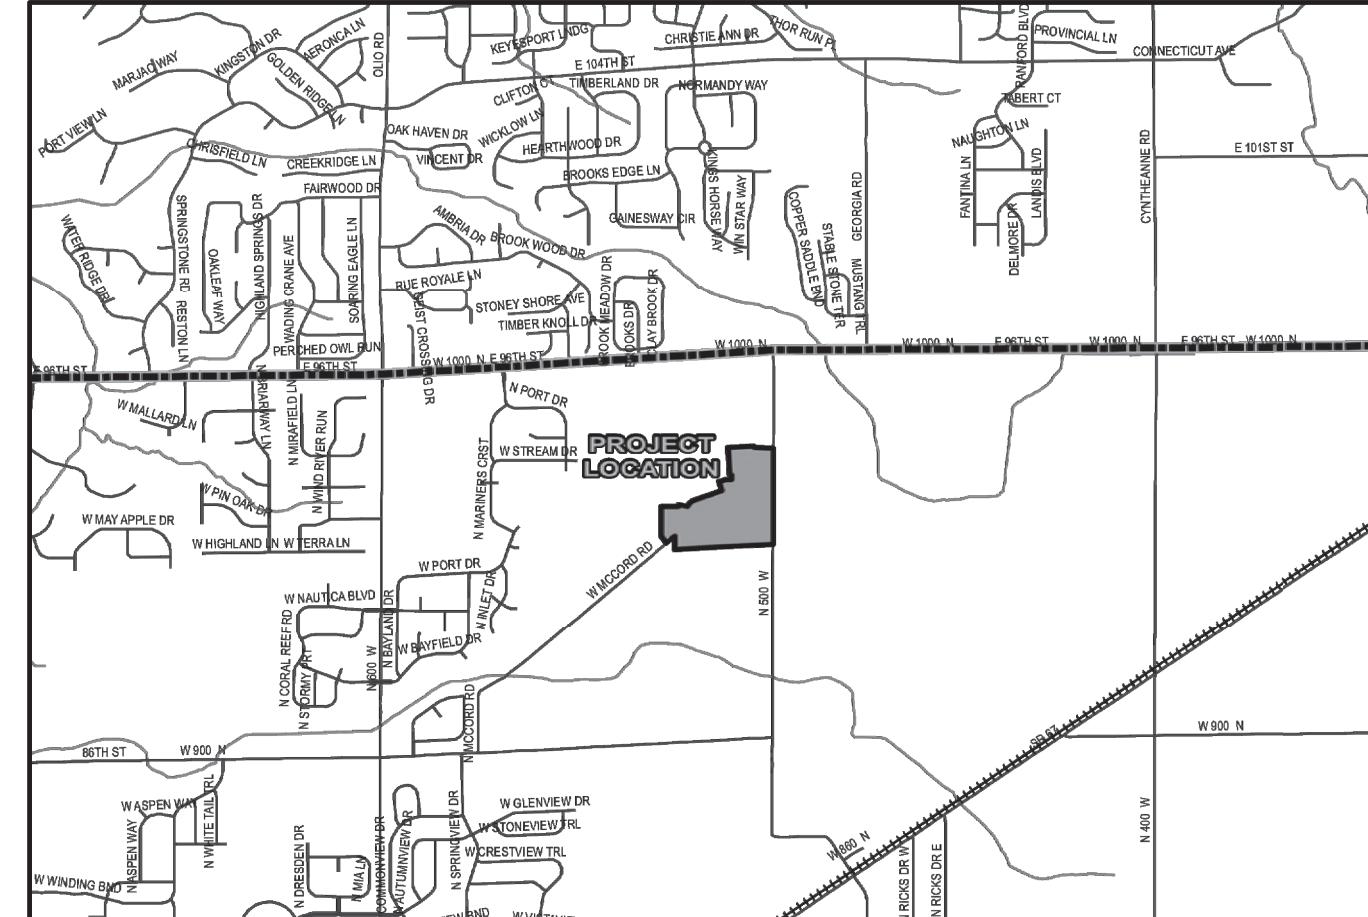

LOCATION MAP
SCALE 1" = 1 MILE

McCORD POINTE SECTION 7

Lennar Homes of Indiana, Inc.

DEVELOPER:

LENNAR HOMES OF INDIANA, INC.
BILL BRYANT
9025 NORTH RIVER ROAD, SUITE 100
INDIANAPOLIS, INDIANA 46240
(317) 450-4634

CIVIL ENGINEER and SURVEYOR:

HWC ENGINEERING
135 N. PENNSYLVANIA ST., SUITE 2800
INDIANAPOLIS, IN 46204
(317) 347-3663
keichhorn@hwcengineering.com

COMMON AREAS	
C.A.#7-1	0.38 AC
C.A.#7-2	1.64 AC
C.A.#7-3	2.08 AC
C.A.#7-4	5.48 AC
C.A.#7-5	0.93 AC
TOTAL	10.51 AC


LINEAR FOOTAGE OF STREETS	
CANBERRA COURT	282 LF
CHAMBERS DRIVE	405 LF
HOLBORN AVENUE	1,779 LF
PARKHURST CROSSING	948 LF
TOTAL	3,414 LF

ZONED McCORD POINTE AMENDED PUD ORDINANCE NO.
101017B, AN ORDINANCE AMENDING THE TOWN OF
McCORDSVILLE ZONING ORDINANCE NO. 121410, AS AMENDED.

DEVELOPMENT STANDARDS

	AREA "B"
MAXIMUM NUMBER OF LOTS	135
MINIMUM LOT AREA	9,000 SQ. FT.
MINIMUM LOT WIDTH	
AT BUILDING LINE	70
MINIMUM FRONT YARD SETBACK	25 FEET
MINIMUM SIDE YARD SETBACK	7.5 FEET
MINIMUM REAR YARD SETBACK	25 FEET
MINIMUM LIVABLE FLOOR AREA	1,500 SF (SINGLE STORY) 1,800 SF (MULTI STORY)
MIN. GROUND FLOOR LIVING AREA	900 SF (MULTI STORY)
MAXIMUM LOT COVERAGE	40%
MAXIMUM HEIGHT - PRINCIPAL	35 FEET

- PLAN COMMISSION APPROVAL _____
- DRAINAGE APPROVAL _____
- ADDRESS APPROVAL _____
- EROSION CONTROL APPROVAL _____
- COUNTY ENGINEER APPROVAL _____
- COUNTY SANITARIAN APPROVAL _____
- COUNTY COMMISSIONERS APPROVAL _____

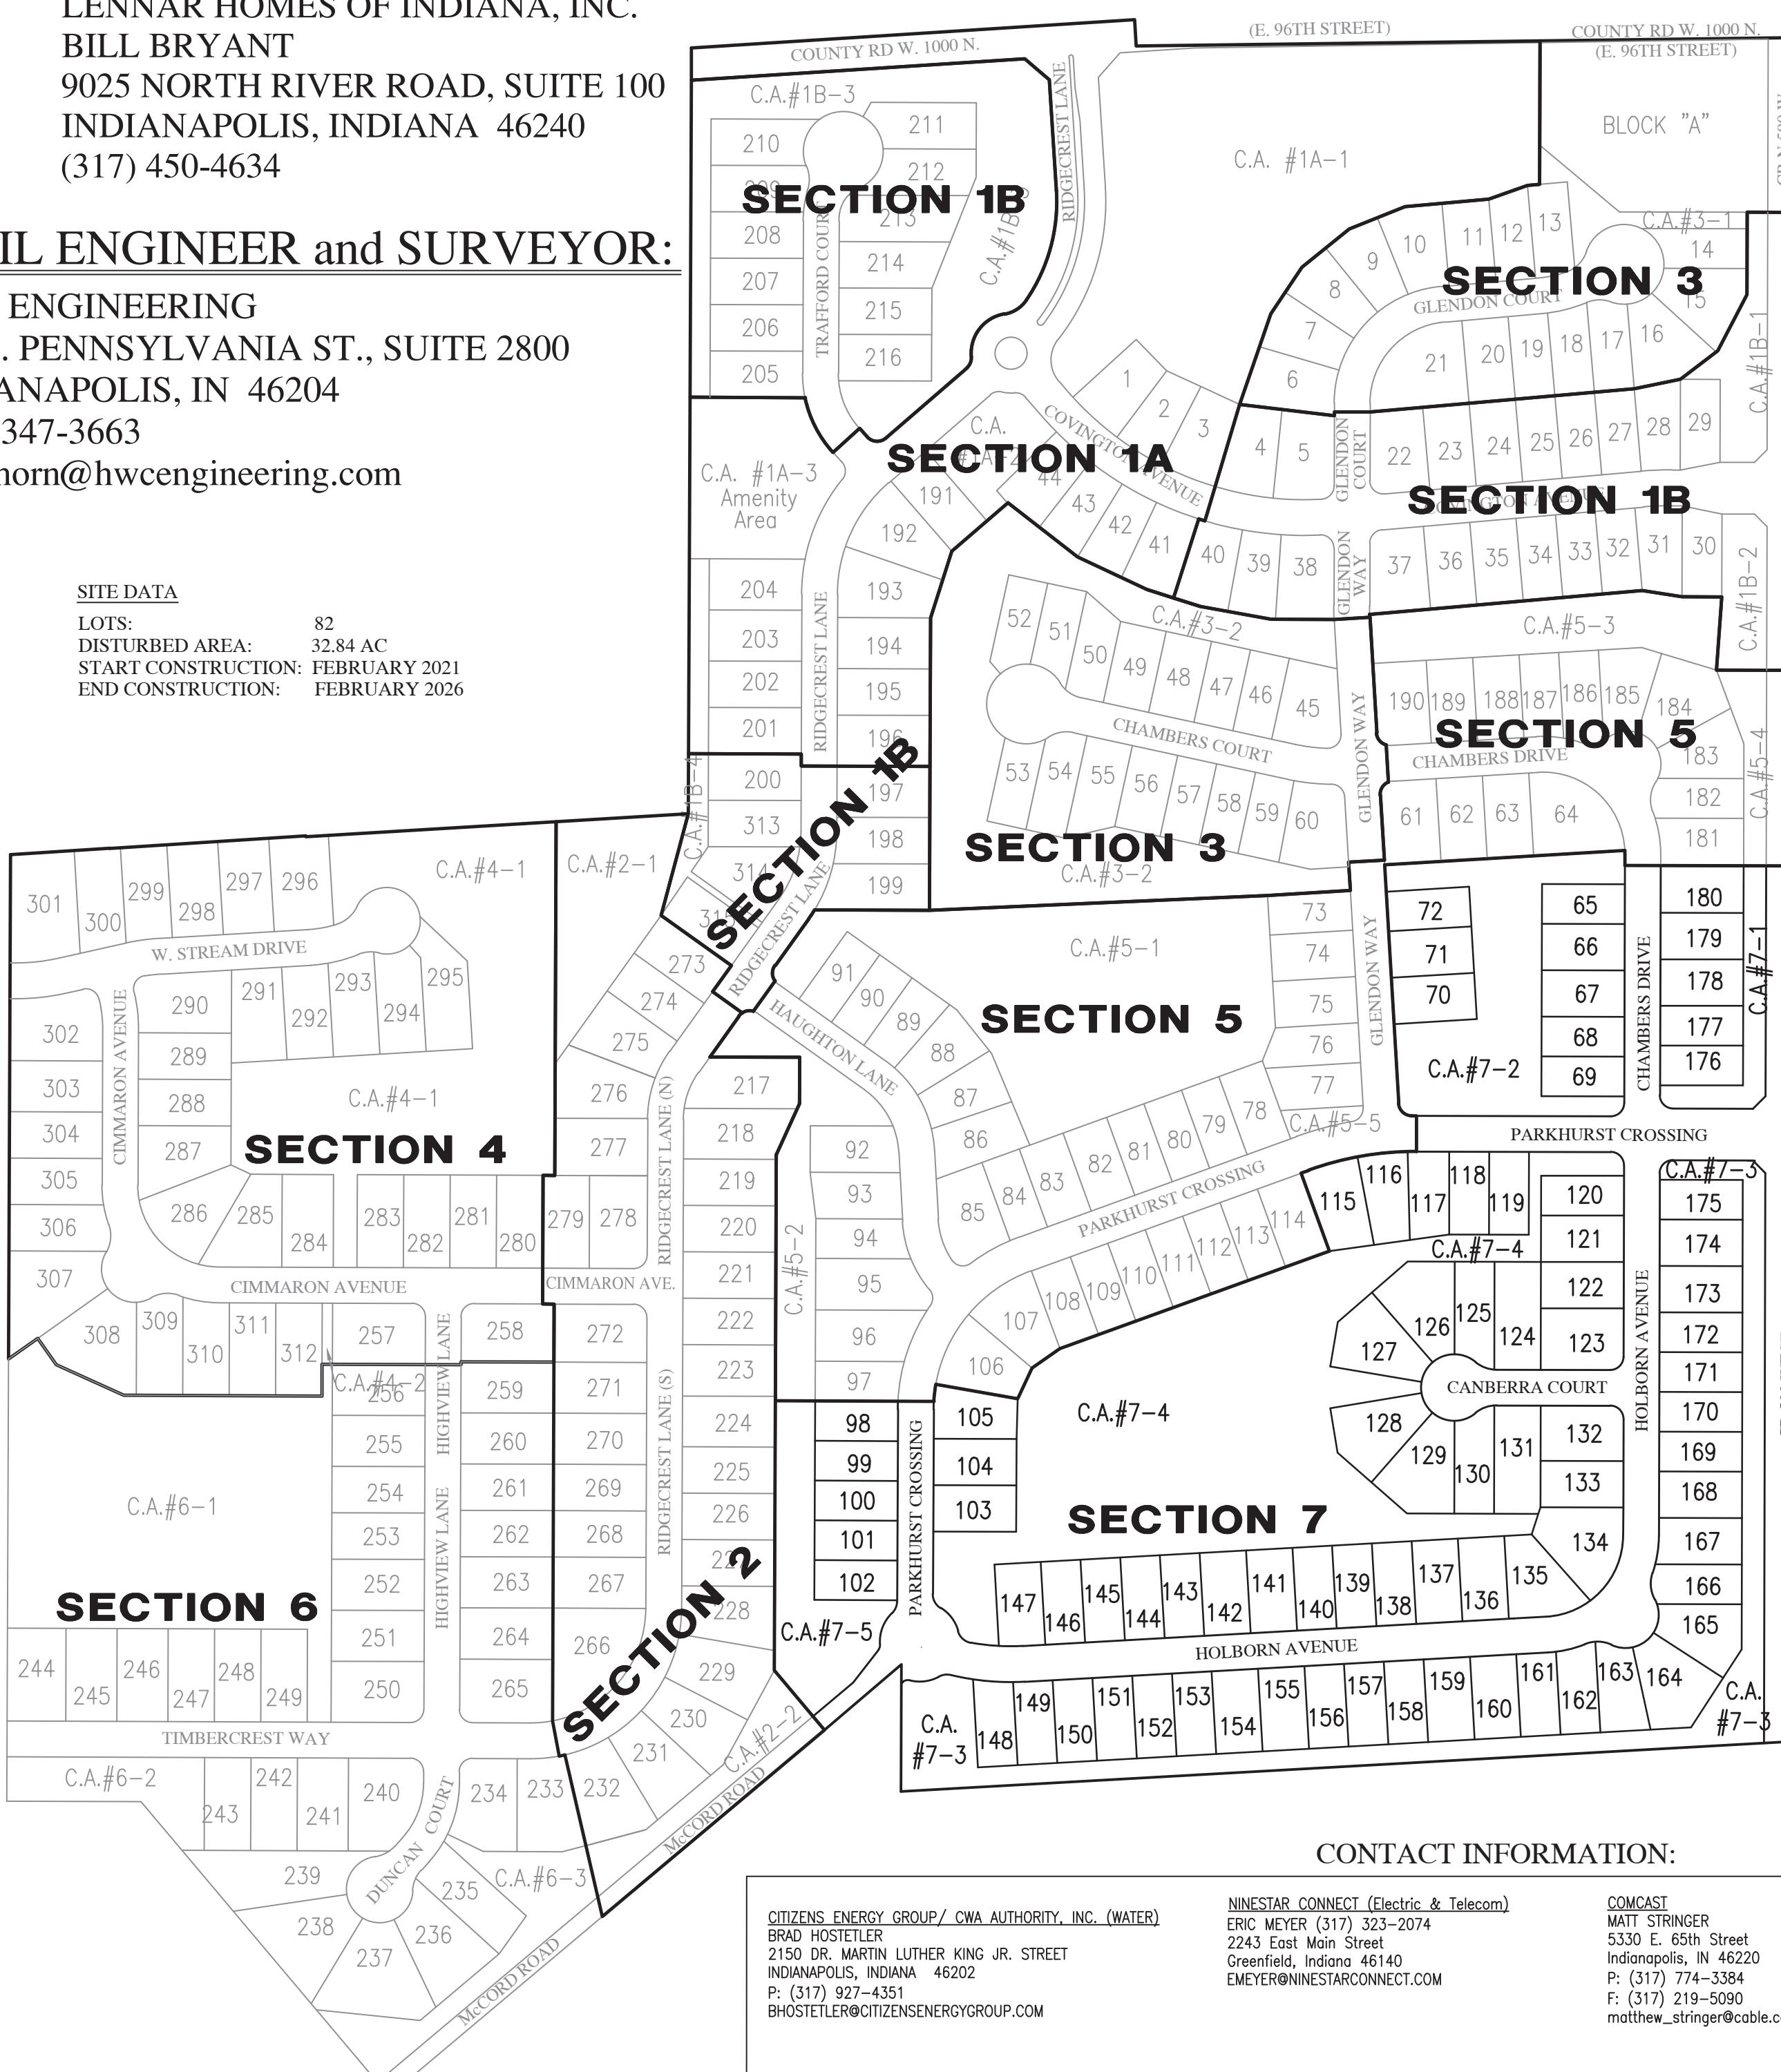

REVISIONS

DATE	DESCRIPTION	BY
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GRAPHIC SCALE


0' 50' 100' 150'

(IN FEET)

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MCCORD POINTE SECTION 7 MCCORDSVILLE, INDIANA

DEVELOPMENT PLAN

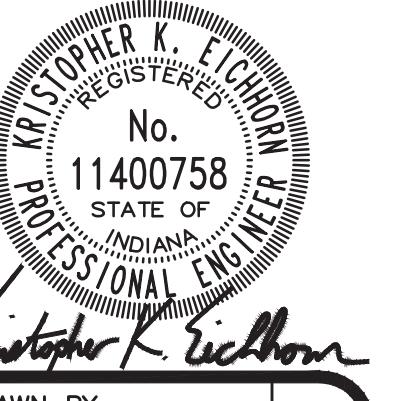

DRAWN BY
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KE
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SCALE AS SHOWN
JOB NUMBER 2019-263-G

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DEVELOPMENT PLAN

LEGEND:

EXISTING	PROPOSED
RIGHT-OF-WAY LINE	FLOW ARROW
EASEMENT LINE	SPOT ELEVATION
SETBACK LINE	PEAVEMENT ELEVATION
CENTERLINE	N/A
SWALE / FLOWLINE	A.D.A. HANDICAP RAMP
SUBSURFACE DRAIN	2' ROLL CURB
SANITARY SEWER	SSD CLEANOUT
STORM SEWER	SANITARY CLEANOUT
STORM CULVERT	EMERGENCY OVERFLOW
WATER MAIN	WEIR CROSS-SECTION
CONTOUR, MAJOR	
CONTOUR, MINOR	
FENCE	
TREE LINE	
SANITARY MANHOLE	
STORM MANHOLE	
STORM INLET	
STORM END SECTION	
FIRE HYDRANT	
STREET LIGHT	

BENCHMARK INFORMATION:

CUT SQUARE ON BACK OF CURB AT INTERSECTION OF
NORTH ANCHOR BEND AND NORTH MARINERS CREST.
SQUARE IS AT THE NORTH EAST PORTION OF INTERSECTION
3' WEST OF A FIRE HYDRANT.
ELEVATION = 847.28 (NGVD 29)

ABBREVIATIONS:

BC	- BACK OF CURB
CL	- CENTERLINE
FG	- FINISHED GRADE
FL	- FLOW LINE
HP	- HIGH POINT
INV	- INVERT ELEVATION
LP	- LOW POINT
ME	- MATCH EXISTING GRADE
NP	- NORMAL POOL (ELEVATION)
PC	- POINT OF CURVATURE
PRC	- POINT OF REVERSE CURVATURE
PT	- POINT OF TANGENCY
PVC	- POLYVINYL CHLORIDE PIPE
PVI	- POINT OF VERTICAL INTERSECTION
RCP	- REINFORCED CONCRETE PIPE
R/W	- RIGHT-OF-WAY
BC	- TOP OF BANK GRADE
TC	- TOP OF CASTING GRADE
PAD	- PAD GRADE
MPPG	- MINIMUM FLOOD PROTECTION GRADE
MFPE	- MINIMUM FLOOR ELEVATION
TPW	- TOP OF WALL
IEE	- INGRESS / EGRESS EASEMENT
25	- LOT NUMBER
C.A.	- COMMON AREA
D.E.	- DRAINAGE EASEMENT
S.S.D.U.E.	- SANITARY SEWER, DRAINAGE AND UTILITY EASEMENT
D.U.E.	- DRAINAGE AND UTILITY EASEMENT
ESMT	- EASEMENT
B.S.L.	- BUILDING SETBACK LINE
R/W	- RIGHT-OF-WAY

Call 811 or 800-382-5544 Before you Dig!



0' 50' 100' 150'

(IN FEET)


By: knighton


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File Name: W:\Contractor Homes\2019-263-C Lemmer-Mccord Pointe Sec 7\Design\CAD\19263 Development Plan.dwg

Plot Time: 8:50am

Plot Date: Feb 15, 2021



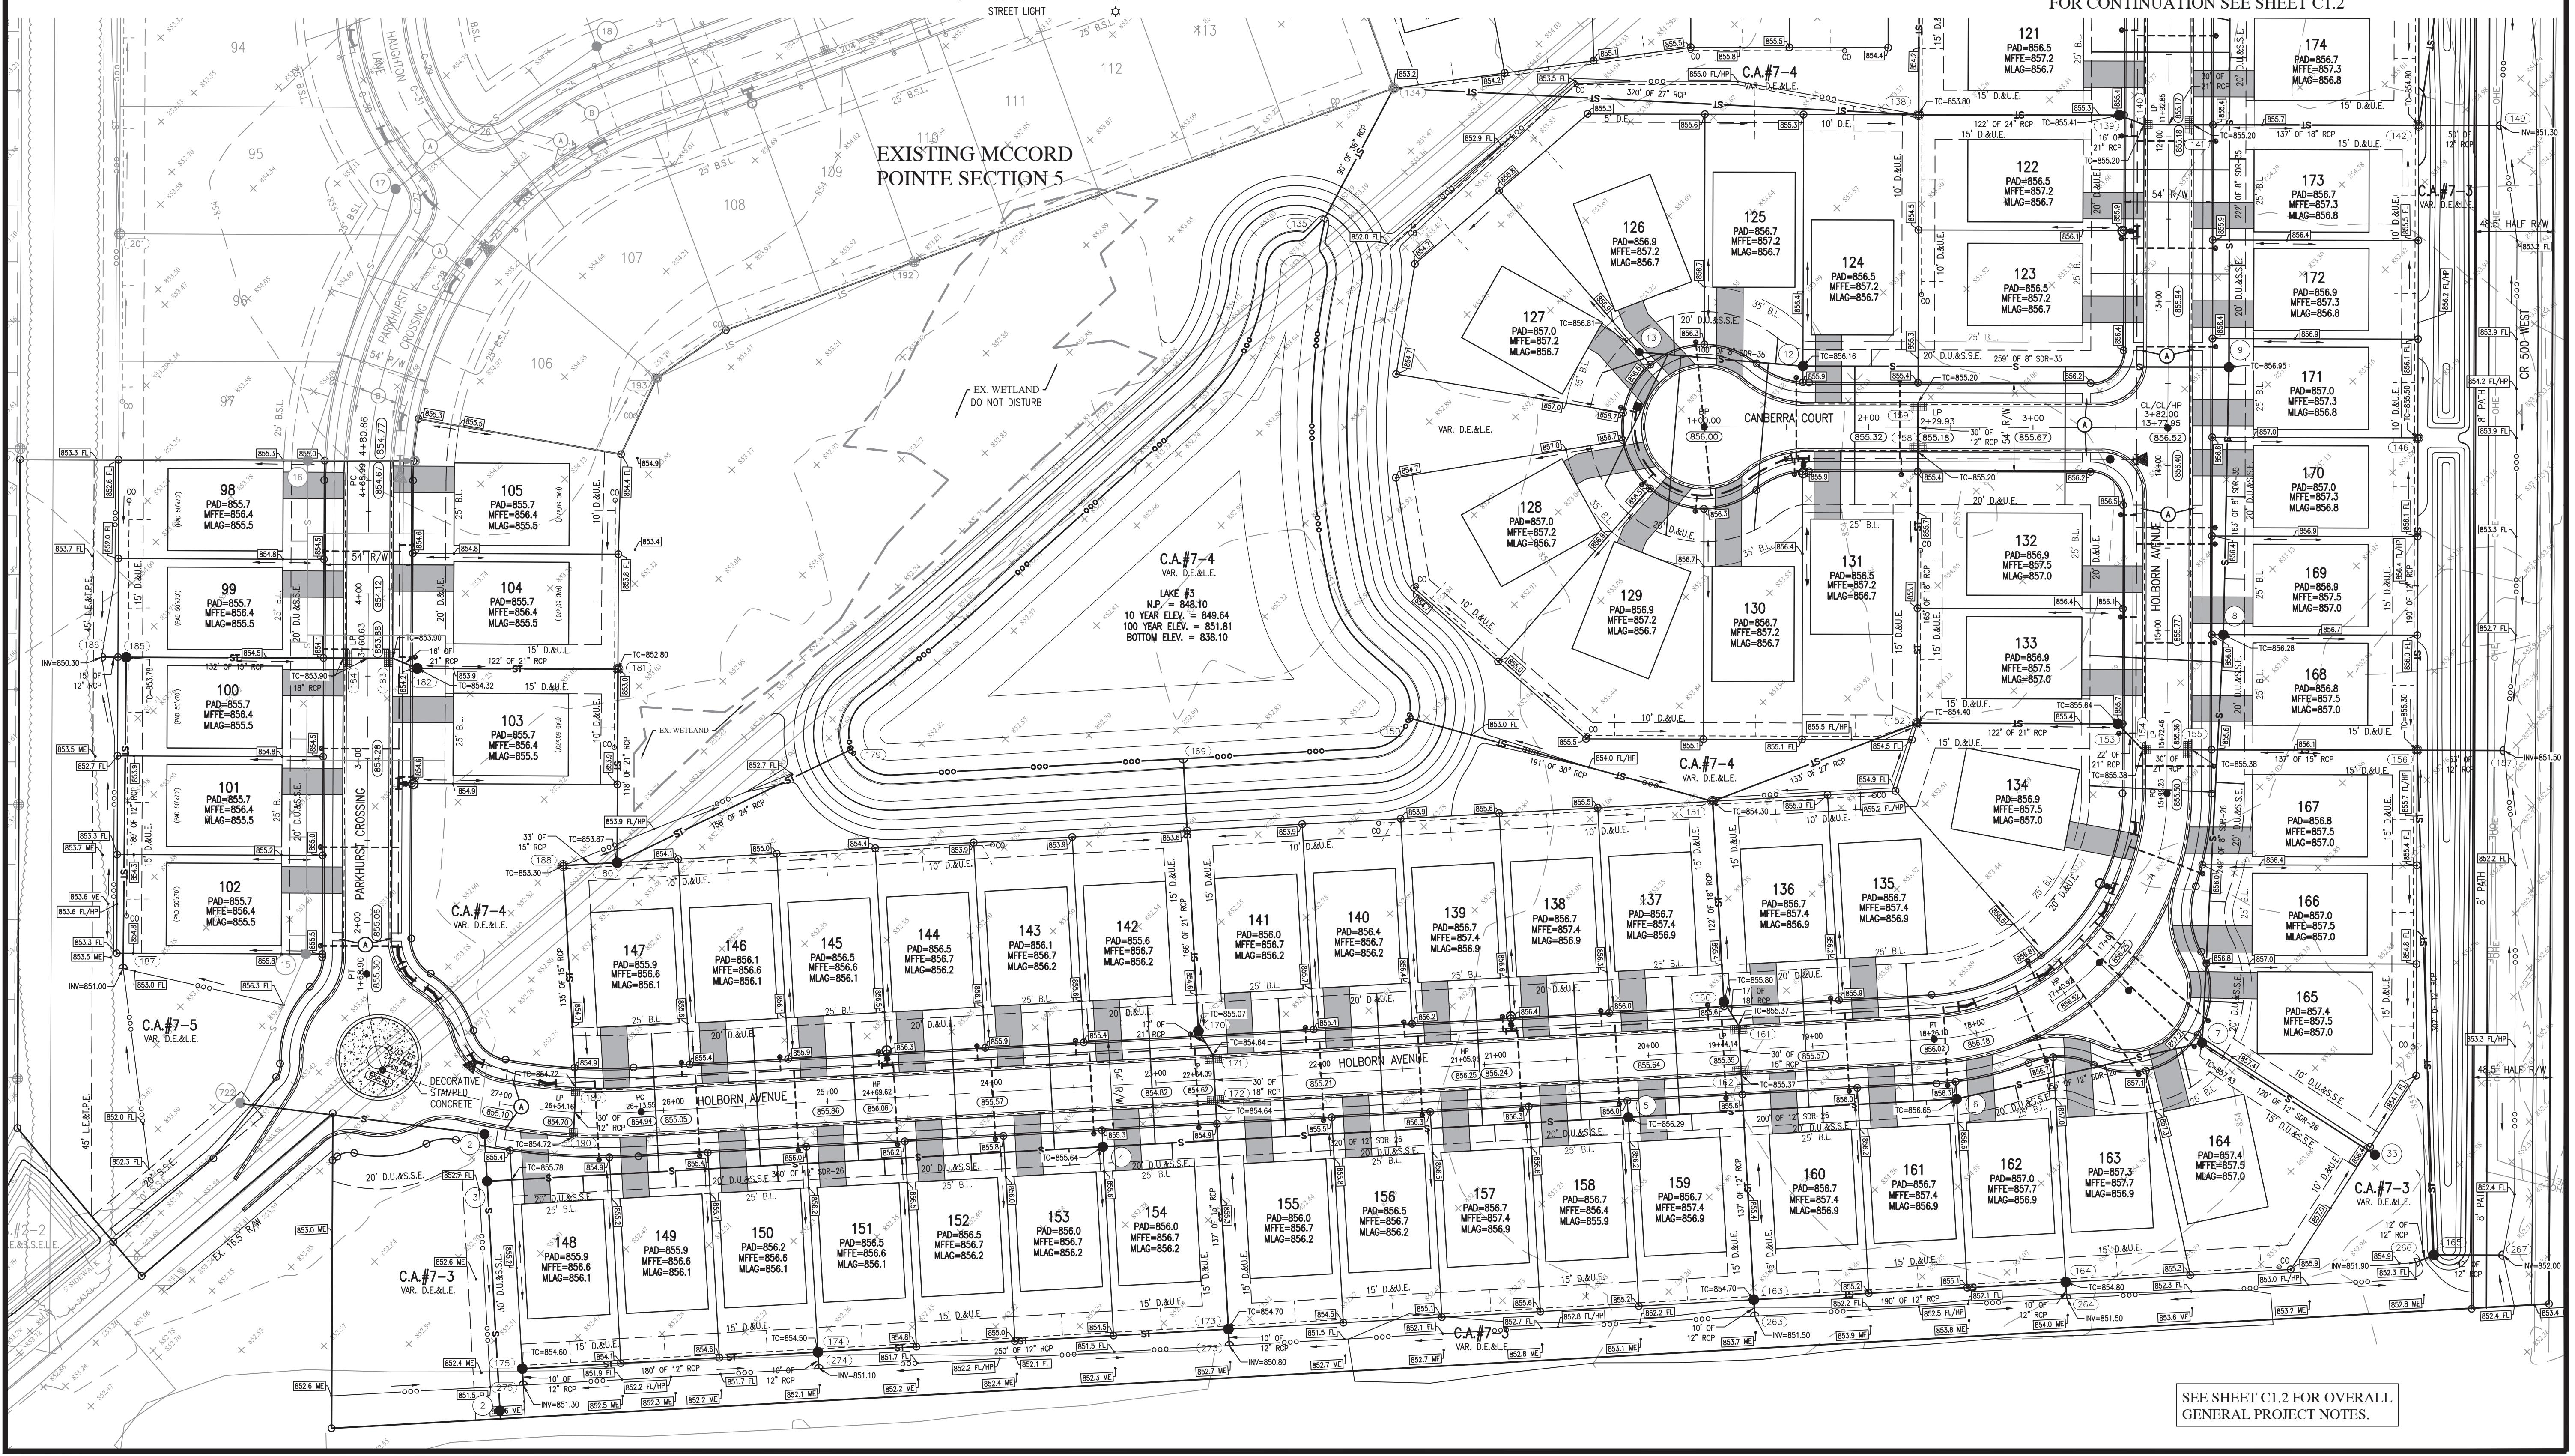
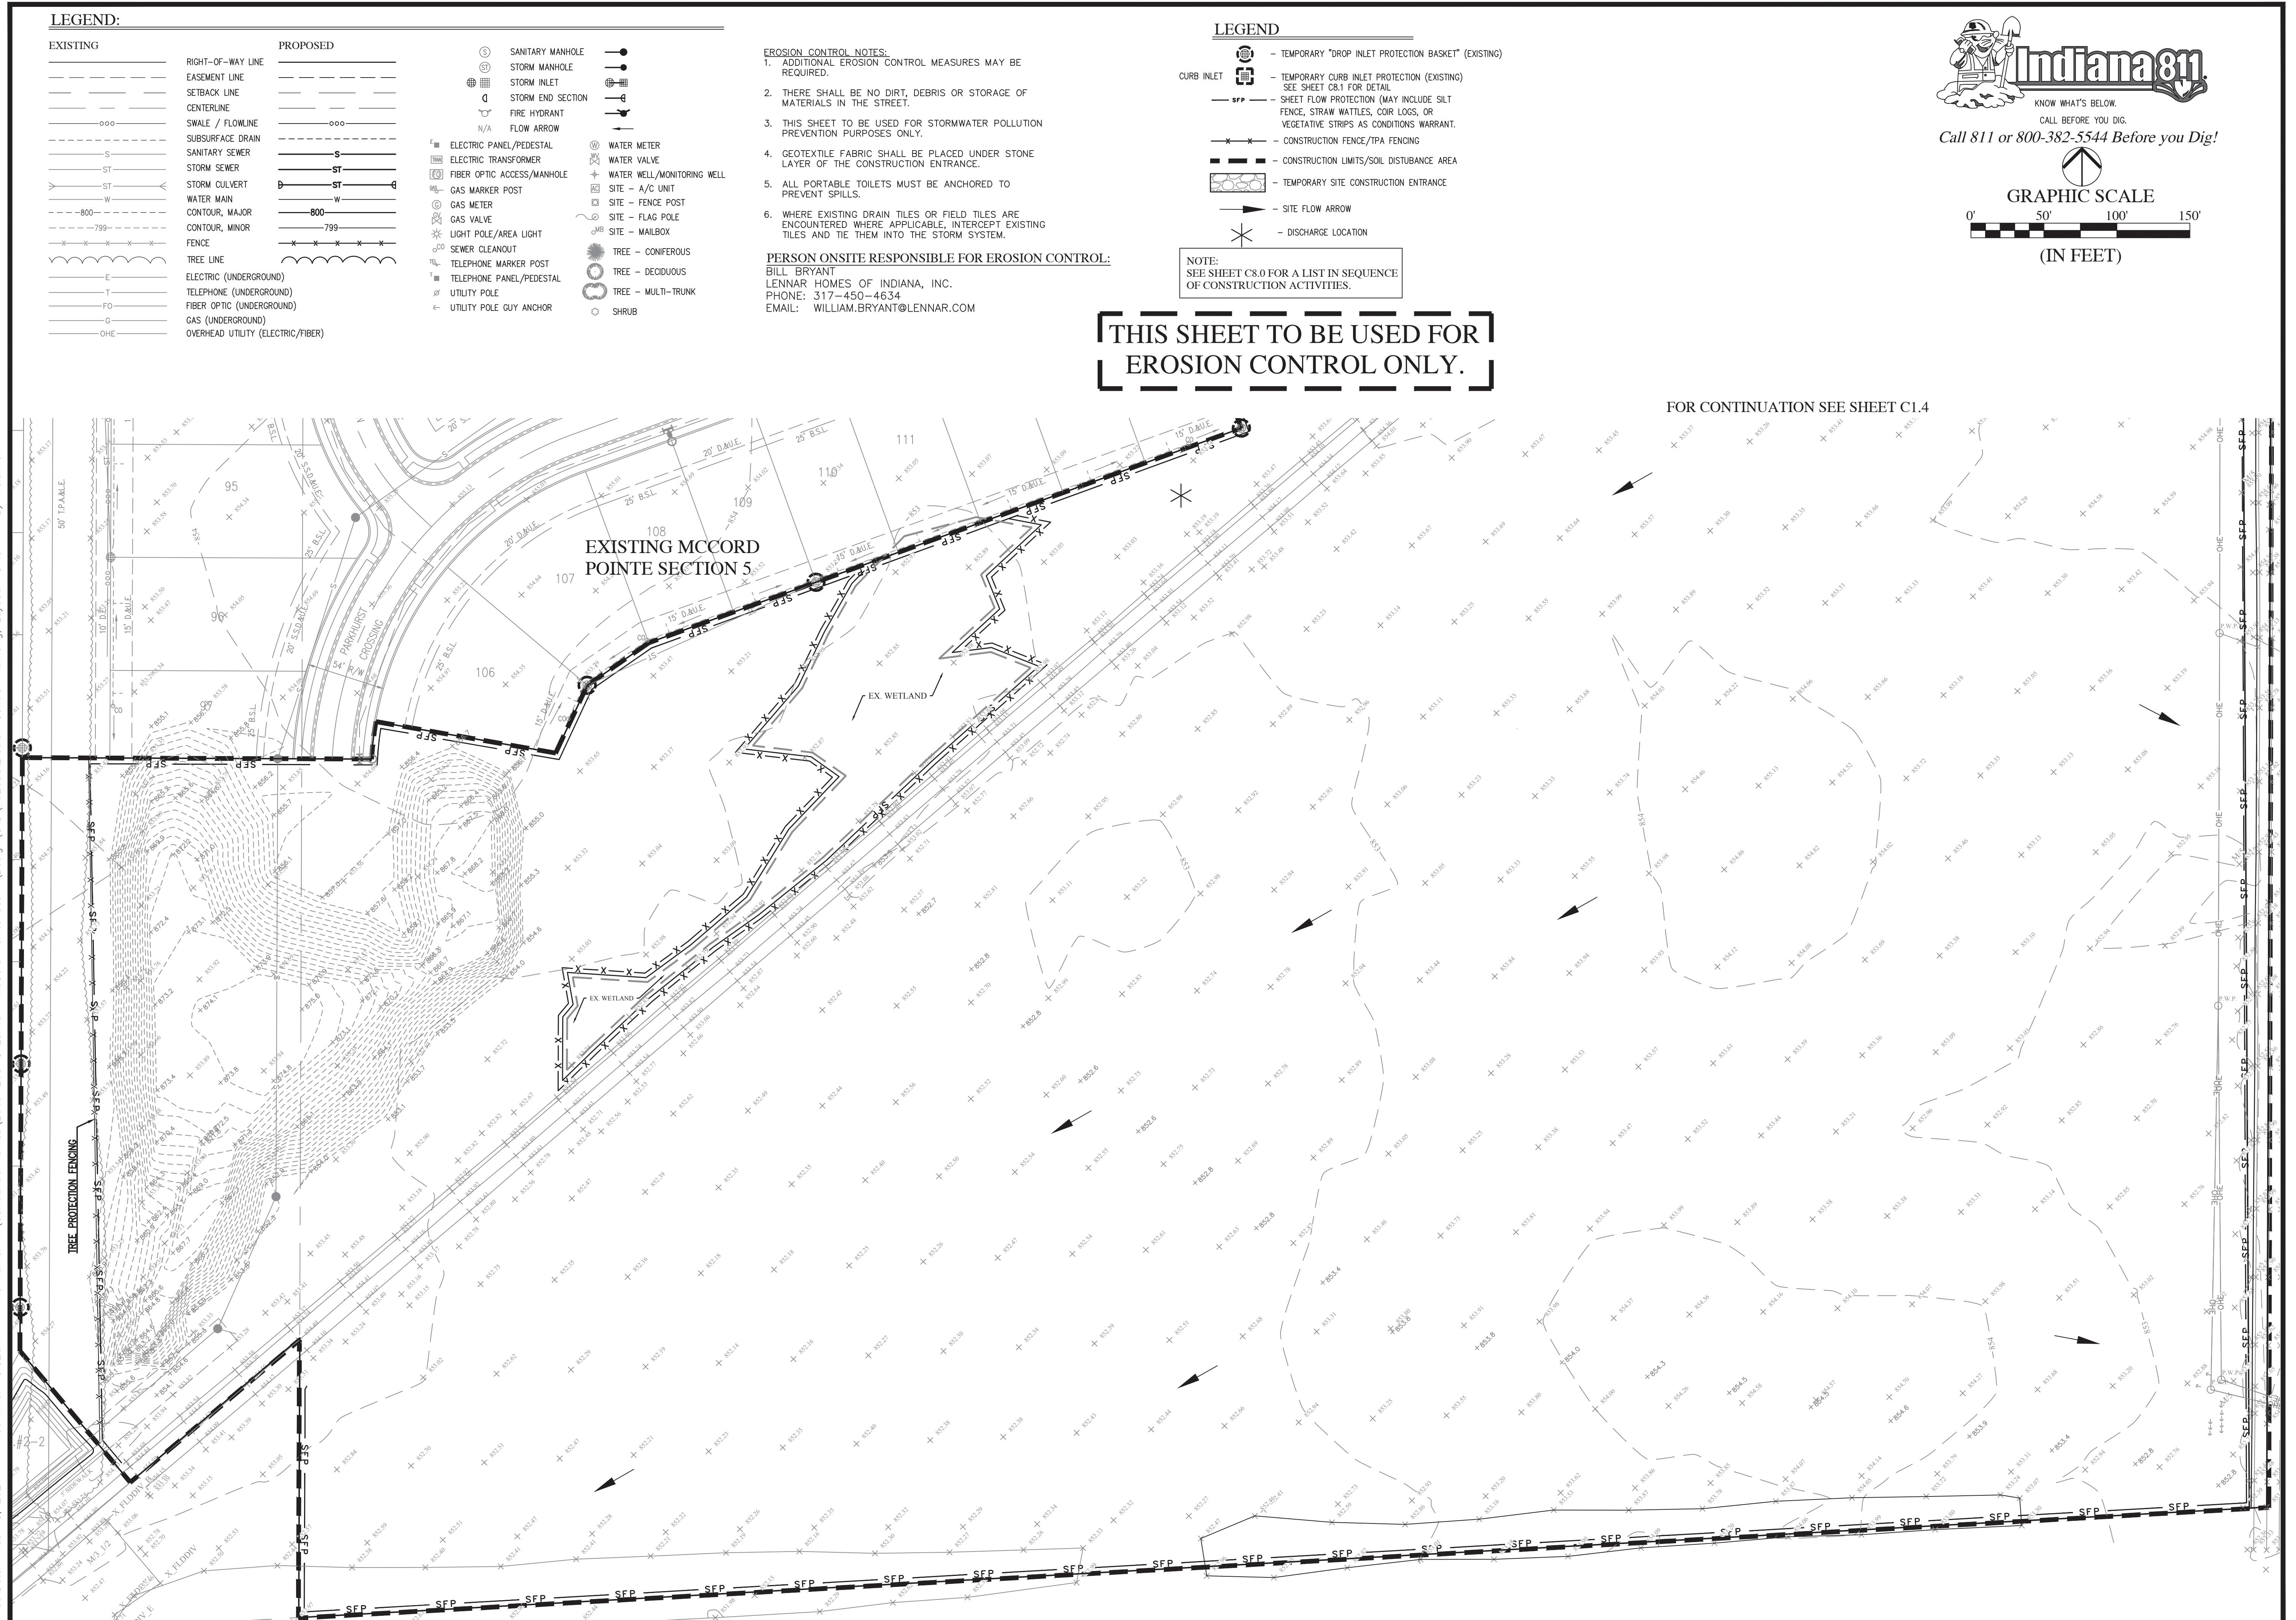
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GRAPHIC SCALE

0' 50' 100' 150'

(IN FEET)


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MCCORD POINTE SECTION 7 MCCORDSVILLE, INDIANA PRE-CONSTRUCTION STORMWATER POLLUTION PREVENTION PLAN



DRAWN BY
TS
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KE
DATE
NOVEMBER 2020
SCALE
AS SHOWN
JOB NUMBER
2019-263-G
SHEET

C1.3

PRE-CONSTRUCTION
STORMWATER POLLUTION
PREVENTION PLAN
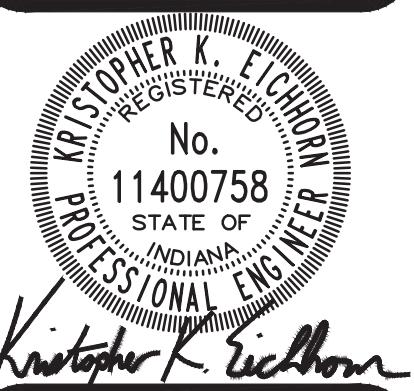
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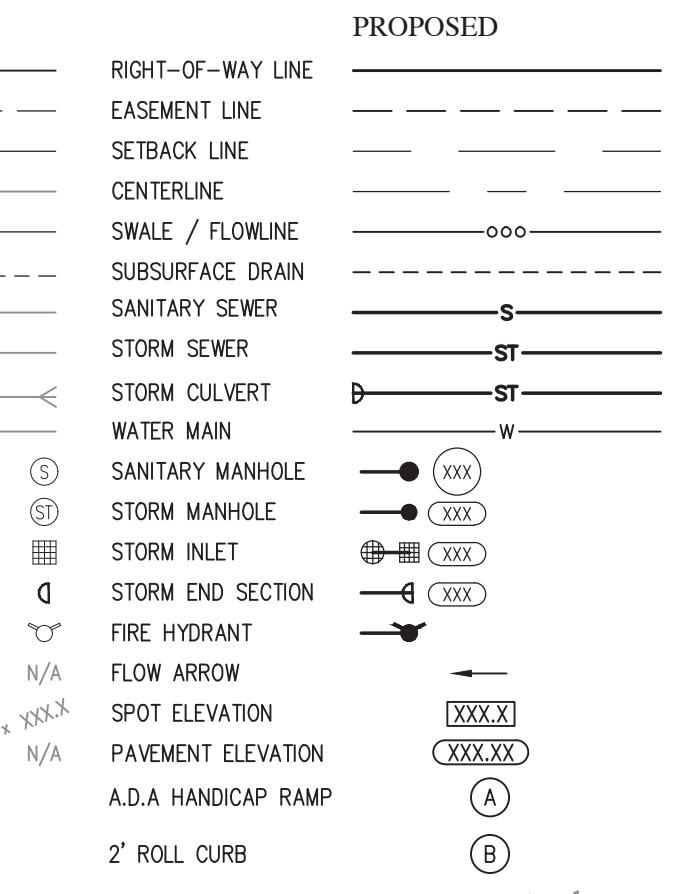
GRAPHIC SCALE

0' 20' 40' 60'

(IN FEET)

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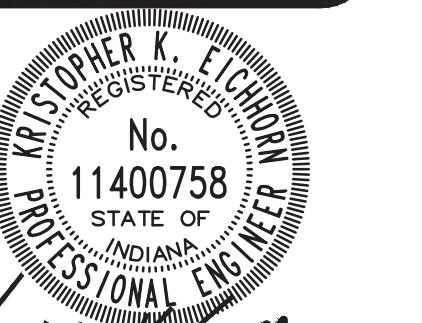
ABBREVIATIONS:

BR	BEGIN RADIUS
CL	CENTERLINE
GUT	GUTTER GRADE
HP	HIGH POINT
LP	LOW POINT
ME	MATCH EXISTING GRADE
PC	POINT OF CURVATURE
PT	POINT OF TANGENCY
PVI	POINT OF VERTICAL INTERSECTION
R	RADIUS
TC	TOP OF CURB/TOP OF CASTING GRADE

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MCCORD POINTE SECTION 7
MCCORDSVILLE, INDIANA


INTERSECTION DETAILS



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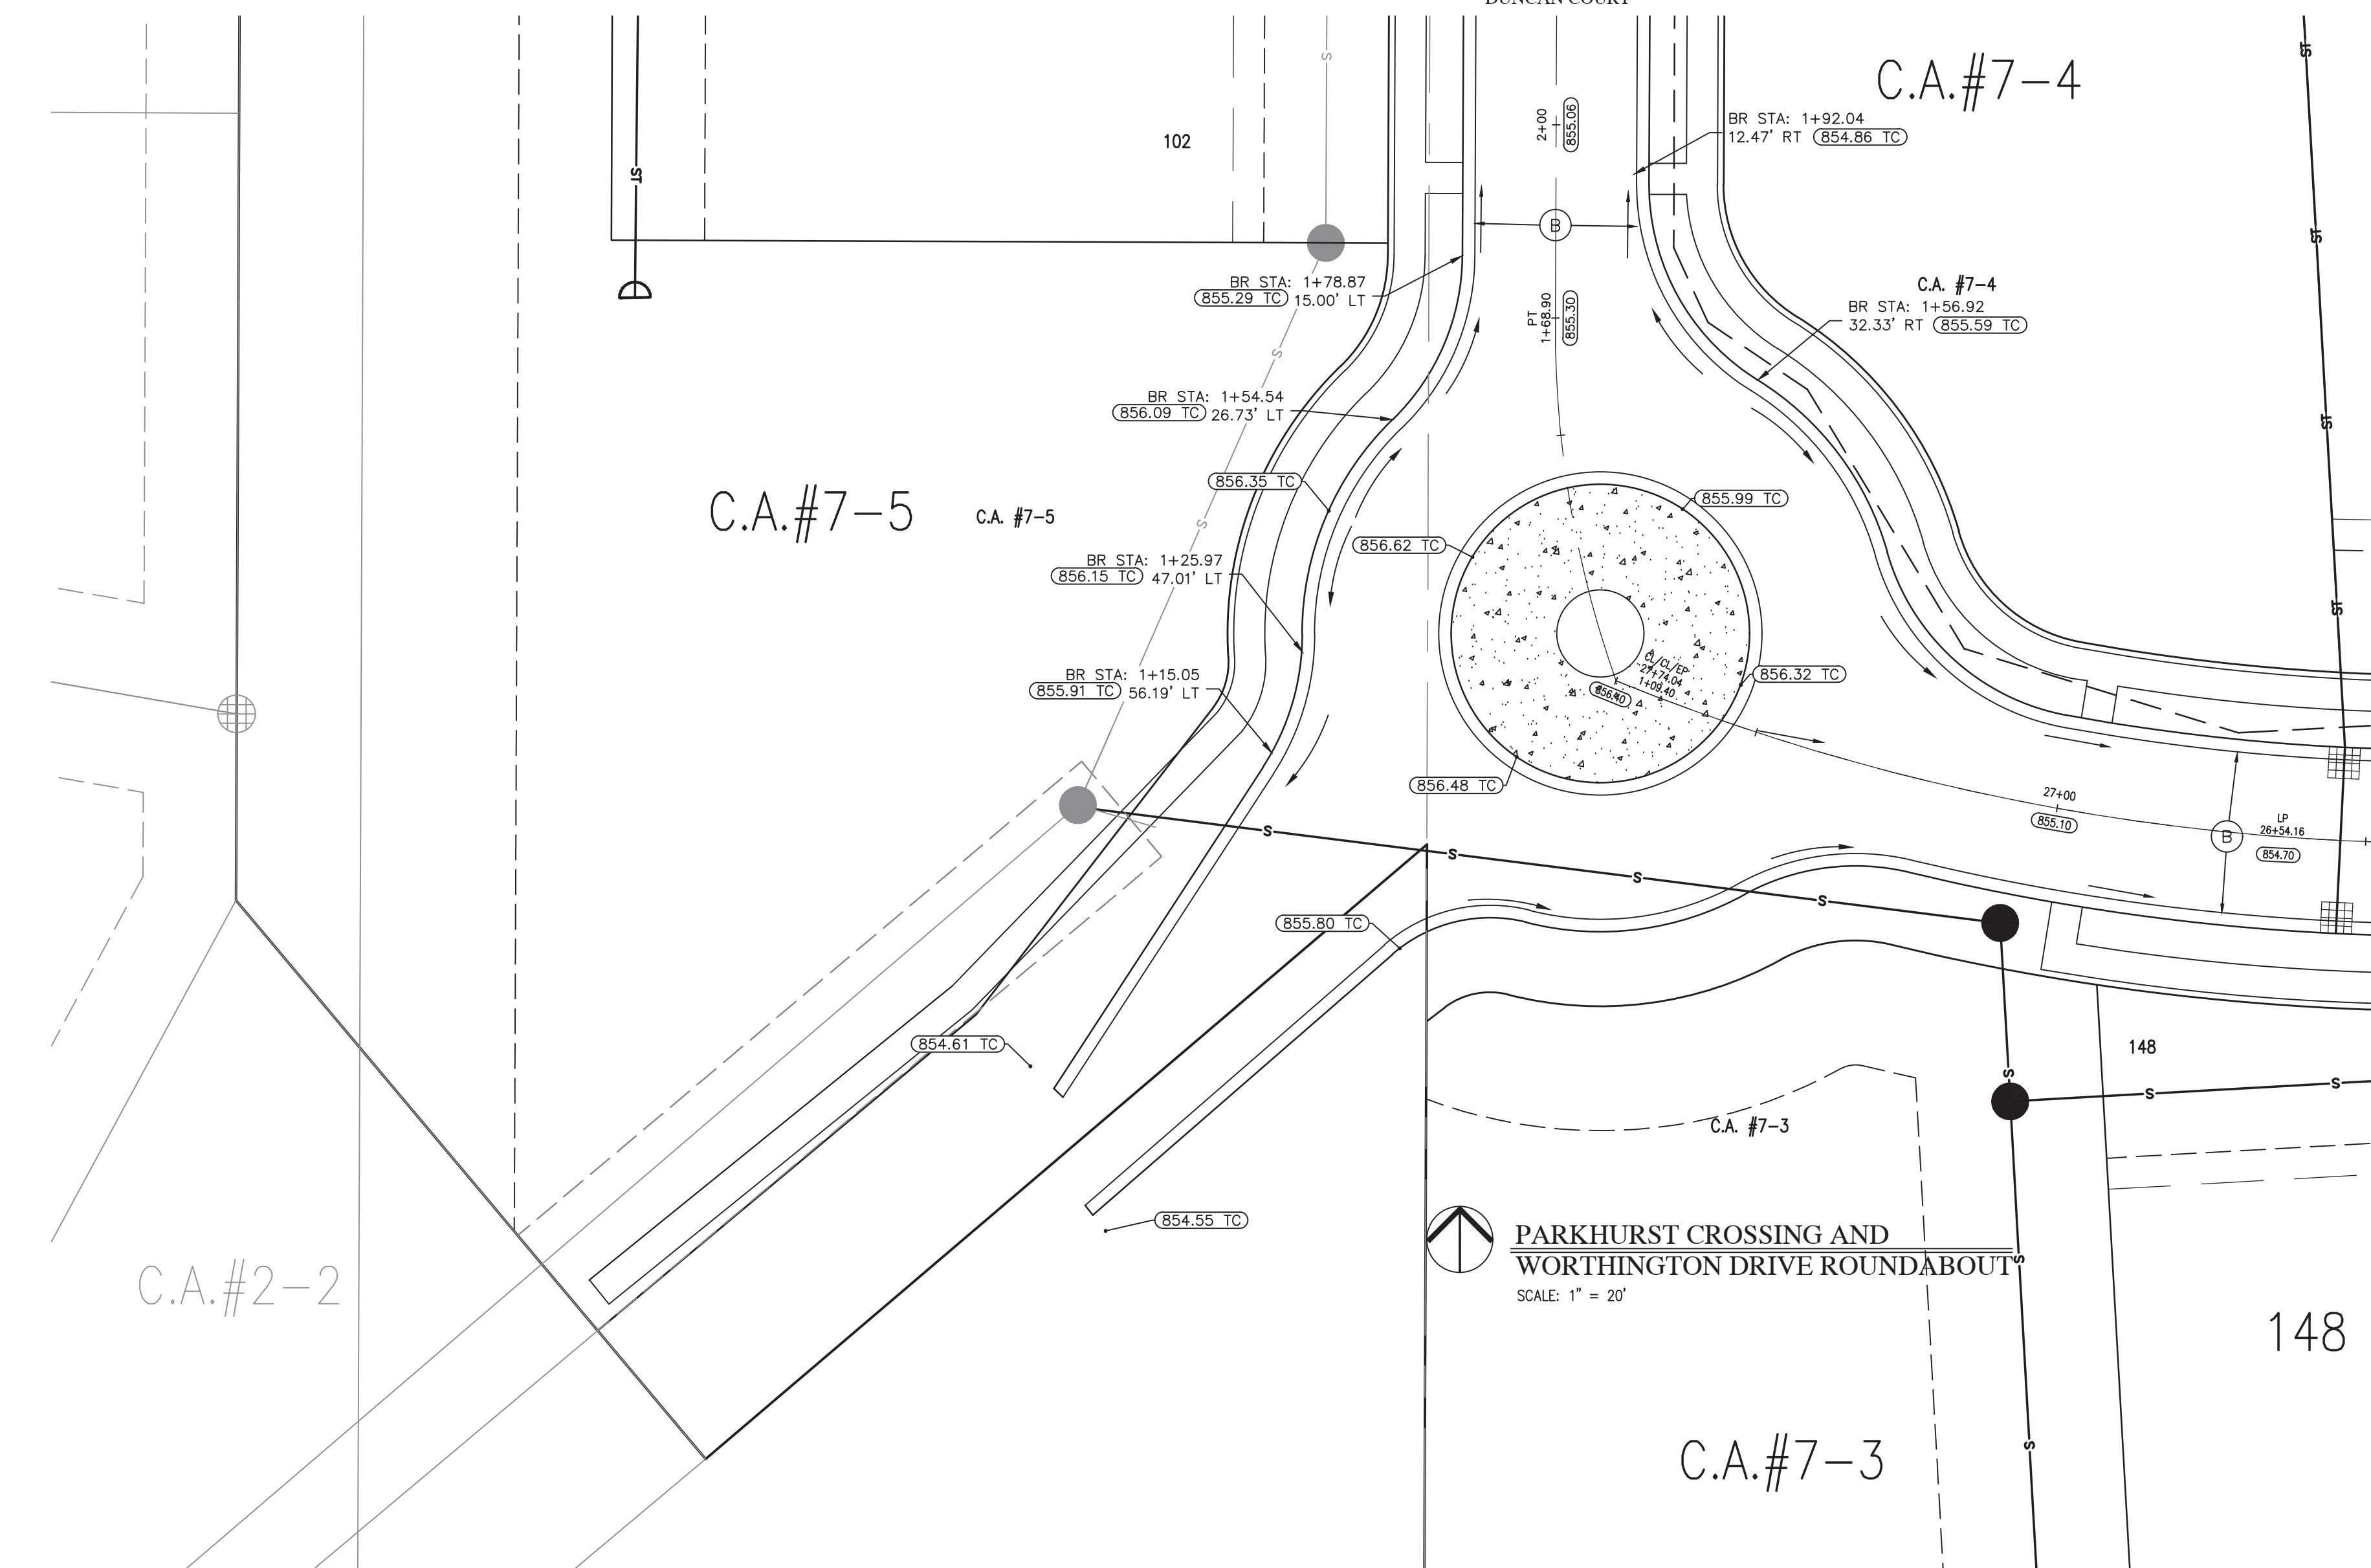
C3.1

INTERSECTION DETAILS

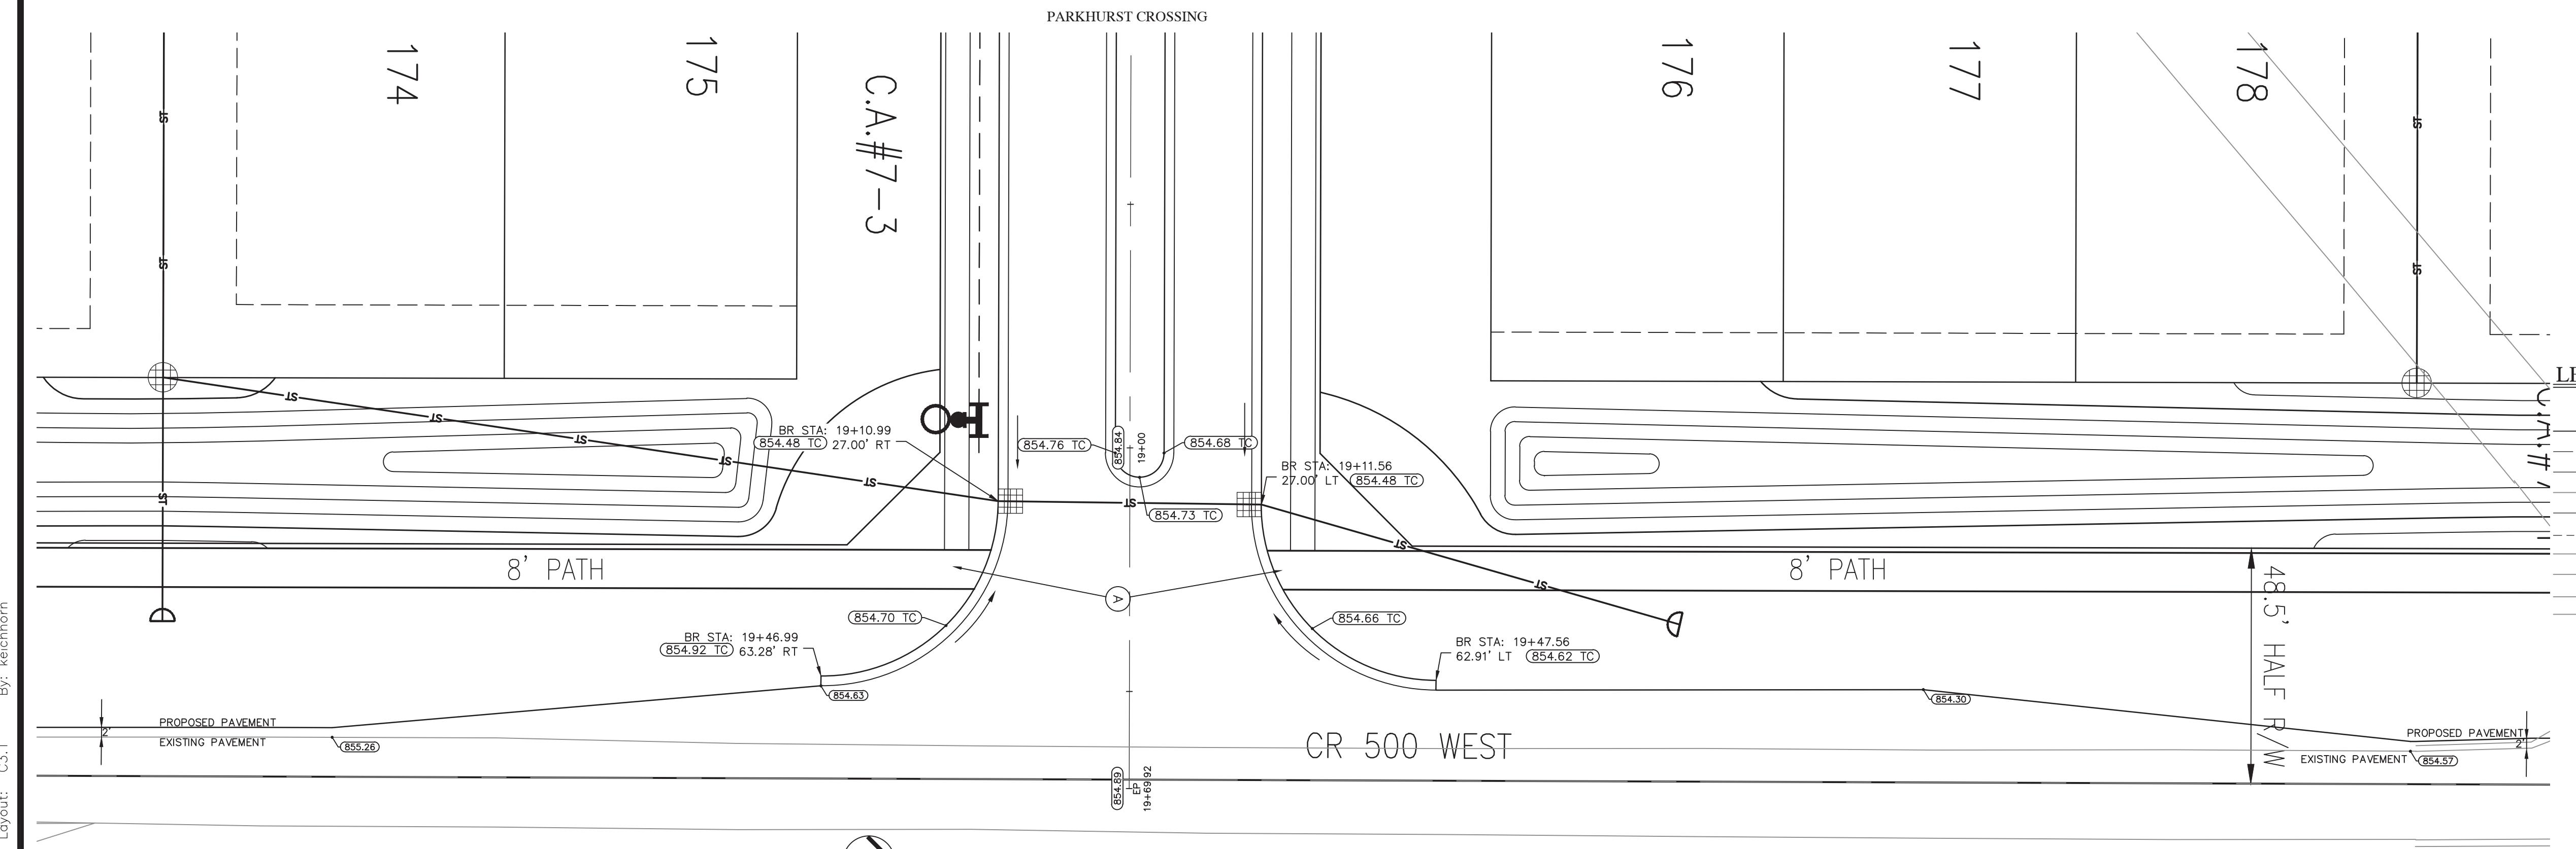

**CR 500 WEST AND PARKHURST CROSSING
ENTRANCE DETAIL**

SCALE: 1" = 20'



**PARKHURST CROSSING AND
WORTHINGTON DRIVE ROUNDABOUT**

SCALE: 1" = 20'

C.A.#7-3

148

REVISIONS



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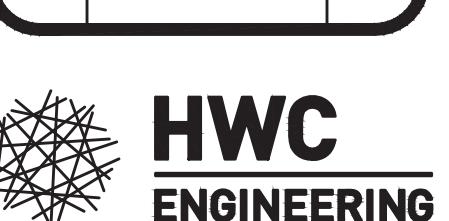
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0' 20' 40' 60'

(IN FEET)

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LEGEND:

PROPOSED	
—	RIGHT-OF-WAY LINE
- - -	EASEMENT LINE
—	SETBACK LINE
—	CENTERLINE
○○○	SWALE / FLOWLINE
—	SUBSURFACE DRAIN
S	SANITARY SEWER
ST	STORM SEWER
ST	STORM CULVERT
W	WATER MAIN
(S)	SANITARY MANHOLE
(S)	STORM MANHOLE
(S)	STORM INLET
(S)	STORM END SECTION
D	FIRE HYDRANT
—	FLOW ARROW
XXX	SPOT ELEVATION
XXX	PAVEMENT ELEVATION
N/A	A.D.A HANDICAP RAMP
—	2' ROLL CURB

ABBREVIATIONS:


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MCCORD POINTE SECTION 7
MCCORDSVILLE, INDIANA

CR 500 W ROAD WIDENING PLAN



CR 500 WEST WIDENING

SCALE: 1" = 100'

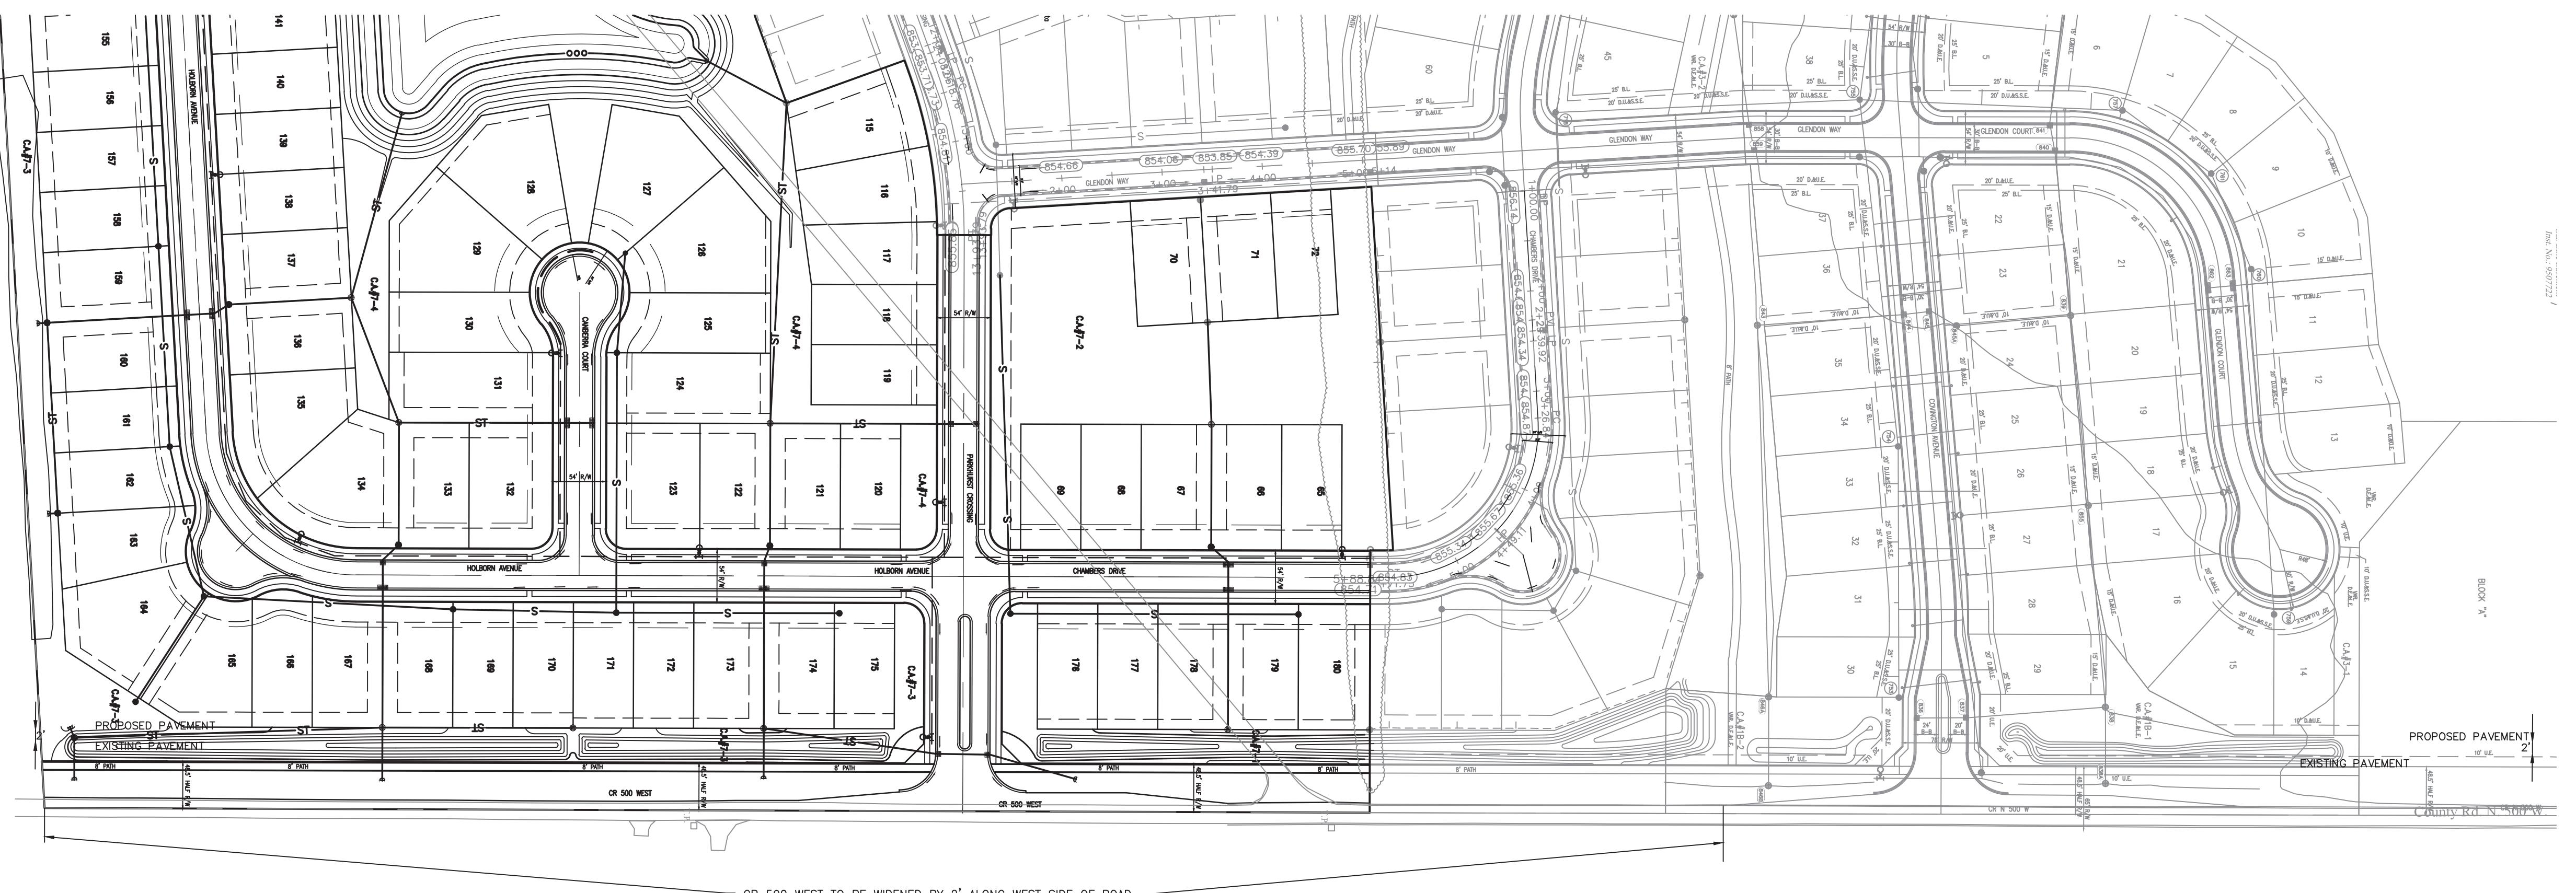

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CR 500 W ROAD WIDENING
PLAN

REVISIONS


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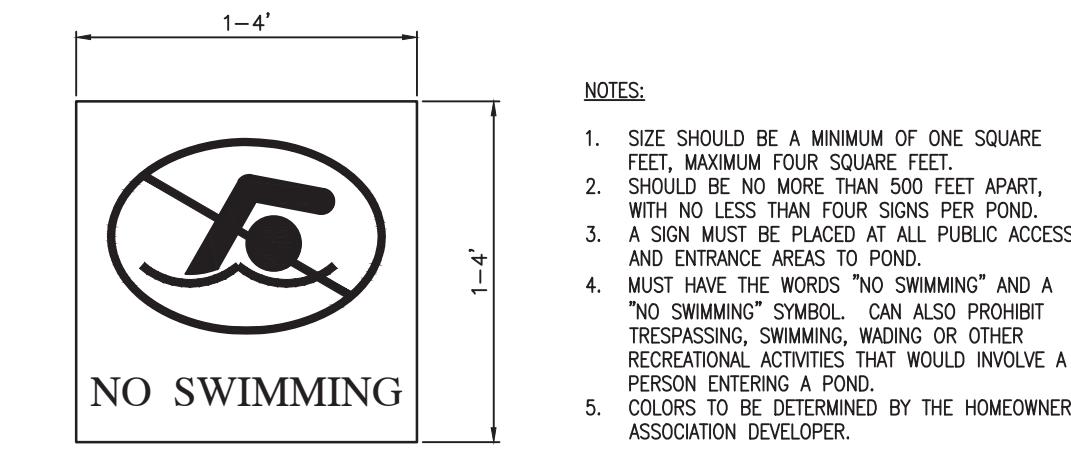
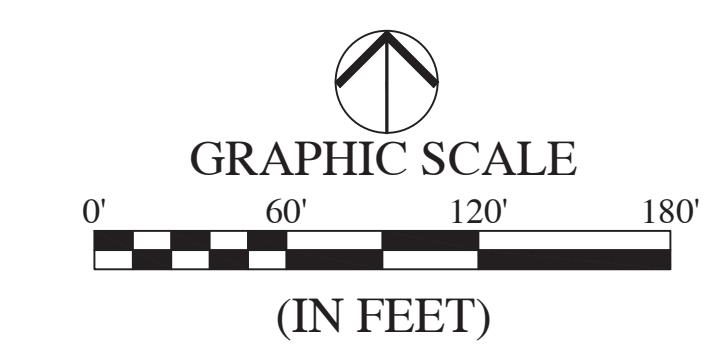
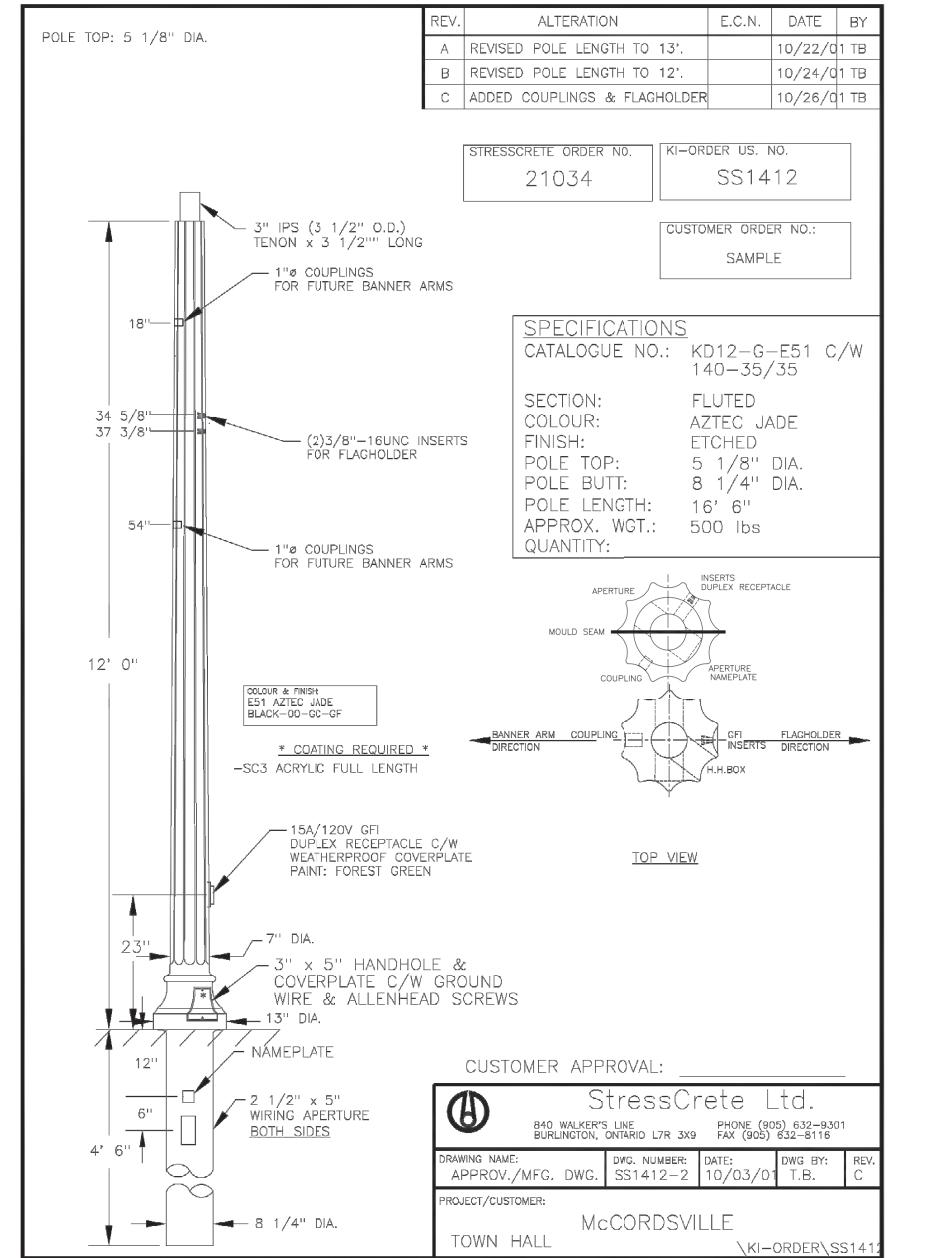
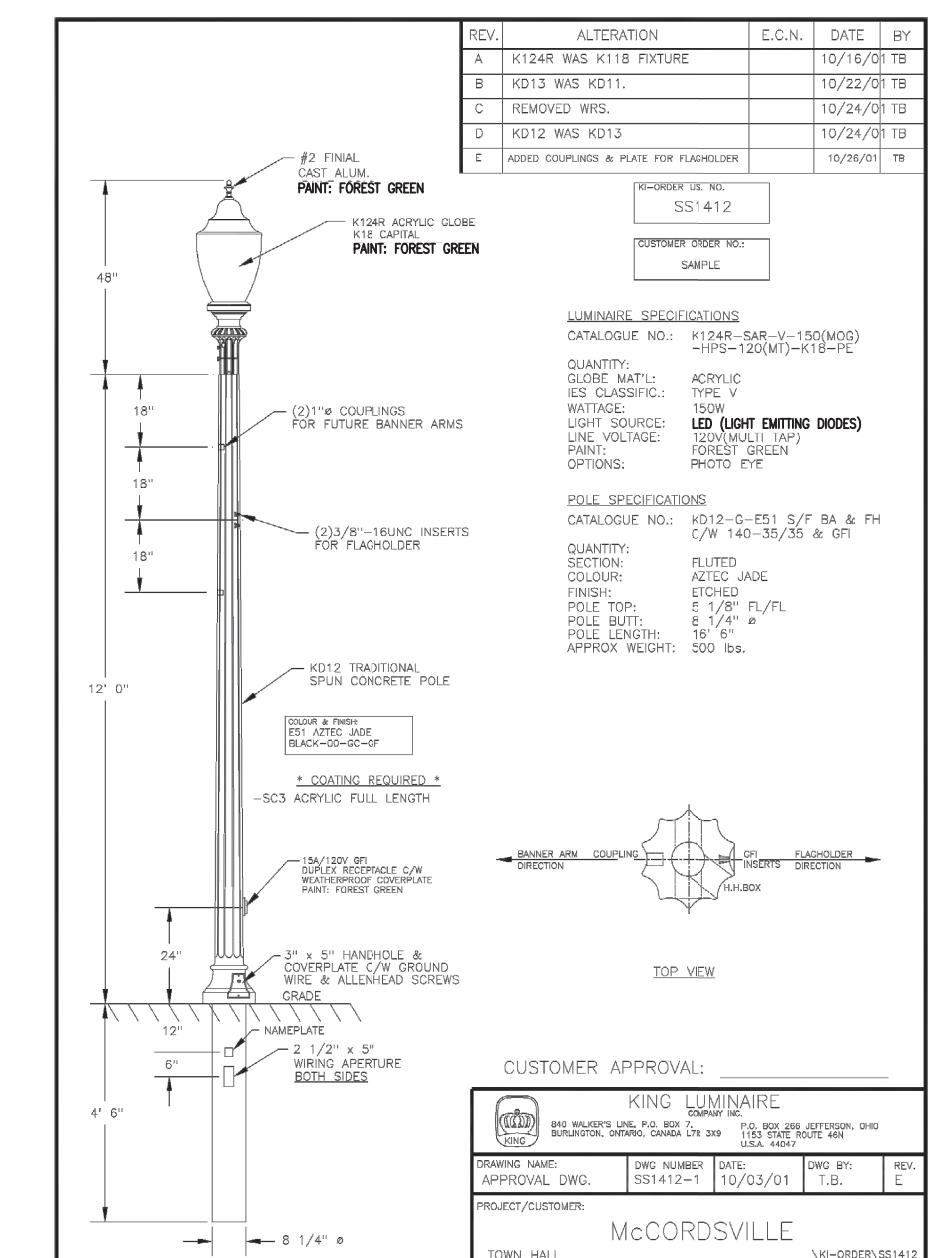
MCCORD POINTE SECTION 7 MCCORDSVILLE, INDIANA

TRAFFIC CONTROL PLAN




GENERAL NOTES

1. LIGHTING, SIGNS, IRRIGATION LINES, ETC. MUST BE CONSTRUCTED TO MAINTAIN A MINIMUM HORIZONTAL SEPARATION OF TEN (10) FEET FROM THE CENTER OF THE SANITARY SEWER FACILITIES.
2. STREET LIGHTS ARE REQUIRED TO MATCH EXISTING STREET LIGHTS, TO INCLUDE POLE TYPE, FIXTURE TYPE, HEIGHT OF FIXTURE ETC.
3. ALL STREET LIGHTING SHALL BE INSTALLED WITH REFLECTORS OR OTHER SUCH DEVICES OR CONTROLS SO THAT LIGHT IS REFLECTED DOWNWARD TO MITIGATE LIGHT SPILLOVER. ALL STREET LIGHTS ARE TO BE FULL CUT-OFF AND DARK SKY COMPLIANT.

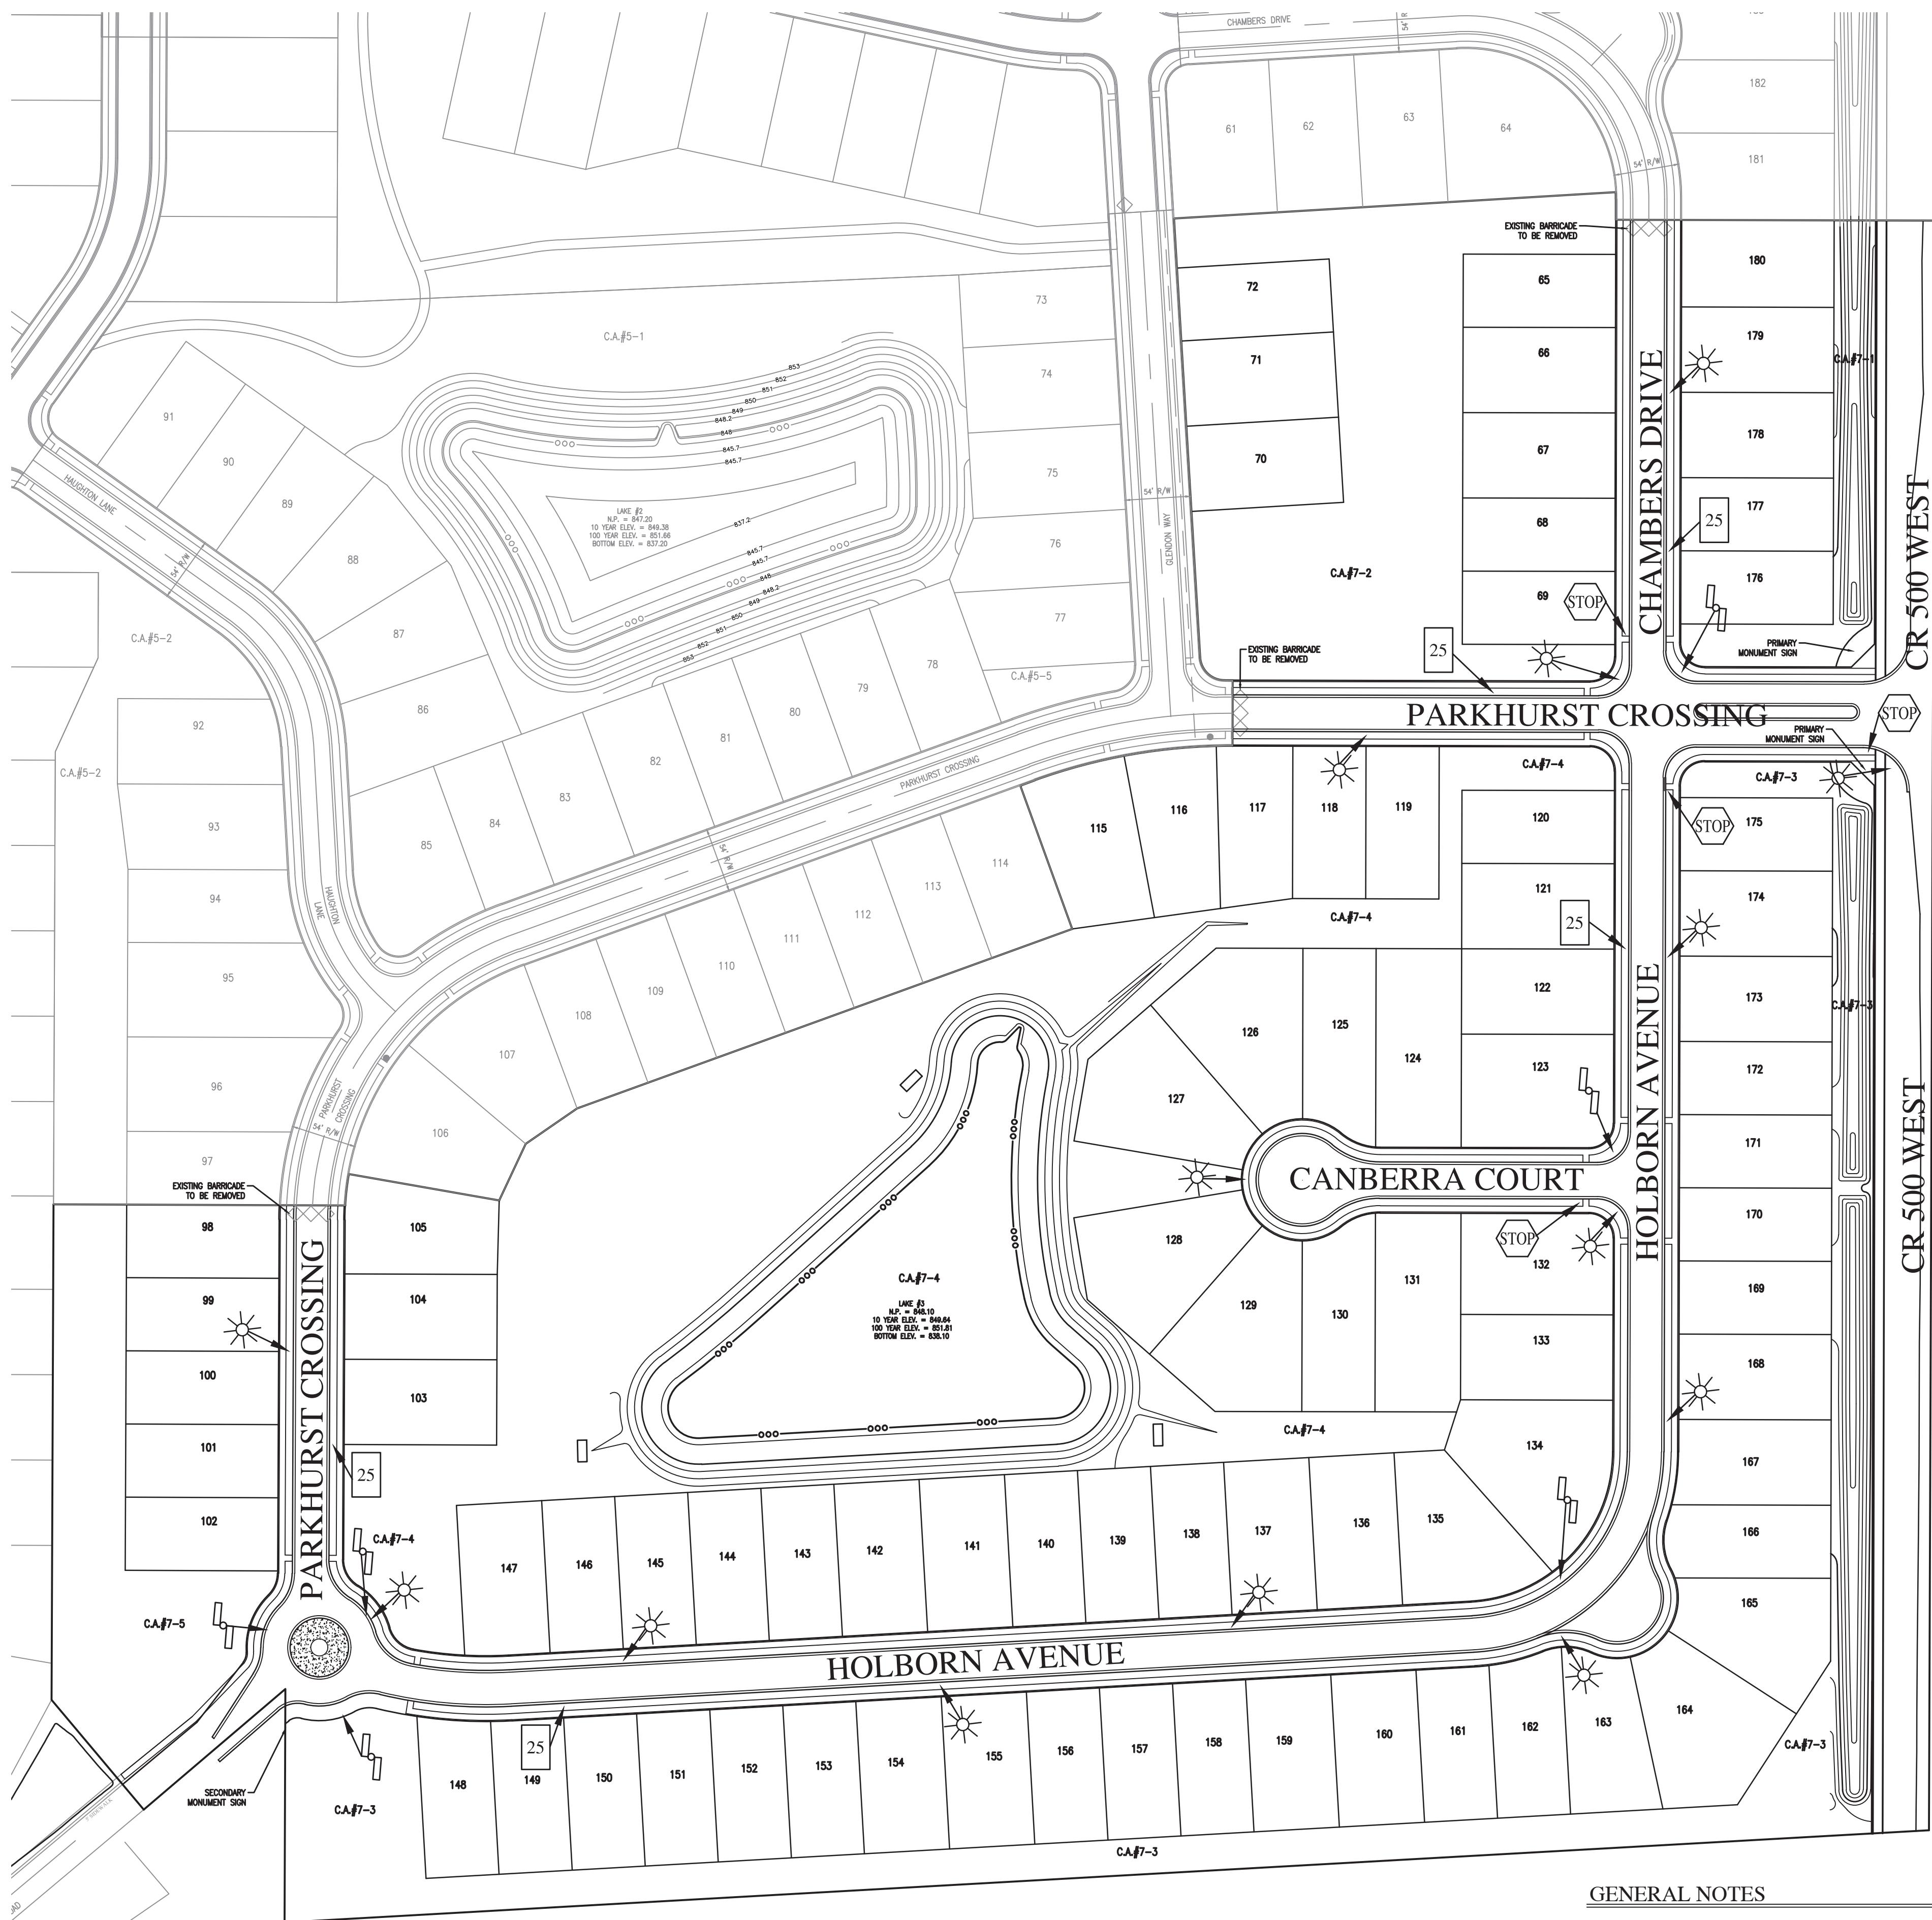

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C3.3

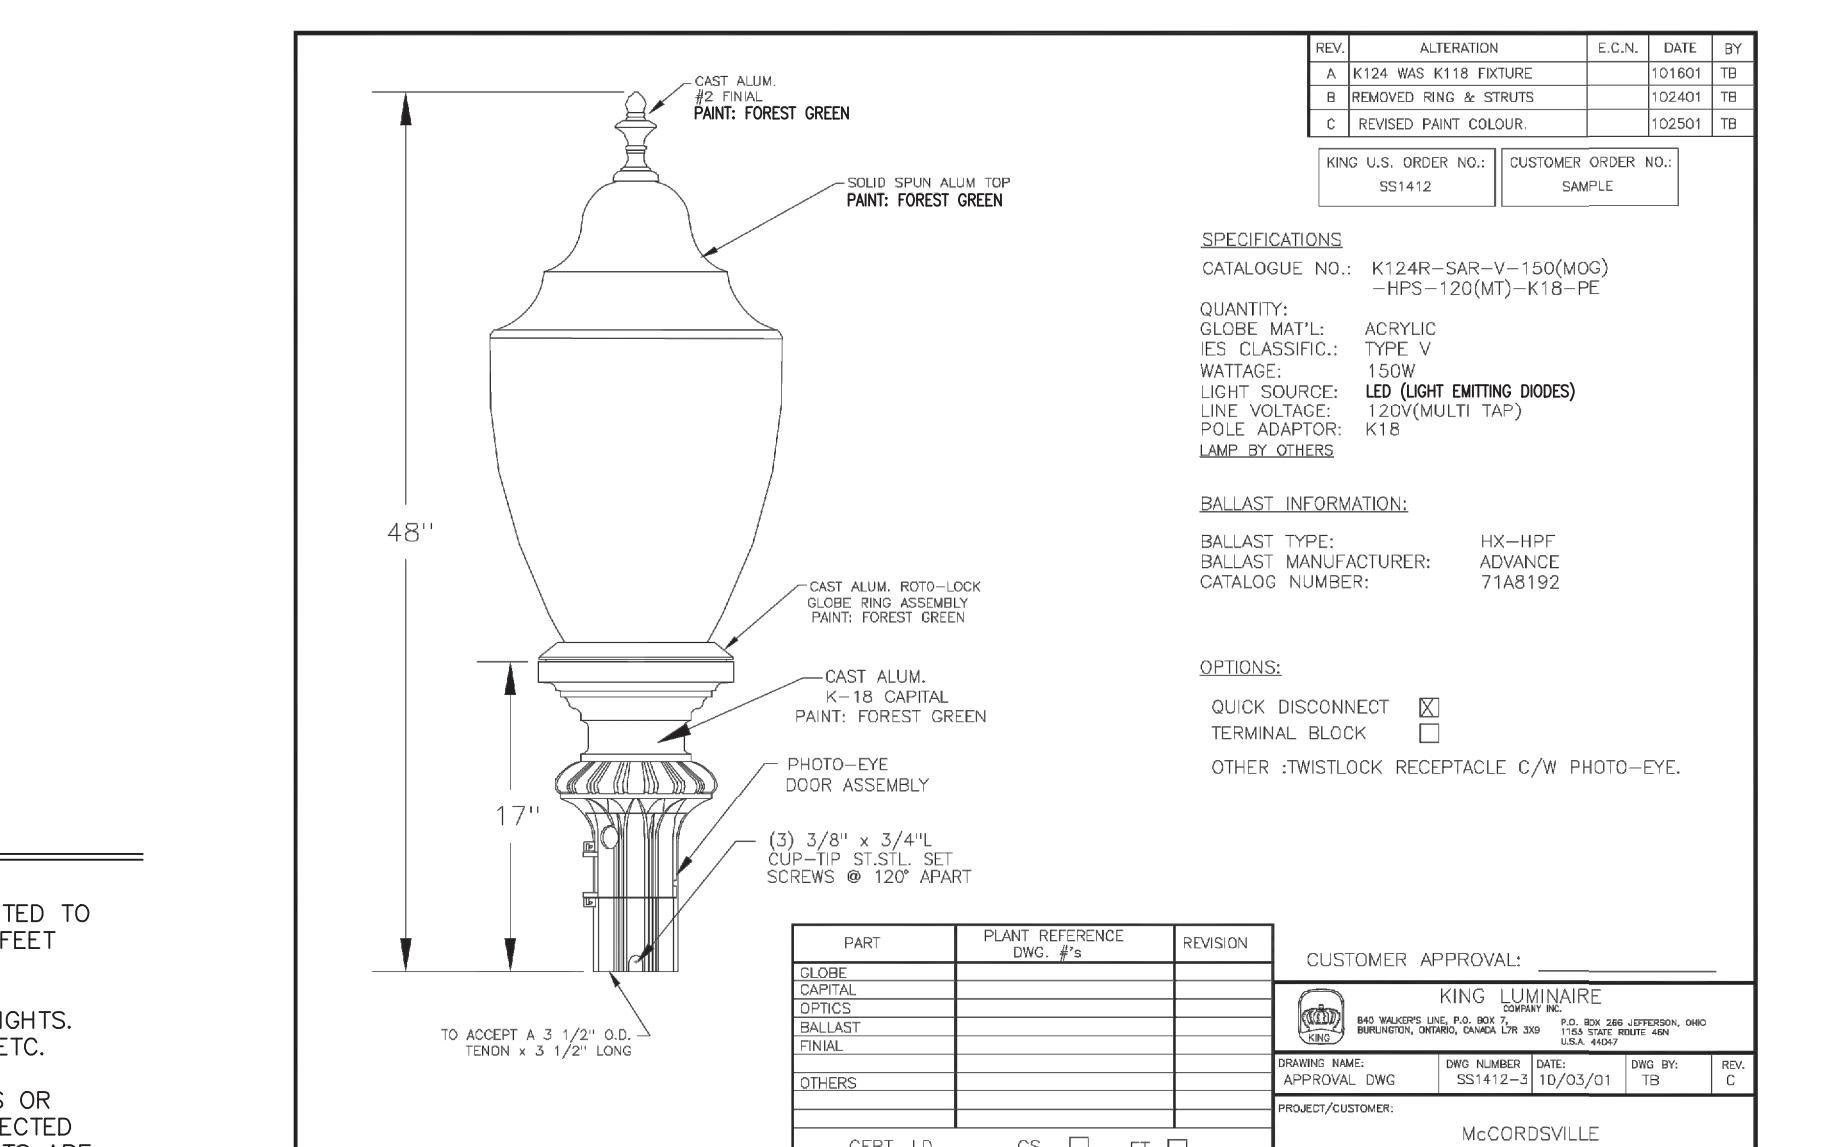TRAFFIC CONTROL PLAN

PLANT MATERIAL SCHEDULE

KEY	BOTANICAL NAME	COMMON NAME	QUANTITY	SIZE	REMARKS
AS	ACER SCCHARUM 'LEGACY'	LEGACY SUGAR MAPLE	36	2" B&B	CENTRAL LEADER, HEADED UP TO 4' MIN
CV	CRATEAGUS VIRDIS 'WINTER KING'	WINTER KING HAWTHORN	20	2" B&B	GOOD BRANCH STRUCTURE HEADED UP TO 4' MIN
PA	PICEA ABIES	NORWAY SPRUCE	97	6" B&B	SINGLE LEADER, FULL, MATCHING SPECIMENS
PV	PRUNUS VIRGINIANA 'CANADA RED'	CANADA RED CHokeCHERRY	26	2" B&B	CENTRAL LEADER, HEADED UP TO 4' MIN
CAL	CALAMAGROSTIS ACUTIFLORA 'KARL FOERSTER'	KARL FOERSTER FEATHER REED GRASS	4	CONT	#1 POT

NOTE:

SUPPLEMENTAL TREE PLANTINGS AT A RATE OF 5 TREES PER ACRE
ARE REQUIRED

LANDSCAPE LEGEND:

KEY	QUANTITY / KEY
---	ENTRY MONUMENT
----	PERENNIAL BED
(○)	SHADE TREE
(●)	EVERGREEN TREE
(◎)	ORNAMENTAL TREE
(○)	DECIDUOUS SHRUB
(●)	GRASSES

LEGEND:

EXISTING	PROPOSED
—	RIGHT-OF-WAY LINE
—	EASEMENT LINE
—	SETBACK LINE
—	CENTERLINE
—	SWALE / FLOWLINE
—	SUBSURFACE DRAIN
—	SANITARY SEWER
—	STORM SEWER
—	STORM CULVERT
—	WATER MAIN
—	CONTOUR, MAJOR
—	CONTOUR, MINOR
—	FENCE
—	TREE LINE
—	SANITARY MANHOLE
—	STORM MANHOLE
—	STORM INLET
—	STORM END SECTION
—	FIRE HYDRANT
—	STREET LIGHT
—	STREET
—	800
—	799
—	798
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PLANT MATERIAL SCHEDULE

KEY	BOTANICAL NAME	COMMON NAME	QUANTITY	SIZE	REMARKS
AS	ACER SCCHARUM 'LEGACY'	LEGACY SUGAR MAPLE	36	2" B&B	CENTRAL LEADER, HEADED UP TO 4' MIN
CV	CRATEAGUS VIRDIS 'WINTER KING'	WINTER KING HAWTHORN	20	2" B&B	GOOD BRANCH STRUCTURE HEADED UP TO 4' MIN
PA	PICEA ABIES	NORWAY SPRUCE	97	6" B&B	SINGLE LEADER, FULL, MATCHING SPECIMENS
PV	PRUNUS VIRGINIANA 'CANADA RED'	CANADA RED CHokeCHERRY	26	2" B&B	CENTRAL LEADER, HEADED UP TO 4' MIN

NOTE:

SUPPLEMENTAL TREE PLANTINGS AT A RATE OF 5 TREES PER ACRE
ARE REQUIRED

By: kreichhorn
Plot Time: 9:10am
File Name: W:\Coquihalla Homes\2019-263-C_Lennar - McCord Pointe Sec 7\Design\CAD\19263C Landscape Plan.dwg, Layout: L1.1

LANDSCAPE LEGEND:

# XXX	QUANTITY / KEY
—	ENTRY MONUMENT
—	PERENNIAL BED
○	SHADE TREE
○	EVERGREEN TREE
○	ORNAMENTAL TREE
○	DECIDUOUS SHRUB
○	GRASSES

LEGEND:

EXISTING	PROPOSED
—	RIGHT-OF-WAY LINE
—	EASEMENT LINE
—	SETBACK LINE
—	CENTERLINE
—	SWALE / FLOWLINE
—	SUBSURFACE DRAIN
—	SANITARY SEWER
—	STORM SEWER
—	STORM CULVERT
—	WATER MAIN
—	WATER MAIN CONTOUR, MAJOR
—	WATER MAIN CONTOUR, MINOR
—	FENCE
—	TREE LINE
—	SANITARY MANHOLE
—	STORM MANHOLE
—	STORM INLET
—	STORM END SECTION
—	FIRE HYDRANT
—	STREET LIGHT



KNOW WHAT'S BELOW.
CALL BEFORE YOU DIG.

Call 811 or 800-382-5544 Before you Dig!



GRAPHIC SCALE

0' 50' 100' 150'
(IN FEET)


REVISIONS

DATE	DESCRIPTION	BY
1/5/21	REVISED PER TAC REVIEW	HWC

HWC
ENGINEERING

INDIANAPOLIS - TERRE HAUTE
LAFAYETTE - MUNCIE - NEW ALBANY
www.hwcengineering.com


MCCORD POINTE SECTION 7 MCCORDSVILLE, INDIANA

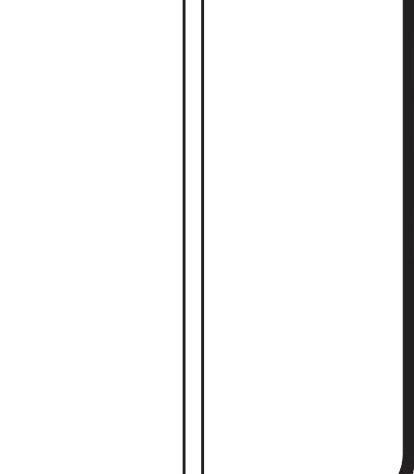

DRAWN BY TS/TD/GM	CHECKED BY KE
DATE NOVEMBER 2020	SCALE AS SHOWN
SHEET	

L1.1

LANDSCAPE PLAN

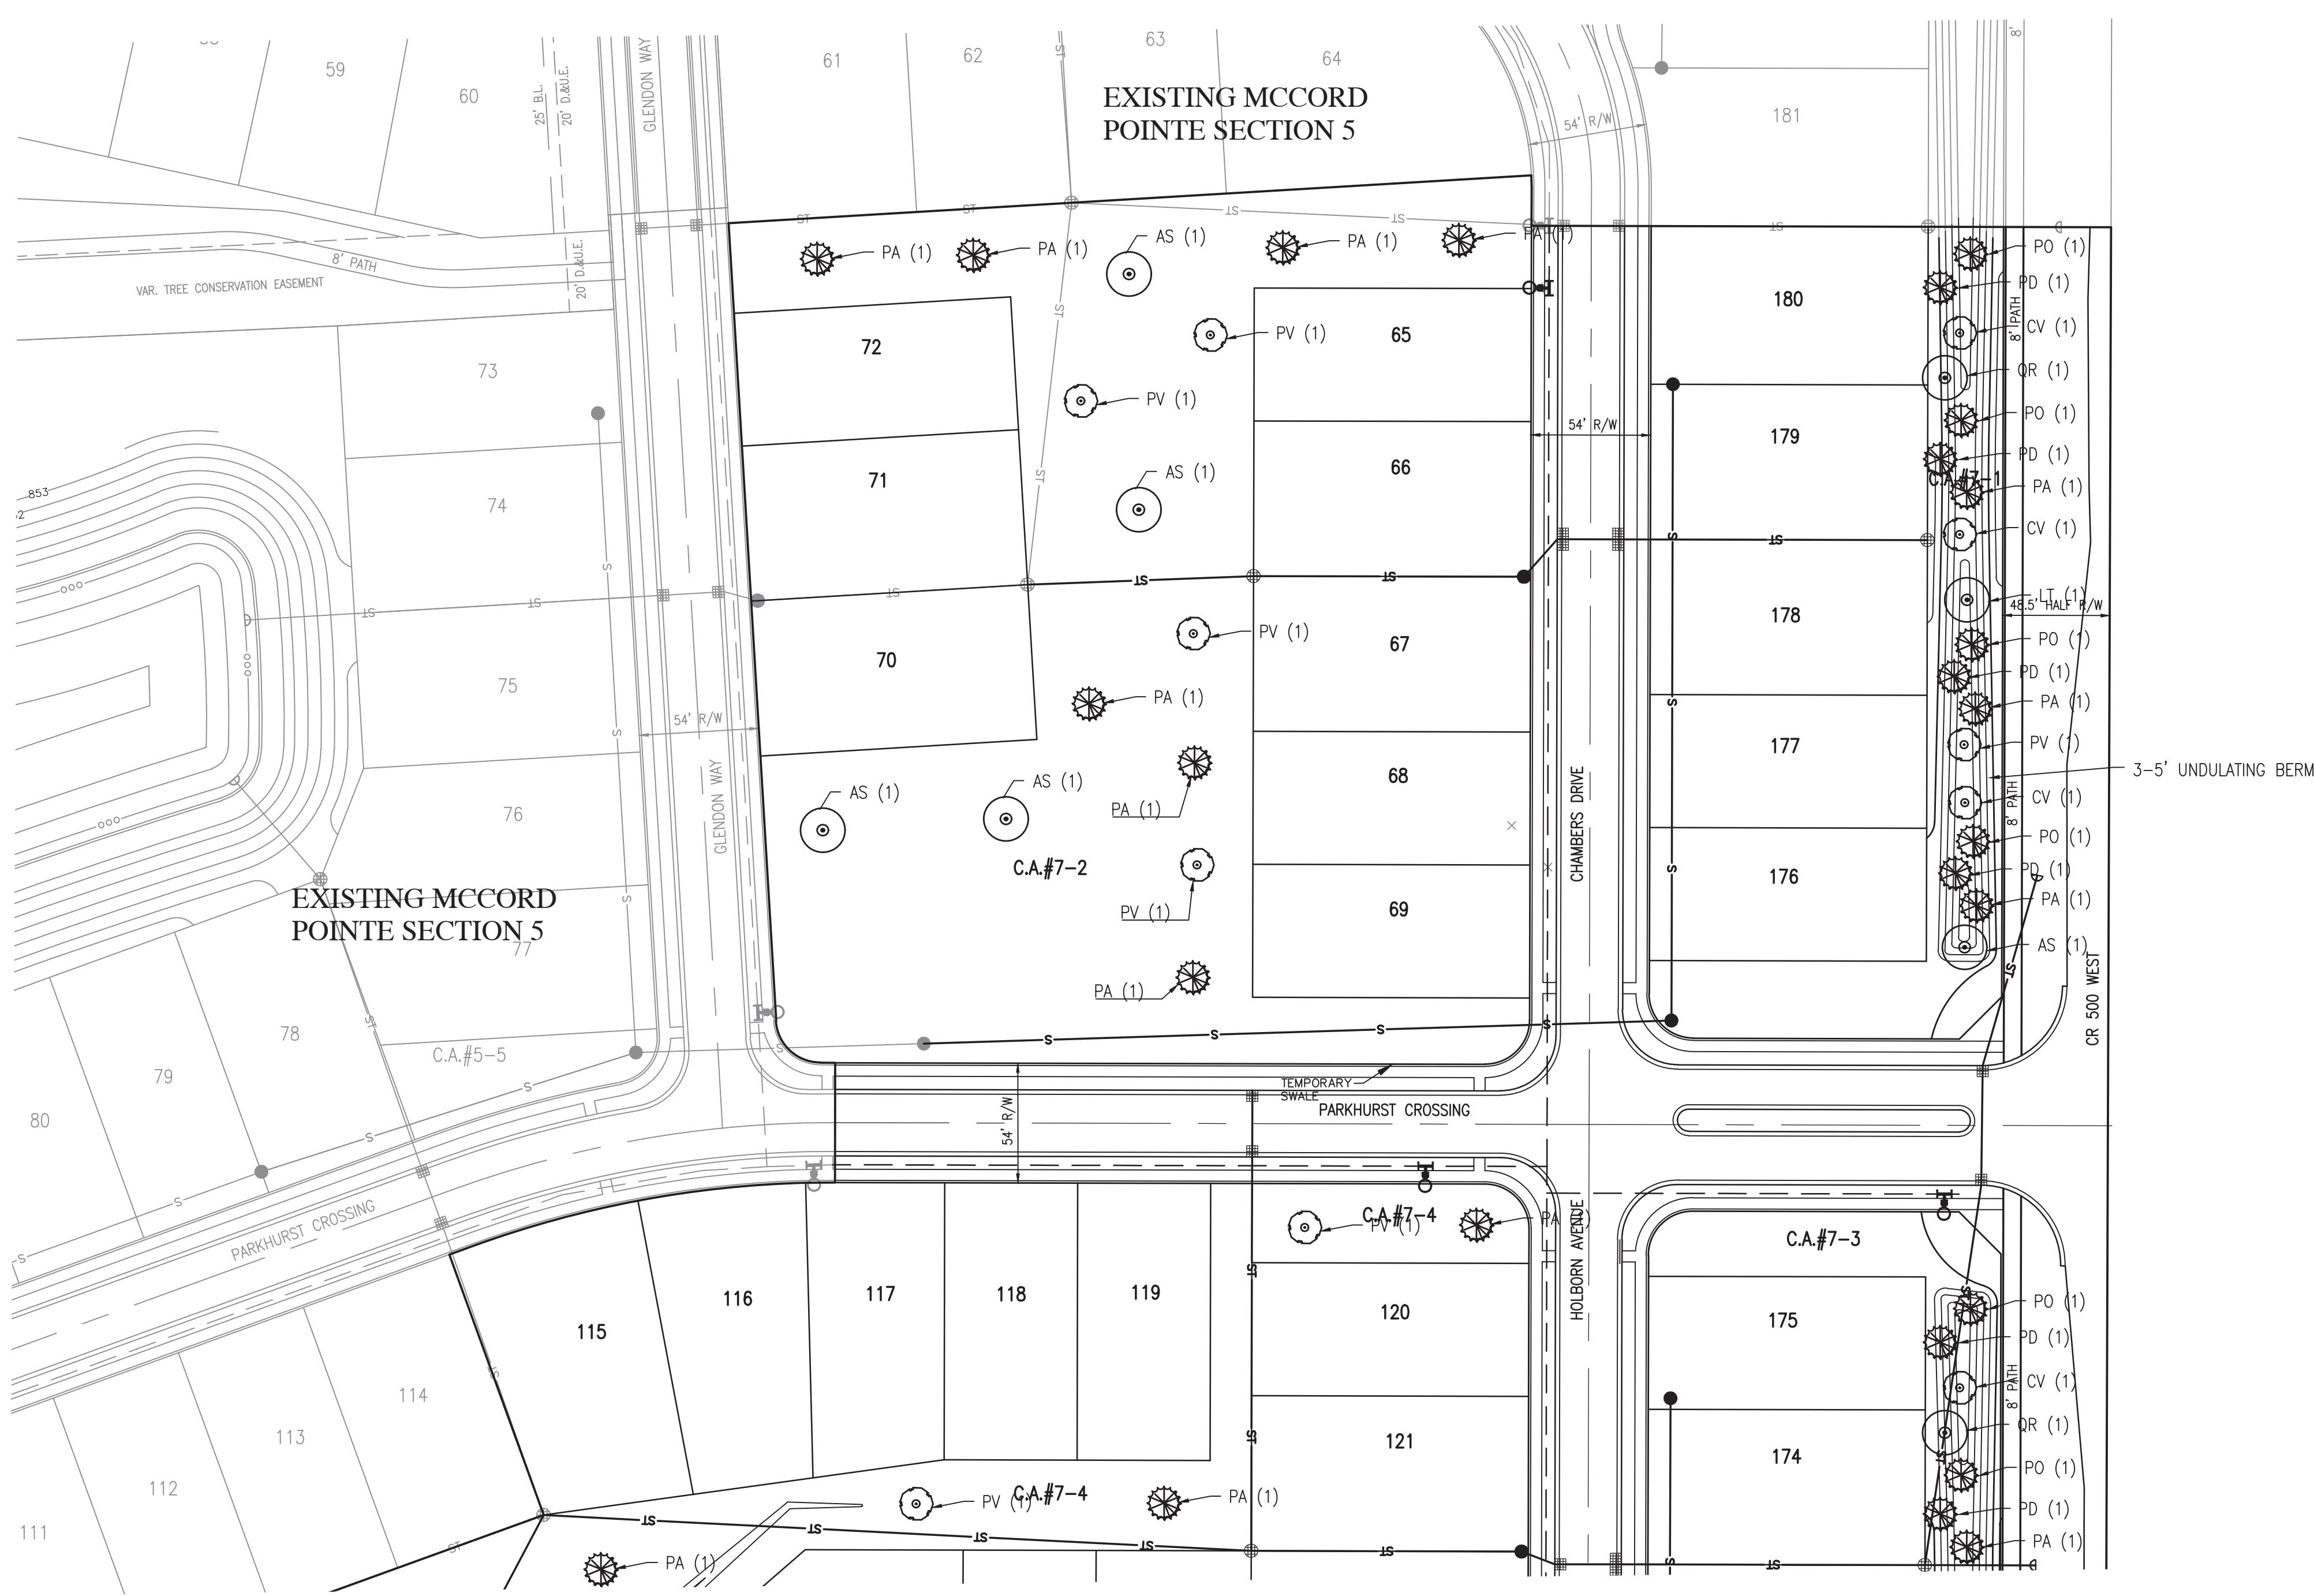

FOR CONTINUATION SEE SHEET L1.0

REVISIONS

DATE	DESCRIPTION	BY
1/5/21	REVISED PER TAC REVIEW	HWC

HWC
ENGINEERING


INDIANAPOLIS - TERRE HAUTE
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MCCORD POINTE MCCORDSVILLE, INDIANA

LANDSCAPE DETAILS

By: krichmon

L1.2

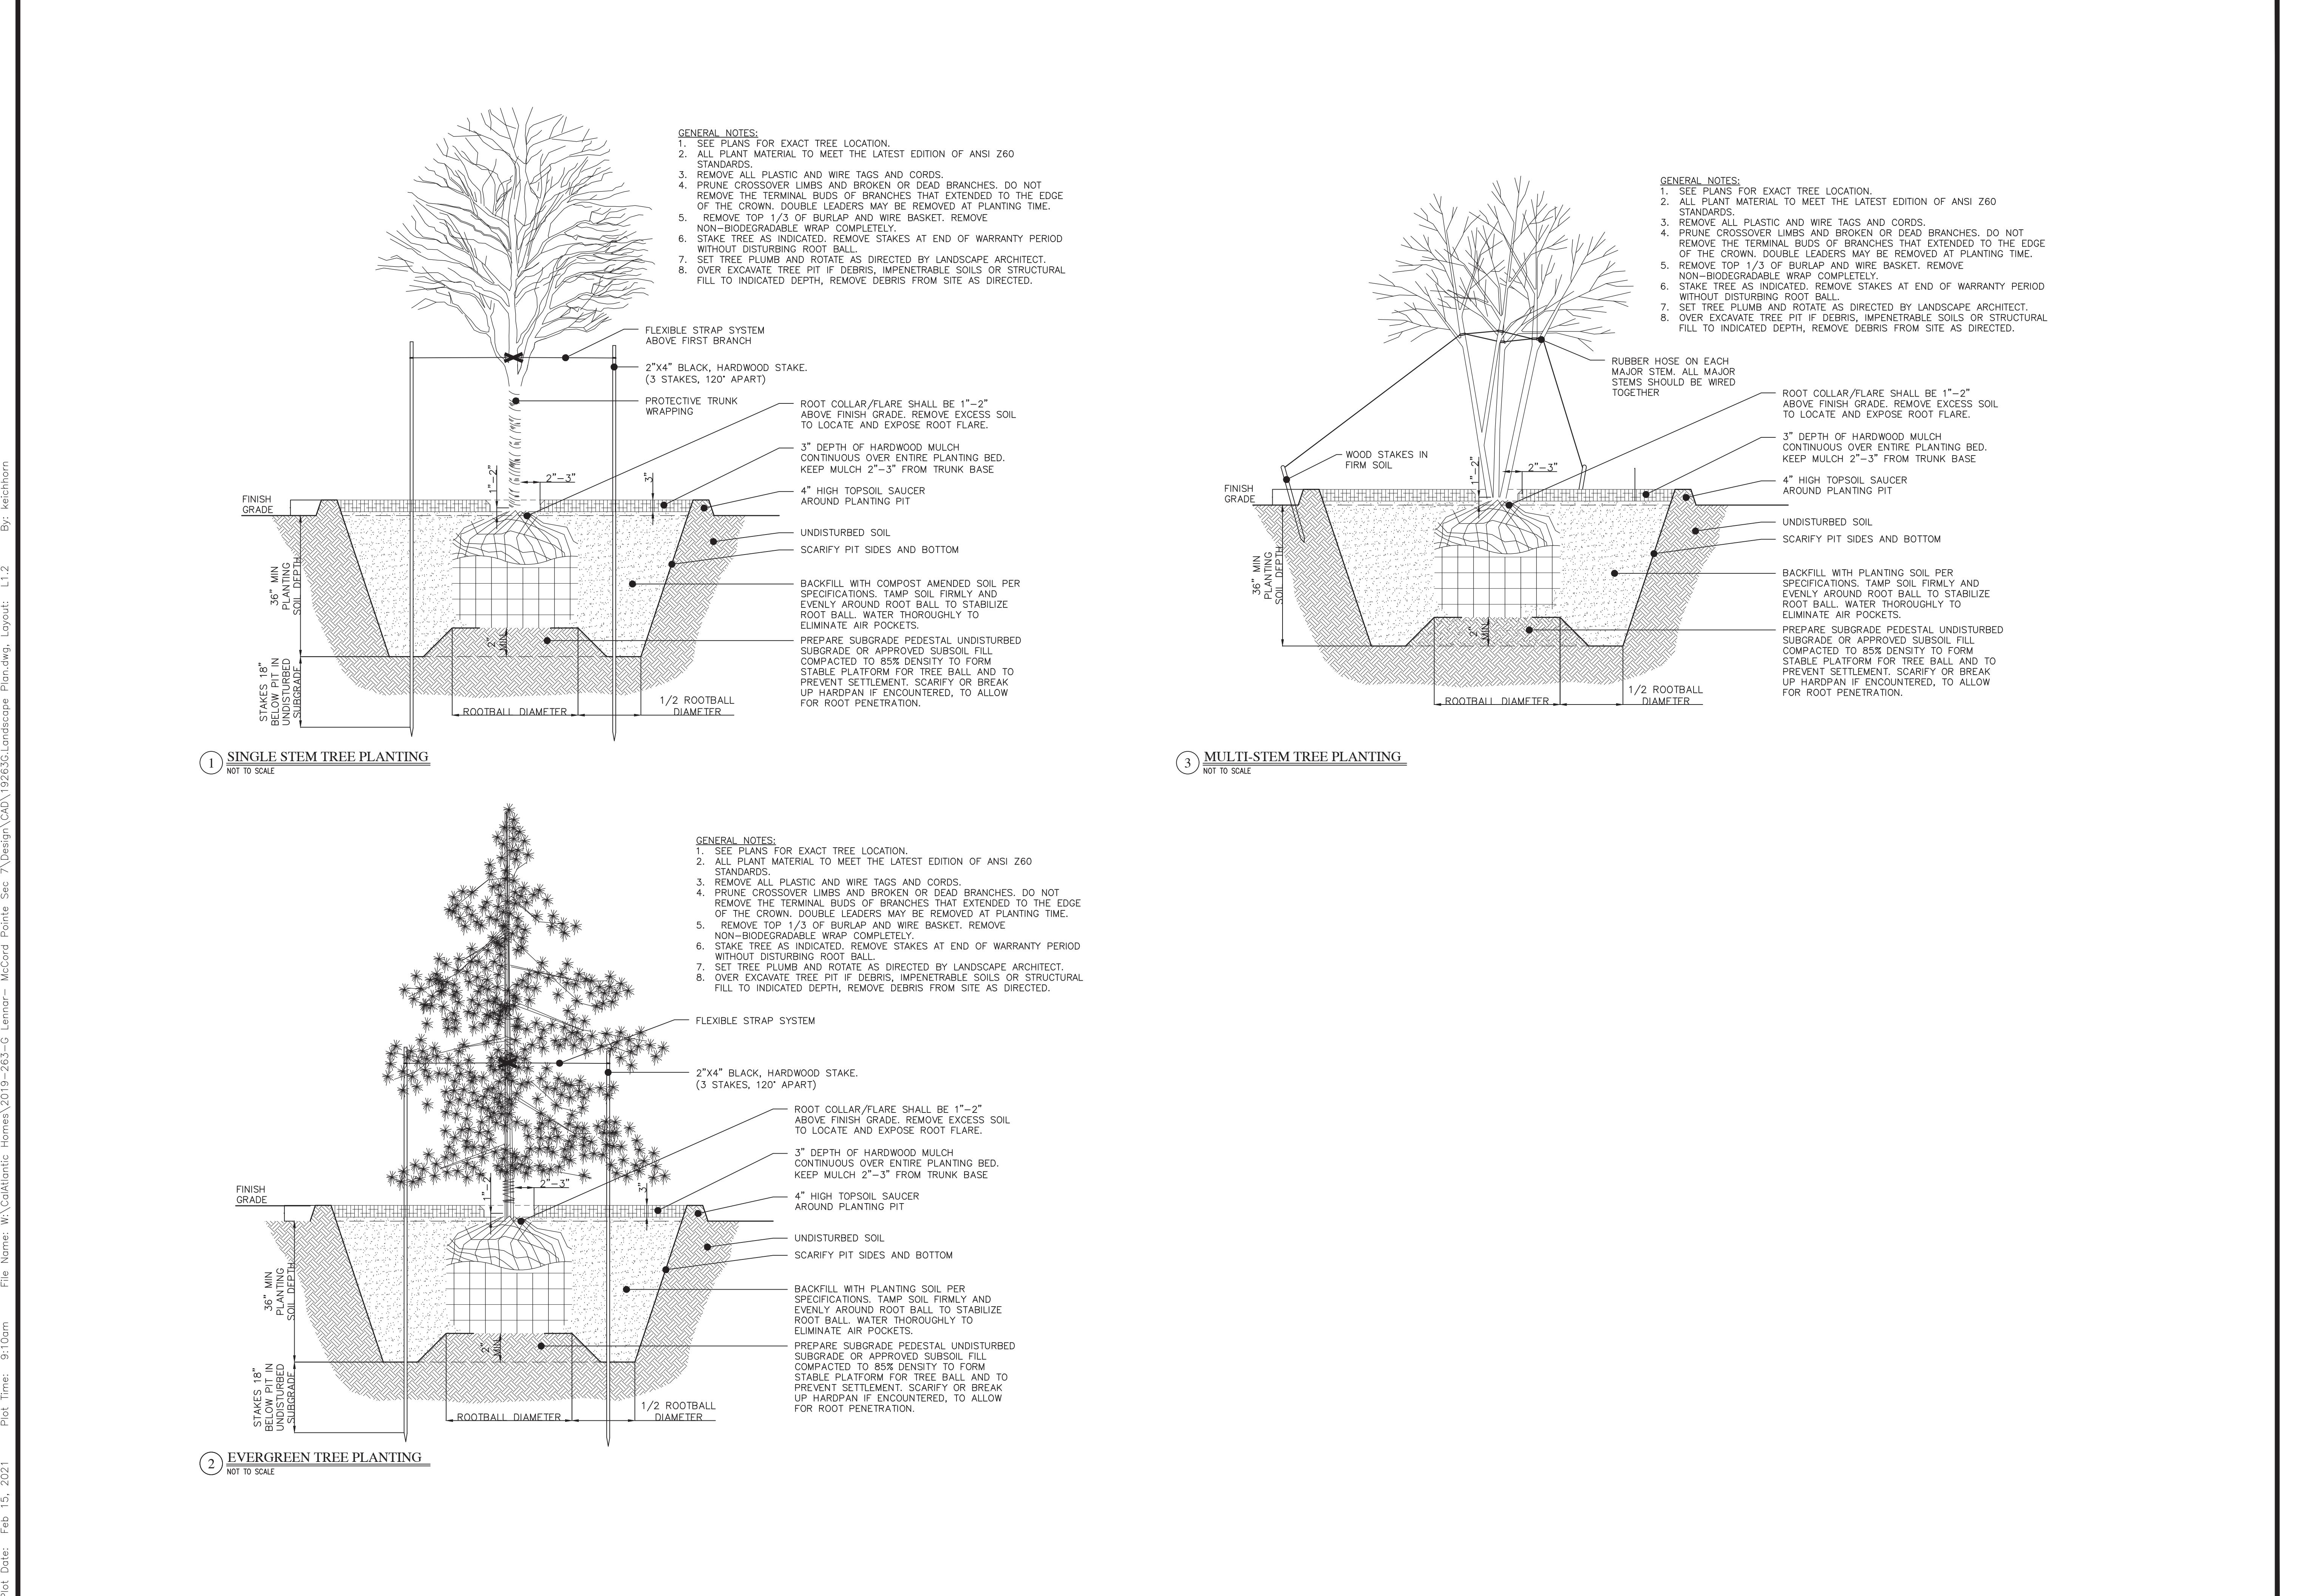

DRAWN BY TS/TD/GM	CHECKED BY KE
DATE NOVEMBER 2020	SCALE AS SHOWN
JOB NUMBER 2019-265-G	

L1.2
LANDSCAPE DETAILS

INDIANAPOLIS, INDIANA 46204
PHONE: (317) 347-3663

DEVELOPED BY:
LENNAR HOMES OF INDIANA, INC.
11555 N. MERIDIAN ST., SUITE 400
CARMEL, INDIANA 46032
PHONE: (317) 659-3200

Assumed North

SECONDARY PLACEMENT

OWN OF McCORDSVI

VERNON TOWNSHIP, LIANOCK COUNTY, INDIANA
ERT OF SECTION 13, TOWNSHIP 17 NORTH, RANGE 5 EAST)

FOR CONTINUATION SEE SHEET 4 OF (

SLIDES

SLIDE

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