


<b>SH.T.</b>	<b>DESCRIPTION</b>
1001	COVER SHEET
1002	TOPOGRAPHICAL SURVEY DEMOLITION PLAN
200C-203	LAND DEVELOPMENT PLAN EMERGENCY FLOOD ROUTING PLAN
300C-308	INITIAL STORM WATER POLLUTION & PREVENTION PLAN TEMPORARY STORM WATER POLLUTION & PREVENTION PLAN PERMANENT EROSION & EROSION CONTROL PLAN STORM WATER FOR UTILITIES & PROFESSIONAL OPERATIONS STORM WATER POLLUTION & PREVENTION DETAILS
400C-409	STREET PLAN & PROFILES INTERSECTION & INTERSECTION DETAILS TRAFFIC PLANS MAINTENANCE OF TRAFFIC PLAN
500C-503	SANITARY SEWER PLANS & PROFILE
600C-605	STORM SEWER PLANS & PROFILES SUBSURFACE ACT/DRAINAGE PLAN
700C-703	WATER PLAN WATER DETAILS
.1	LANDSCAPE PLAN

MCCORDSVILLE STANDARD SPECIFICATIONS	
SHT.	DESCRIPTION
1	DIRECTIONS FOR USE & GENERAL NOTES
2	RIGHT-OF-WAY SECTIONS & PAVEMENT SPECIFICATIONS
3	RIGHT-OF-WAY DETAILS
4	STANDARDS & UTILITY LOCATION GUIDELINES
5	DRIVEWAY & HANDICAP RAMP DETAILS
6	STORM SEWER STRUCTURE DETAILS
7	STORM SEWER BEDDING DETAILS AND GENERAL NOTES
8	SANITARY SEWER SPICES
9	SANITARY SEWER DETAILS
10	SANITARY SEWER LIFT STATION STANDARDS & GUIDELINES

REVISIONS	
SHT.	DESCRIPTION
ALL	REVISED PER TAC & CLIENT COMMENTS 05-22-20 KJJM
ALL	REVISED PER MCCORDSVILLE COMMENTS 06-12-20 KJJM

# PINE VAIL ESTATES

**Developed by:**  
**PREMIER LAND COMPANY, LLC.**  
**11691 FALL CREEK Road**  
**Suite 210**  
**Indianapolis, Indiana 46256**  
**Phone: (317) 501-9172**  
**Contact Person: Richard Henderson**

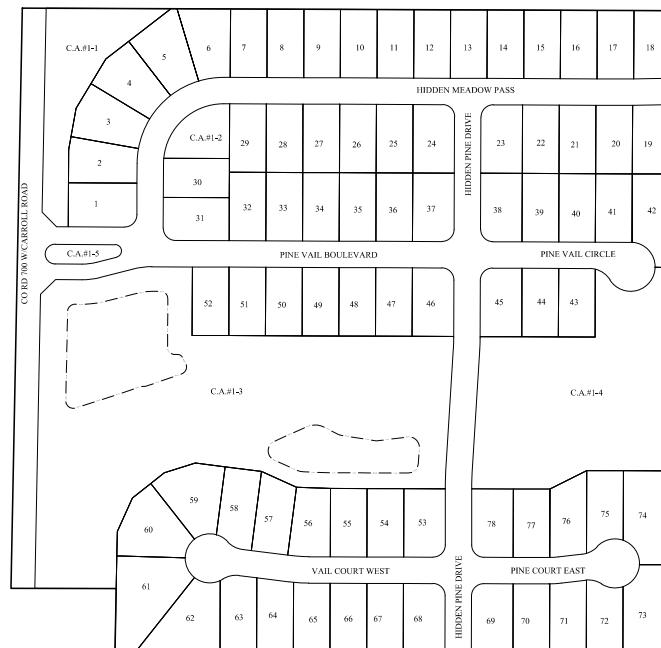


BIOLOGICAL

I, the undersigned Registered Land Surveyor hereby certify that the included plat correctly represents a subdivision a part of the Northwest Quarter of the Southwest Quarter of Section 23, Township 17 North, Range 05 East, Vernon Township,

Hancock County, Indiana manner particularly described as follows:

Begins at the South end of said Quarter Section; thence South 12 degrees 46 feet to 46 minutes 4 seconds East along the North line of said Quarter Section; a distance of 123.00 feet to the Northeast corner thereof; thence South 01 degree 07 minutes 35 seconds West, along the East line of said Quarter Section, a distance of 131.50 feet to the Southeast corner thereof; thence North 49 degrees 50 minutes 16 seconds West, along the South line of said Quarter Section, a distance of 120.00 feet to the Northwest corner thereof; thence North 01 degree 07 minutes 35 seconds South, along the East line of said subdivision, recorded as Instrument Number 865914 in Plat Cabinet A, Sheet 367 in the Office of the Hancock County Recorder; thence North 01 degree 07 minutes 11 seconds East, along the East line of said subdivision, a distance of 128.00 feet to the Northeast corner thereof; thence North 01 degree 07 minutes 35 seconds South, along the East line of said subdivision, a distance of 21.50 feet to the West line of said Quarter Section; thence North 01 degree 07 minutes 11 seconds East, along said West line, a distance of 184.74 feet to the Point of Beginning; containing .3956 acres, more or less.

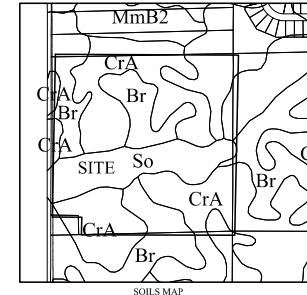

Map Unit Br - Brookston silty clay loam (N.T.S.)  
**B—Brookston silty clay loam**  
This poorly drained soil has a seasonal high water table above the surface or within 1.0 ft. and is in depressions. Slopes are to 2 percent. The native vegetation is water tolerant grasses and hardwoods. The surface layer is silty clay loam and has moderate or high organic matter content (2.0 to 5.0 percent). Permeability is moderately slow (0.2 to 0.6 in. per hour) in the most restrictive layer above 60 inches. Relatively water soluble salts are present in the upper 60 inches. The pH of the surface layer is nonacidic, ranging from 6.1 to 7.3. This soil is saline. Whereas it is a management concern for crop production, this soil responds well to tile drainage.

Map Unit CA - Crosby silty loam, 0 to 2 percent slopes  
**Crosby** - Crosby silty loam, 0 to 2 percent slopes  
This is a somewhat poorly drained soil and has a seasonal high water table at 0 to 2.0 ft. and is on ridges or slopes. Slopes are 0 to 2 percent. The native vegetation is hardwoods. The surface layer is silty loam and has moderately low or moderate organic matter content (1.0 to 3.0 percent). Permeability is very slow (~1.0 in/h) in the most restrictive layer above 60 inches. Available water capacity is moderate and reaches in the upper 60 inches. The pH of the surface layer in non-tiled areas is 5.1 to 6.0. Droughtresistance and water management are concern for crop production. This soil responds well to tile drainage.

This coarse, very deep and very poorly drained soil is on floodplains. It is subject to frequent flooding. The mapped areas are mostly elongated and are parallel to streams. Many areas are in narrow valleys along small streams. The mapped areas range in size from 3 to 100 acres in size. In a typical profile the surface layer is dark grayish brown silt loam about 11 inches thick. The underlying layer is a light grayish brown silty clay loam about 10 inches thick. Below this is a silty clay loam. Below this to a depth of 34 inches, it is gray and very dark gray clay loam. Below this, to a depth of 60 inches, it is a grayish brown fine gravel and coarse sand. In small areas scattered throughout the area, there are thin layers of fine gravel. In some areas where the water table is high, the water places the underlying material has more gravel. This soil has carbonates throughout the profile in some areas.

DESIGN DATA	
78 LOTS	
39.56 AC.	= 1.97 LOTS/ACRE
PINE VAIL BOULEVARD	919.48 L.F.
PINE VAIL CIRCLE	356.89 L.F.
HIDDEN MEADOW PASS	1,338.24 L.F.
HIDDEN PINE DRIVE	1,146.89 L.F.
VAIL COURT WEST	509.96 L.F.
VAIL COURT EAST	320.90 L.F.

MC CORD POINTE LOT INDEX		COMMON AREA INDEX	
TOTAL	78	C.A./#1-L	42,051 sq. ft.
		C.A./#1-T	11,875 sq. ft.
		C.A./#1-B	326,991 sq. ft.
		C.A./#1-L	131,424 sq. ft.
		C.A./#1-S	5,439 sq. ft.
		TOTALS	
			517,780 sq. ft.
			11,887 Ac.


PLANS PREPARED BY:  
STOEPPELWERTH & ASSOCIATES, INC.  
CONSULTING ENGINEERS & LAND SURVEYORS  
7965 E. 106TH STREET, FISHERS, INDIANA 46038  
PHONE: (317)-849-5935  
FAX: (317)-849-5942  
CONTACT PERSON: BRIAN K. ROBINSON  
EMAIL: [brobinson@stoeppelwerth.com](mailto:brobinson@stoeppelwerth.com)


**PLANS CERTIFIED BY**

*David J. Stoeppelwerth* 04/24/20  
DAVID J. STOEPPELWERTH, P.E. DATE  
PROFESSIONAL ENGINEER  
NO. 19358





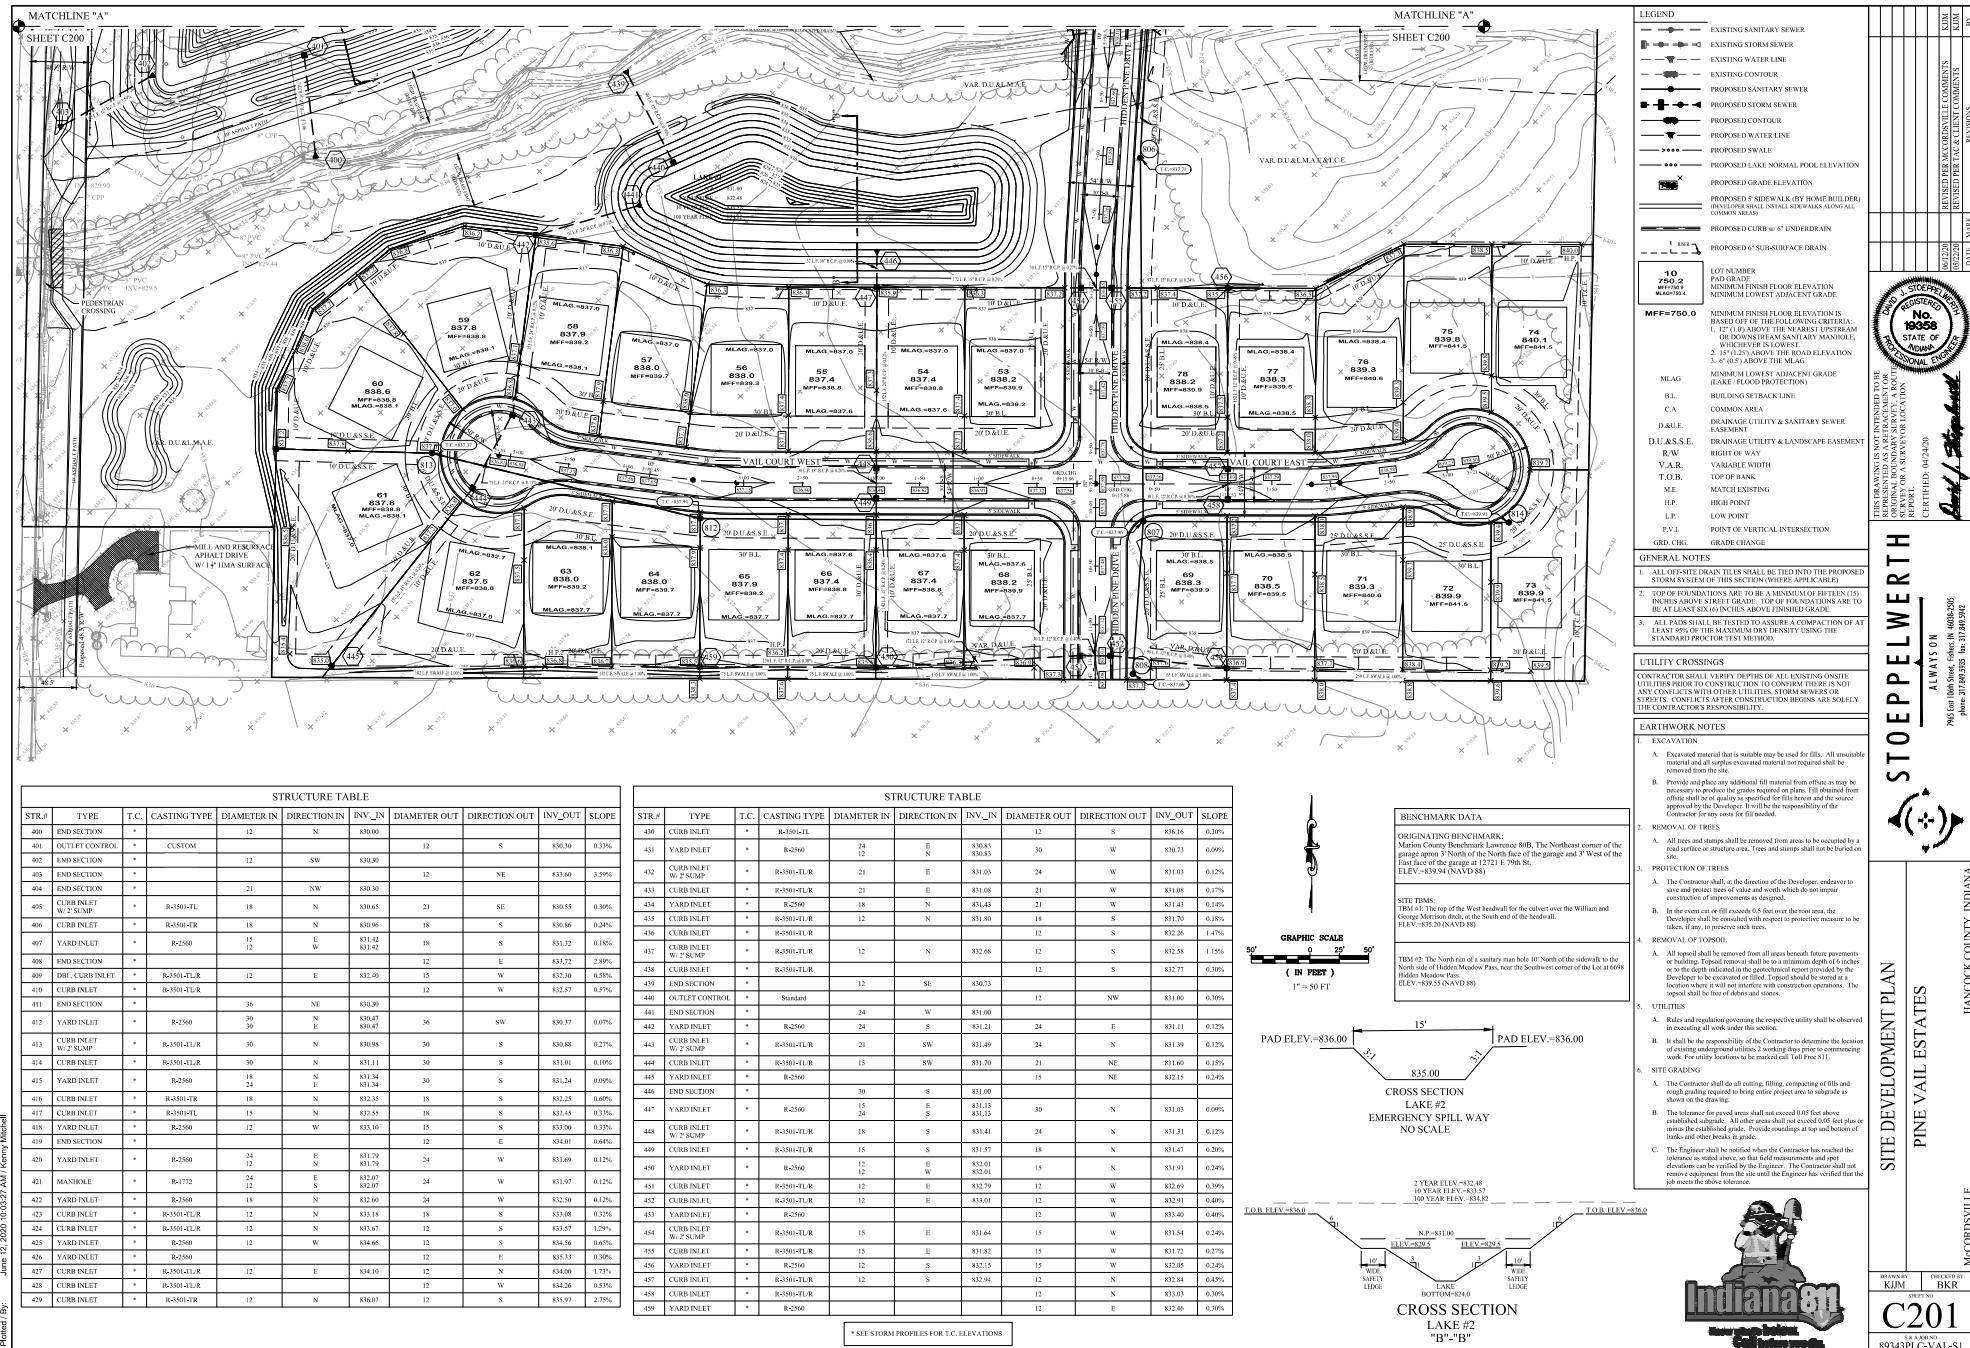

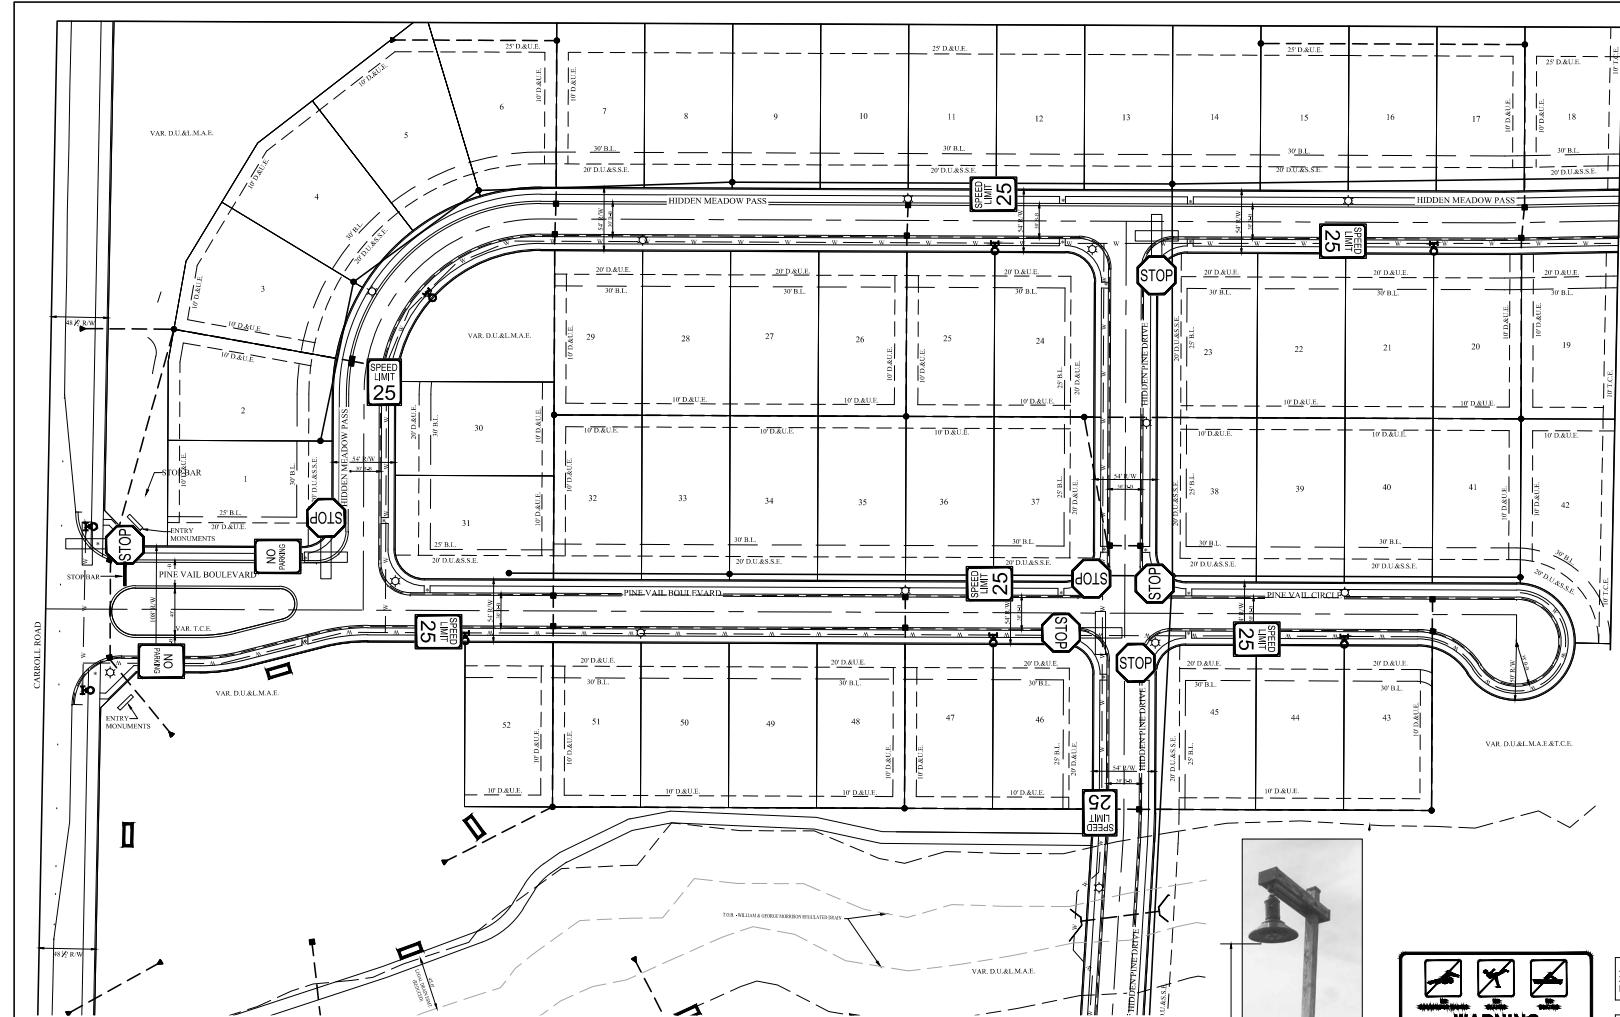

## STOEPPELWERTH

### TRAFFIC CONTROL PLAN

PINE VALLEY ESTATES  
HANCOCK COUNTY, INDIANA

DRAWN BY KJM		CHECKED BY BKR
SHEET NO. C406		
8 1/2" X 11" FORM 89343PL-C-VAL-S1		
MC CORDSVILLE Know where below Call before you dig.		
REVISED PER MCCORDSVILLE COMMENTS KJM 06/12/20 REVISED PER TAC & CBL COMMENTS KJM 05/29/20 REVISIONS BKR		
J. STOEPPELWERTH REGISTERED 19358 STATE OF INDIANA PROFESSIONAL ENGINEER CERTIFIED: 04/2/20 DRAFT MARK <i>[Signature]</i>		
THIS DRAWING IS NOT INTENDED TO BE REPRESENTED AS A ATTACHMENT FOR SURVEYOR'S SURVEY OF LOCATION REPORT: 04/2/20		
PHONE: (812) 463-5055 FAX: (812) 463-5842 EMAIL: jstoeppelw@msn.com		




ALL TRAFFIC CONTROL SIGNS SHALL MEET CHAPTER  
2D: GUIDE SIGN CONVENTIONAL ROADS OF THE  
MUTCD MANUAL LATEST EDITION.

ALL STREET AND TRAFFIC SIGNS SHALL UTILIZE THE  
TOWN'S STANDARD POLE.  
SEE TOWN'S SPECIFICATIONS


ALL STREET LIGHTS SHALL MEET THE TOWN OF  
MC CORDSVILLE AND SUBDIVISION CONTROL  
ORDINANCE.



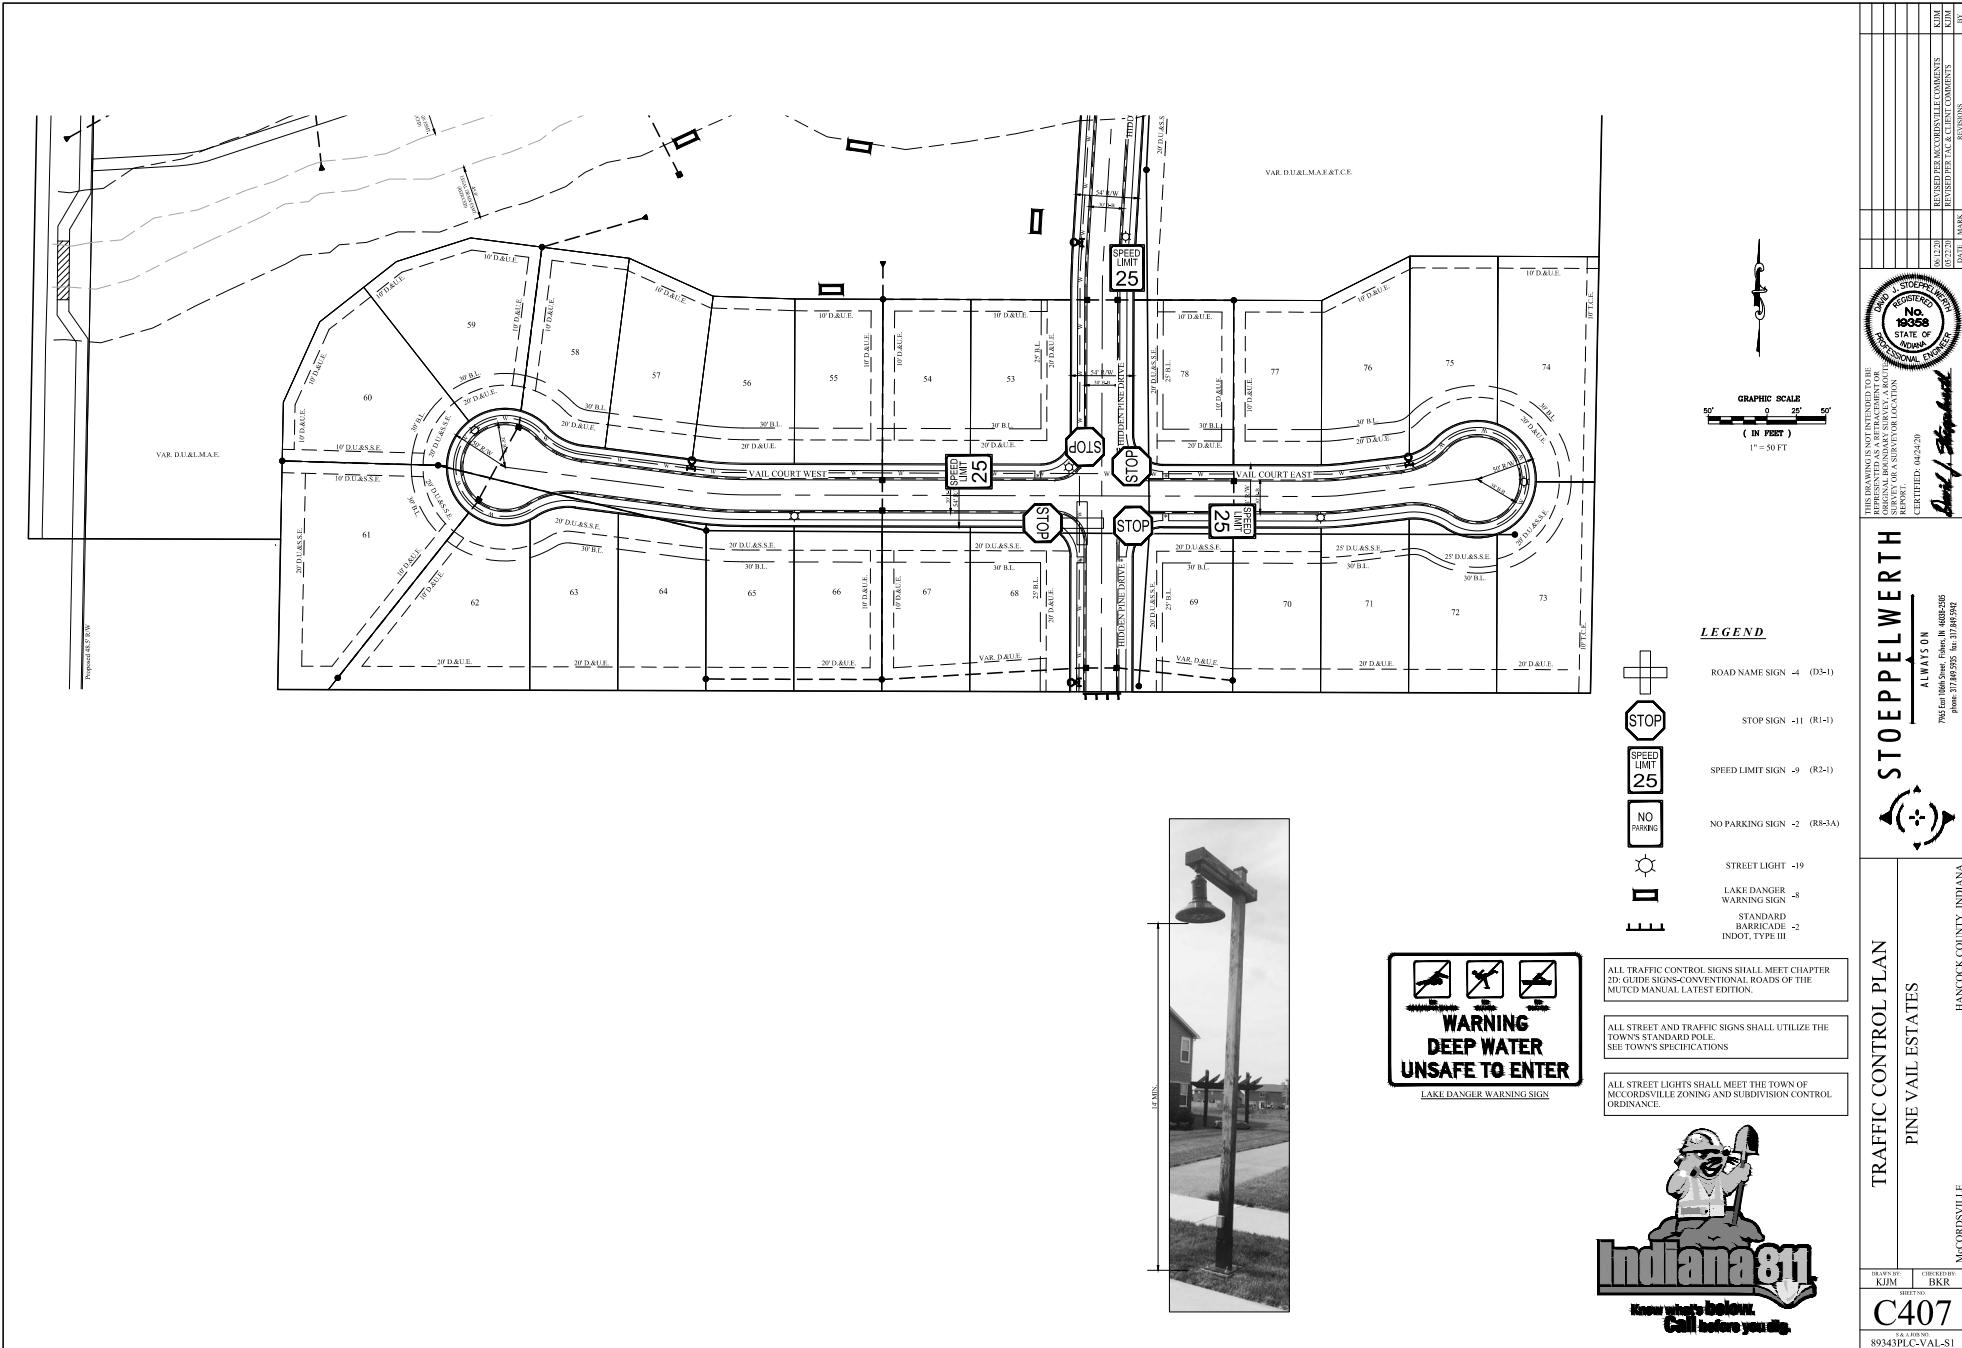



**TREE PLANTING DETAIL**  
NOT TO SCALE

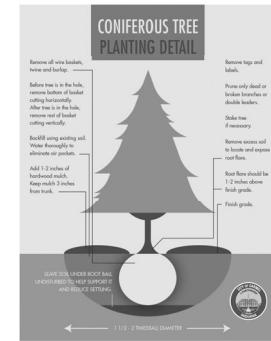

**EVERGREEN PLANTING DETAIL**  
NOT TO SCALE

LANDSCAPE ORNAMENT REQUIREMENTS		REQUIRED	PROVIDED
LANDSCAPE DIFFERENTIATOR	AS PLANNED	1 UNIT	0 UNITS
1 BUSHY/SPRAY GROWTH FORM ORNAMENT	AS PLANNED	04 TREES	04 TREES
1 CROWN REACHING 12'-15' IN DIA. OR HIGHER	AS PLANNED	02 TREES	02 TREES
1 CROWN REACHING 12'-15' IN DIA. OR HIGHER	AS PLANNED	02 TREES	02 TREES
1 BUSHY/SPRAY GROWTH FORM ORNAMENT	AS PLANNED	02 TREES	02 TREES
INTERIOR TREES	REQUIRED	0 TREES	0 TREES
INTERIOR TREES AS SHOWN ON PLAN	REQUIRED	0 TREES	0 TREES

PLANT LISTING - PERIMETER BUFFER PLANT LIST	
1. COTONEASTER	AS PLANNED
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SCALE: 1" = 60'-0"  
0 60' 90' 120'  
N



**Start to Finish**  
LANDSCAPING  
3375 South 500 East  
Whitehouse, IN 46075  
p: (812) 423-0200  
e: starttfinish@outlook.com  
w: starttfinishlandscaping.com

PREMIER LAND COMPANY  
5004 TECHNOLOGY DRIVE  
FISHERS, IN 46038

PROJECT NAME  
VAIL PROPERTY  
MCORDSVILLE, IN

SHEET NAME  
LANDSCAPE PLAN

DESIGNER CLA  
DATE JANUARY 10, 2020  
REVISED DATE JUNE 12, 2020  
RECORDED DATE JUNE 12, 2020

SHEET 1